PRELIMINARY LAND DEVELOPMENT SUBMISSION FOR CHURCH WALK AND BRIDGE




Villanova University

SITUATED IN RADNOR TOWNSHIP, DELAWARE COUNTY, PENNSYLVANIA

PLAN INDEX

RELATION	<u>NO.</u>	DESCRIPTION	START DATE	REVISION DATE
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3 OF 20	C2.0	COMPOSITE SITE PLAN	MARCH 13, 2015	
4 OF 20	C2.1	SITE PLAN	MARCH 13, 2015	
5 OF 20	C3.1	GRADING PLAN	MARCH 13, 2015	
6 OF 20	C4.1	UTILITY PLAN	MARCH 13, 2015	
7 OF 20	C4.2	UTILITY PROFILES	***	
8 OF 20	C5.1	EROSION & SEDIMENTATION CONTROL PLAN	MARCH 13, 2015	
9 OF 20	C5.2	EROSION & SEDIMENTATION CONTROL DETAIL SHEET	MARCH 13, 2015	
10 OF 20	C5.3	EROSION & SEDIMENTATION CONTROL DETAIL SHEET	MARCH 13, 2015	
11 OF 20	C6.1	CONSTRUCTION DETAIL SHEET	MARCH 13, 2015	
12 OF 20	C6.2	CONSTRUCTION DETAIL SHEET	MARCH 13, 2015	
13 OF 20	C7.1	SITE LIGHTING PLAN	MARCH 13, 2015	
14 OF 20	C7.2	SITE LIGHTING PLAN	MARCH 13, 2015	the second second
15 OF 20	C7.3	SITE LIGHTING DETAILS	MARCH 13, 2015	
16 OF 20	L1.0	PLANTING PLAN	MARCH 13, 2015	
17 OF 20	L1.1	PLANTING PLAN AT ALDWYN TRIANGLE	MARCH 13, 2015	
18 OF 20	L2.0	PLANTING SCHEDULE AND TABULATIONS	MARCH 13, 2015	
19 OF 20	L2.1	LANDSCAPE DETAILS	MARCH 13, 2015	
20 OF 20	L2.2	LANDSCAPE DETAILS	MARCH 13, 2015	

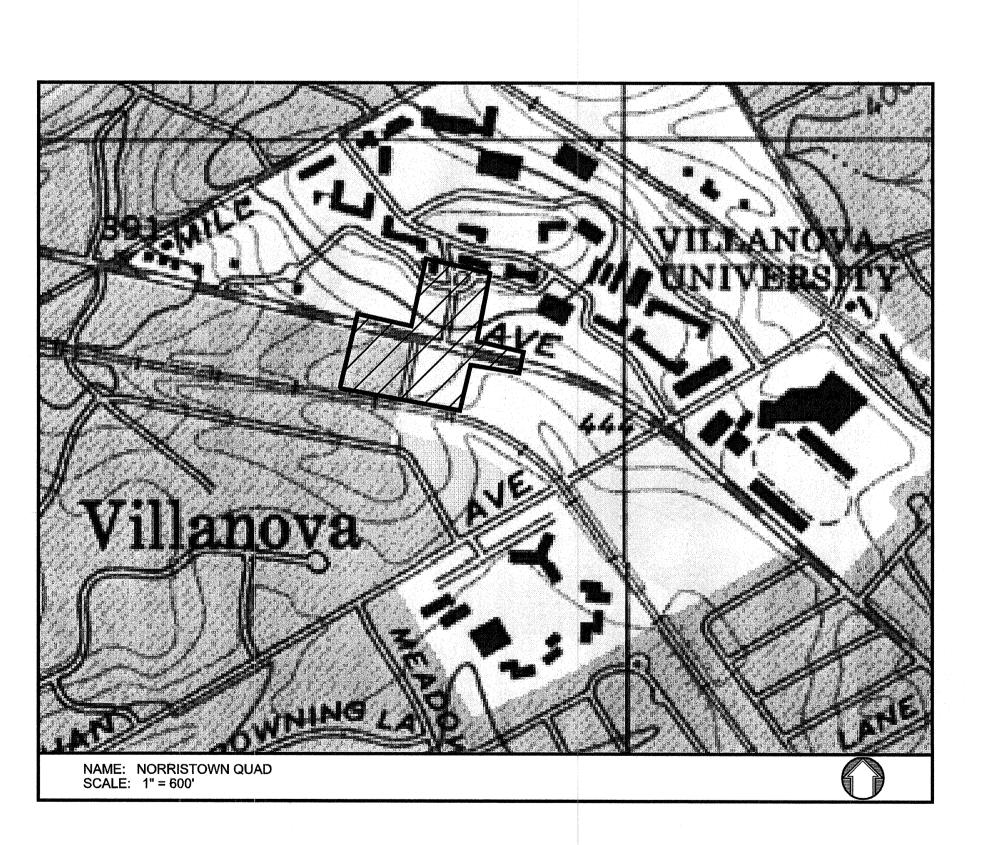

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OWNER / APPLICANT

VILLANOVA UNIVERSITY 800 E LANCASTER AVE VILLANOVA, PA 19085 610-519-4500

CERTIFICATE OF OWNERSHIP
AND ACKNOWLEDGEMENT OF PLAN

ON THIS, THE ______DAY OF ______, 20 ____, BEFORE ME, UNDERSIGNED OFFICER, PERSONALLY APPEARED _____

(NAME OF OWNER)
WHO BEING DULY SWORN ACCORDING TO LAW, DEPOSES AND SAYS THAT HE/SHE IS THE OWNER AND/OR EQUITABLE OWNER OF THE PROPERTY SHOWN ON THIS PLAN, AND THAT HE/SHE ACKNOWLEDGES THE SAME TO BE HIS/HER ACT AND PLAN AND DESIRES THE SAME BE RECORDED AS SUCH ACCORDING TO LAW.

WITNESS MY HAND AND SEAL THE DAY AND DATE ABOVE WRITTEN.

MY COMMISSION EXPIRES:

(NOTARY PUBLIC OR OTHER OFFICER)

Villanova University

Church Walk and Bridge
Lancaster and Ithan Avenues
Villanova PA 19085

VMA RAMSA

ARCHITECT-OF-RECORD

Voith & Mactavish Architects LLP

2401 Walnut Street, 6th Floor

Philadelphia, PA 19103

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Nave Newell Inc.

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Wayne, PA 19087

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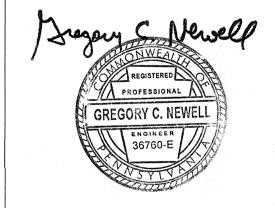
www.navenewell.com

STRUCTURAL ENGINEER - PARKING
PLANNING AND DESIGN
The Harman Group, Inc.
900 West Valley Forge Road, Suite 200
King of Prussia, PA 19406
phone: 610-337-3360 x 118 voice
mobile phone: 610-334-0974
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www.HarmanGroup.com

MEP&FP ENGINEER
Bala Consulting Engineers, Inc.
443 South Gulph Road
King of Prussia, PA 19406
phone: 610-649-8000
fax: 910-649-8475

LANDSCAPE ARCHITECT
Sikora Wells Appel
8 Kings Hwy West, Suite A
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www.sikora-wa.com

ELEVATOR CONSULTANT
Zipf Associates Inc.
25 Bala Avenue, Suite 201
Bala Cynwyd, PA 19004
phone: 610-667-1717
fax:610-667-0216



PRELIM. LAND DEVELOPMENT SUBMISSION

Revision

Date March 13, 2015


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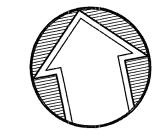
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EXISTING BUILDING

EXISTING TREE

EXISTING RAILROAD TRACKS

EXISTING MAJOR CONTOUR

- EXISTING WALER SERVICE WITH MANHOLE
EXISTING WATER VALVE
EXISTING FIRE HYDRANT
EXISTING GAS VALVE
EXISTING UTILITY POLE WITH GUY WIRE
- EXISTING OVERHEAD WIRE
- EXISTING UNDERGROUND ELECTRIC SERVICE WITH MANHOLE
EXISTING ELECTRIC METER
EXISTING TRANSFORMER
- EXISTING CARLE SERVICE WITH CARLE ROY

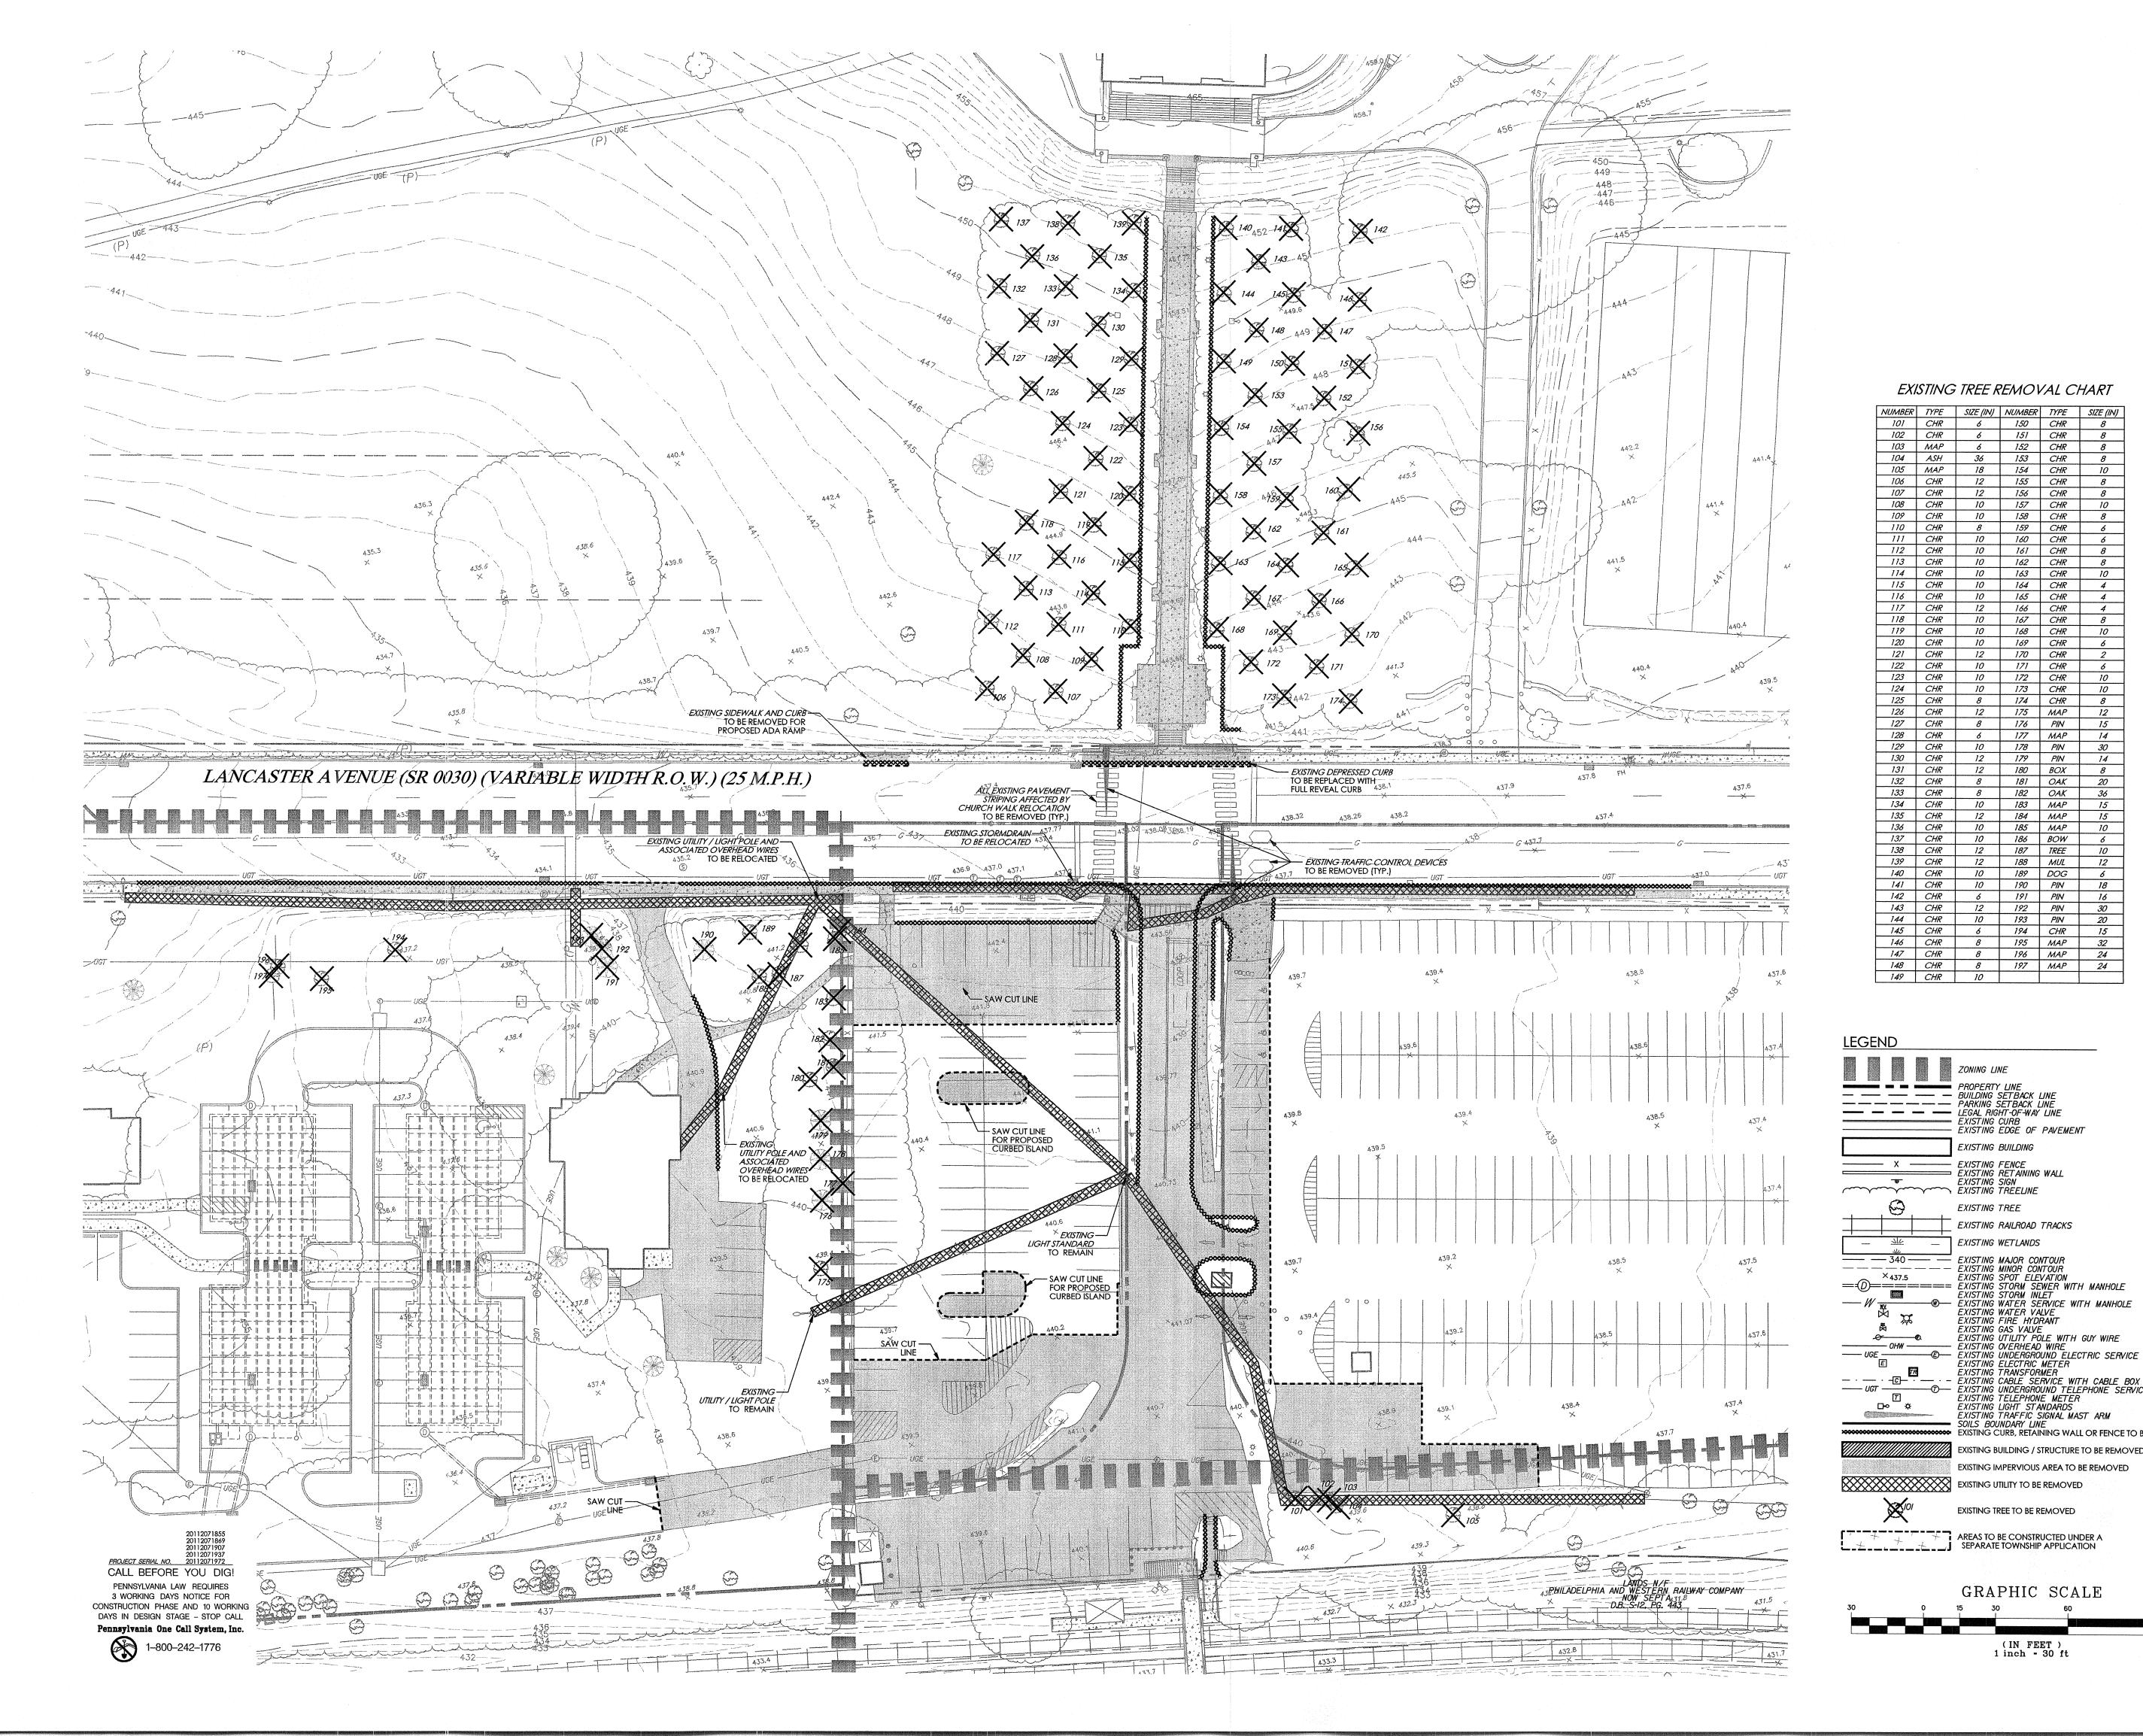EXISTING TRANSFORMER
- EXISTING CABLE SERVICE WITH CABLE BOX
- EXISTING UNDERGROUND TELEPHONE SERVICE WITH MANHOLE EXISTING TELEPHONE METER
EXISTING LIGHT STANDARDS
EXISTING TRAFFIC SIGNAL MAST ARM
- SOILS BOUNDARY LINE
- EXISTING CURB, RETAINING WALL OR FENCE TO BE REMOVED

EXISTING BUILDING / STRUCTURE TO BE REMOVED

EXISTING IMPERVIOUS AREA TO BE REMOVED

EXISTING TREE TO BE REMOVED

SEPARATE TOWNSHIP APPLICATION

GRAPHIC SCALE

(IN FEET)
1 inch = 30 ft

Villanova University Church Walk and Bridge Lancaster and Ithan Avenues Villanova PA 19085

VMA **RAMSA**

ARCHITECT-OF-RECORD

Voith & Mactavish Architects LLP 2401 Walnut Street, 6th Floor Philadelphia, PA 19103 phone: 215-545-4544 fax: 215-545-3299 www.voithandmactavish.com **DESIGN ARCHITECT** Robert A.M. Stern Architects LLP 460 West 34th Street New York, New York 10001

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Nave Newell Inc. 900 West Valley Road, Suite 1100 Wayne, PA 19087 phone: 610-265-8323 fax: 610-265-4299 www.navenewell.com

STRUCTURAL ENGINEER - PARKING PLANNING AND DESIGN The Harman Group, Inc. 900 West Valley Forge Road, Suite 200 King of Prussia, PA 19406 phone: 610-337-3360 x 118 voice mobile phone: 610-334-0974 fax: 610-337-3359 www.HarmanGroup.com

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www.sikora-wa.com

ELEVATOR CONSULTANT Zipf Associates Inc. 25 Bala Avenue, Suite 201 Bala Cynwyd, PA 19004 phone: 610-667-1717 fax:610-667-0216



PRELIM. LAND DEVELOPMENT SUBMISSION

Revision

March 13, 2015 Existing Features / Demolition Plan

Scale Drawn By DCH

Sheet No.

2 of 20

CAMPUS-WIDE ZONING DATA

PLANNED INSTITUTIONAL DISTRICT (PI)

CLASSIFICATION: REQUIRED EXISTING PROPOSED:

BUILDING AREA 30% MAX. 13.0% (29.26 ACRES) (a) 14.3% (32.25 ACRES) (b) TOTAL IMPERVIOUS COVERAGE 45% MAX. 37.6% (84.60 ACRES) (g) 36.4% (81.85 ACRES) (c)

a. DATA OBTAINED FROM LAST CAMPUS DEVELOPMENT APPROVAL SHOWN ON A PLAN ENTITLED "VILLANOVA UNIVERSITY WEST CAMPUS, PROPOSED SOCCER FIELD RECONSTRUCTION", PLAN DATED OCTOBER 4, 2013, LAST REVISED MAY 6, 2014, PREPARED BY ASSOCIATED ENGINEERING CONSULTANTS INCORPORATED (AEC).

DORMITORY BUILDING 1 DORMITORY BUILDING 2 PERFORMING ARTS CENTER +0.77 ACRES 2.99 ACRES (PROPOSED BUILDING AREA)

EXISTING BUILDING AREA 29.26 ACRES PROPOSED BUUILDING AREA +2.99 ACRES EXISTING IMPERVIOUS 84.60 ACRES CICD REDUCTION -2.65 ACRES BRIDGE & VISITOR LOT REDUX <u>-0.10 ACRES</u> 81.85 ACRES

CAMPUS PARKING ANALYSIS

EXISTING REQUIRED PARKING SPACES

AREA USE DESCRIPTION	AREA USE QUANTITY	REQUIRED PARKIN
DORMITORY	4,322 BEDS	1,441
OFFICE (NET SF)	365,851 SF	1,303
RETAIL	6,250 SF (6)	44
RESTAURANT	•••	
LARGEST ASSEMBLY AREA	3,778 FIXED SEATS	945
GYMNASIUM / LIBRARY	42,432 SF	283
LARGEST ASSEMBLY AREA	13,722 SF	344
UNSPECIFIED AREA	30,929 SF	104
	TOTAL SPACES	4,464 SPACES
	PARKING AVAILABILITY	5,130 SPACES
	SHERRING	666 SPACES

PROPOSED REQUIRED PARKING SPACES

THO TOOLD REQUIRED TY	111111111111111111111111111111111111111	
AREA USE DESCRIPTION	AREA USE QUANTITY	REQUIRED PARKING
DORMITORY	5,460 BEDS (1)	1,820
OFFICE (NET SF)	368,091 SF (2)	1,311
RETAIL	12,371 SF (3)	76
RESTAURANT	85 SEATS (4)	39
LARGEST ASSEMBLY AREA	4,178 FIXED SEATS (5)	1,045
GYMNASIUM / LIBRARY	42,432 SF	283
LARGEST ASSEMBLY AREA	13,722 SF	344
UNSPECIFIED AREA	37,179 SF (6)	124
	TOTAL SPACES	5,042 SPACES
	PARKING AVAILABILITY	5,130 SPACES
	SURPLUS	88 SPACES

PROPOSED PARKING TABULATION

AREA USE DESCRIPTION		EXISTING	PROPOSED
MAIN LOT		1,126	62
PIKE LOT		577	1,289
VISITOR LOT		80	48
W. LANCASTER LOT		79	240
ST. AUGUSTINES CENTER		271	494
UNAFFECTED CAMPUS SPACES		2997	2997
	TOTAL	5,130 SPACES	5,130 SPACES

(1) 1,138 BEDS PROPOSED WITHIN DORMITORIES 1A-2C 2) 2,240 SF OFFICE PROPOSED WITHIN THE PERF. ARTS CENTER 3) 9,369 SF BOOKSTORE, 2,877 SF CONVENIENCE STORE, 125 SF RETAIL WITHIN THE PERFORMING ARTS CENTER & 27 EMPLOYEES (4) 85 SEATS & 20 EMPLOYEES WITHIN PROPOSED BISTRO (5) 400 SEAT THEATER WITHIN THE PERF. ARTS CENTER (6) CONVERSION OF EXISTING BOOKSTORE TO UNSPECIFIED AREA

ZONING DATA

COMPREHENSIVE INTEGRATED COLLEGE DEVELOPMENT DISTRICT (CICD)

COMPREHENSIVE INTEGRATED COLLEGE DEVELOPMENT DISTRICT (CICD)		Secretary Benefits
CLASSIFICATION:	REQUIRED	PROPOSED
MINIMUM CAMPUS AREA	75 AC:RES	225 ACRES (PI ZONING DISTRICT) 15 ACRES (CO ZONING DISTRICT) 240 ACRES (TOTAL CAMPUS)
MINIMUM/MAXIMUM CICD AREA	>10 / <15 ACRES	13.81 GROSS ACRES 11.71 NET ACRES
MAXIMUM BUILDING LENGTH	180'	1 <i>7</i> 1'
MINIMUM BUILDING SEPARATION		
BETWEEN BUILDING AND BUILDING	45'	45'
BETWEEN BUILDING AND PARKING STRUCTURE	30'	30'
MAXIMUM BUILDING HEIGHT		
ACADEMIC AND PERFORMANCE FACILITIES	50'	<50'
FLY LOFT	65'	<65'
HOUSING AND SOCIAL FACILITIES	45'	<45'
PARKING STRUCTURE	38'	<38'
MAXIMUM BUILDING COVERAGE - TOTAL (INCLUDES PARKING STRUCTURE) MAXIMUM BUILDING COVERAGE - INDIVIDUAL	30%	35.5%*
RESIDENCE HALL 2 (1.17 ACRES)	10%	7.6%
RESIDENCE HALL 1 (1.05 ACRES)	10%	8.5%
PERFORMING ARTS CENTER (0.77 ACRES) MAXIMUM RETAIL SQUARE FOOTAGE	10%	5.6%
	100'	227.8'
MINIMUM FACILITY SETBACK FROM SINGLE FAMILY RESIDENTIAL USE	10'	10'
MINIMUM ELEVATOR/STAIR TOWER ON PARKING STRUCTURE SETBACK	50'	41.4'
MAXIMUM LENGTH OF ELEVATOR/STAIR TOWER PROJECTION	5'	5'
MINIMUM LOADING AREA SETBACK	50'	82.5'
RIPARIAN BUFFER SETBACK		
	82%**	69%
MAXIMUM IMPERVIOUS AREA	5% OF GSF	2.9% OF GSF ***


- * BUILDING COVERAGE EXCEEDING 30% SHALL REQUIRE TWO SQUARE FEET OF OPEN SPACE DEDICATION PER ONE SQUARE FOOT OVER 30%. 33,106 SF EXCEEDING 30% BUILDING COVERAGE REQUIRES 66,212 SF OPEN SPACE DEDICATION. (87,120 SF PROVIDED) (REFER TO THIS SHEET FOR LOCATION OF PRESERVATION AREA)
- ** PROPOSED IMPERVIOUS CONDITIONS MUST BE A MINIMUM 10% REDUCTION FROM EXISTING IMPERVIOUS AREA 92% EXISTING IMPERVIOUS COVERAGE - 10% = 82%

14,595 SF = 2.9% OF GSF194,558 SF (BUILDING 1) + 223,376 SF (BUILDING 2) * 79,400 SF (PAC)

SETBACK CHART	ARTERIAL STREETS		MINOR COLLECTORS		F	RAILROAD RIGHTS-OF-WAY	
	REQUIRED	PROPOSED	REQUIRED	PROPOSED	Γ	REQUIRED	PROPOSED
PERFORMANCE AND SOCIAL FACILITIES	35'	38.2'	30'	65'	Τ	50'	332'
HOUSING FACILITIES	35'	39'	30'	30'	T	50'	61.6'
PARKING STRUCTURES	120'	169.5'	20'	21'	T	30'	30'
SURFACE PARKING LOTS	60'	237.7'	60,	103'	Τ	5'	12'
RETAIL SUBORDINATE USES	35'	39'	30'	30'	Ι	50'	234.4'

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TOLENTINE HALL

DRAFT CONDITIONAL USE APPLICATION CONDITIONS:

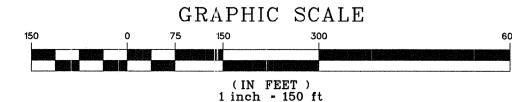ON NOVEMBER 24, 2014, THE RADNOR TOWNSHIP BOARD OF COMMISSIONERS GRANTED THE CONDITIONAL USE APPLICATION OF VILLANOVA UNIVERSITY. THE GRANTING OF THIS APPLICATION IS SUBJECT TO THE FOLLOWING CONDITIONS:

PRESERVATION AREA; TO SATISFY MINIMUM CICD REQUIREMENTS = 2.00 AC.

- THE APPLICANT SHALL COMPLY WITH ALL OTHER APPLICABLE TOWNSHIP ORDINANCES AND SHALL SUBMIT A LAND DEVELOPMENT PLAN PURSUANT TO THE TOWNSHIP'S SUBDIVISION AND LAND DEVELOPMENT ORDINANCE PRIOR TO THE CONSTRUCTION OF ANY FACILITIES. THAT THE TRANSPORTATION, ROADWAY AND SIGNALIZATION AND IMPROVEMENTS NECESSARY FOR THE CONSTRUCTION HAVE FULL ACCESS TO ITHAN AVENUE FROM BOTH THE PIKE LOT PARKING GARAGE AND LANCASTER AVENUE HOUSING PARKING AREA WITH PROVISIONS FOR STOP CONTROL FOR BOTH PARKING ACCESSES TO ITHAN AVENUE AND A PEDESTRIAN CROSSWALK BE REQUIRED IF APPROVED BY PENNDOT, UNLESS WAIVED BY THE BOARD OF COMMISSIONERS
- DURING THE LAND DEVELOPMENT PROCESS. THAT DURING THE LAND DEVELOPMENT PROCESS AN EVENT CIRCULATION PLAN BE DEVELOPED TO ADDRESS EVENT PARKING AND TRAFFIC CIRCULATION WITH THE RADNOR TOWNSHIP POLICE DEPARTMENT AND TOWNSHIP TRAFFIC ENGINEER OUTLINING PROCEDURES, TRAFFIC PATTERNS, PARKING CONFIGURATIONS AND WAY FINDING TECHNIQUES OR THE VARIOUS SPORTING AND OTHER EVENTS HELD AT THE UNIVERSITY. UPON DEVELOPMENT OF THE EVENT
- CIRCULATION PLAN, VILLANOVA SHALL BE RESPONSIBLE FOR CONSTRUCTING AND/OR INSTALLING SUCH SIGNS, RUCTURES, OR OTHER DIRECTIONAL AIDS NECESSARY TO IMPLEMENT THE EVENT CIRCULATION PLAN. THAT VILLANOVA UNIVERSITY CONTRIBUTES THE SUM OF ONE HUNDRED SEVENTY-FIVE THOUSAND DOLLARS (\$175,000.00) TOWARDS THE DESIGN, APPROVAL AND INSTALLATION OF A TRAFFIC ADAPTIVE SIGNAL SYSTEM THAT WOULD INCORPORATE THE FOLLOWING SIGNALIZED INTERSECTIONS ALONG LANCASTER AVENUE:
 - SPROUL ROAD / SPRING MILL ROAD; ALDWYN LANE / KENILWORTH STREET CHURCH WALK ITHAN AVENUE AIRDALE ROAD

COUNTY LINE ROAD

HILLDALE ROAD

ASHWOOD

MIDDLETON #

- THAT DURING THE LAND DEVELOPMENT PROCESS AN EMERGENCY EVACUATION PLAN FOR THE NEW STUDENT HOUSING THAT APPROPRIATE FENCING BE PROVIDED ON BOTH THE NORTH AND SOUTH SIDES OF LANCASTER AVENUE IN THE AREA OF THE CHURCH WALK PEDESTRIAN BRIDGE IN AN EFFORT TO RESTRICT PEDESTRIAN TRAFFIC FROM ACCESSING THE CAMPUS. A GATE SHALL BE PROVIDED FOR VEHICULAR AND PEDESTRIAN ACCESS DURING CHURCH EVENTS IF
- APPROVED BY THE BOARD OF COMMISSIONERS. THAT THE UNIVERSITY PRESERVE THE ENTIRE AREA KNOWN AS THE ALDWYN TRIANGLE AND RESTRICT IT AS OPEN SPACE EXCEPT FOR THAT PORTION OF THE AREA NECESSARY TO PROVIDE HANDICAP ACCESSIBILITY IMPROVEMENTS FOR THE ADJACENT SEPTA RAIL LINE.
- THAT A LANDSCAPE AND BUFFER PLAN BE DEVELOPED TO COMPLY WITH SECTION 280-68.1.D.(3)(b) OF THE ZONING THAT VILLANOVA SEEK PERMISSION FROM PECO TO PLANT SCREENING ON THE SOUTH SIDE OF THE PECO R-100 LINE TO VISUALLY SCREEN THE SEPTA BRIDGE FROM THE ADJACENT RESIDENTIAL NEIGHBORS. PROVIDED THAT THE APPLICANT
- ECEIVES PERMISSION, VILLANOVA SHALL PROVIDE AN INSTALLATION AND MAINTENANCE PLAN OF THE VEGETATION NECESSARY FOR THIS SCREENING DURING LAND DEVELOPMENT VILLANOVA SHALL PROVIDE RADNOR TOWNSHIP WITH A LIST OF CONTRACTORS, SUBCONTRACTORS AND VENDORS AND THEIR ADDRESSES WITHIN TWENTY (20) DAYS OF THE EXECUTION OF ANY CONTRACTS BY VILLANOVA IN CONNECTION WITH THE DEVELOPMENT AND/OR CONSTRUCTION OF THE PROPOSED PROJECT. THE PURPOSE OF THIS
- IST IS TO PERMIT THE TOWNSHIP TO AUDIT FOR REQUIRED BUSINESS/MERCANTILE TAXES. DURING THE LAND DEVELOPMENT PROCESS, THE APPLICANT SHALL USE ITS BEST EFFORTS TO DEVELOP AND CONSTRUCT ORMWATER MANAGEMENT FACILITIES, INCLUDING GREEN INFRASTRUCTURE PRACTICES AND COMPONENTS THAT MEET OR EXCEED INFILTRATION OR RETENTION REQUIREMENTS AS CURRENTLY REQUIRED BY THE RADNOR TOWNSHIP STORMWATER MANAGEMENT ORDINANCE. THE APPLICANT SHALL CONDUCT SOIL TESTING AS NECESSARY TO DETERMINE WHETHER THE SITE CAN ACCOMMODATE VOLUME MANAGEMENT IN EXCESS OF 1-INCH OF RUN-OFF FROM ALL IMPERVIOUS SURFACES RESULTING FROM THE PROJECT. IF SOIL TESTING INDICATES THAT IT IS POSSIBLE TO PROVIDE VOLUME MANAGEMENT IN EXCESS OF 1-INCH OF RUN-OFF, THE APPLICANT SHALL CONSTRUCT SUCH NECESSARY
- STORMWATER FACILITIES ON THE SITE TO ACCOMMODATE THIS INCREASED VOLUME. THE APPLICANT SHALL OBTAIN REVISIONS TO BOTH THE RADNOR TOWNSHIP AND LOWER MERION TOWNSHIP ACT 5:37 PLANS IN ORDER TO ACCOMMODATE THE INCREASED WASTEWATER DISPOSAL GENERATED BY THE PROJECT. THE APPLICANT SHALL DEVELOP A TRAFFIC PLAN DURING THE LAND DEVELOPMENT PROCESS DELINEATING THE PATHS
- BY WHICH THE EXISTING POPULATION OF COMMUTING AND PART-TIME STUDENTS WILL BE DIRECTED TO AND FROM PARKING FOR EACH PHASE OF THE CONSTRUCTION THE APPLICANT SHALL PERMIT PARISHIONERS TO PARK, ON A SPACE AVAILABLE BASIS, ON THE NORTH SIDE OF LANCASTER AVENUE ON EXISTING VILLANOVA PROPERTY ADJACENT TO THE CHURCH FOR CHURCH RELATED EVENTS. THE APPLICANT SHALL MAINTAIN A PEDESTRIAN CROSSWALK FROM THE PROPOSED PROJECT SITE TO THE EXISTING
- HURCH AT THE PRESENT CHURCH WALK LOCATION. THE APPLICANT SHALL INSURE THAT NO AMPLIFIED MUSIC OR OTHER EXCESSIVE NOISE SHALL EMANATE FROM ANY OF THE SOUTH FACING DORMITORIES. DURING THE LAND DEVELOPMENT PROCESS, THE TOWNSHIP AND APPLICANT SHALL ESTABLISH A PERMISSIBLE SOUND LEVEL AT THE PROPERTY BOUNDARY OF THE ALDWYN LANE RESIDENTIAL USES.

ADDITIONAL AREA TO BE PRESERVED = 3.18 AC.

MENDEL SCIENCE CENTER

ST. THOMAS MONASTERY

ST. THOMAS OF -

PEDESTRIAN

BRIDGE

CHURCH

MEMORIAL

ALUMI HALL

ST. RITA HALL

*ALDWYN TRIANGLE: LAND PRESERVATION CALCULATIONS

ALDWYN

TRIANGLE

5.18 AC. TOTAL

TO BE

PRESERVED

ST. AUGUSTINE CENTER

AUSTIN HALL

SAC PARKING GARAGE

494 PROPOSED PARKING SPACES

(2 ADDITIONAL LEVELS)

CONNELLY CENTER

KENNEDY

DOUGHERTY

- CICD DISTRICT

ALLOWABLE BUILDING COVERAGE: 13.81 AC x .30 = 4.14 ACRES PROPOSED BUILDING/STRUCTURE COVERAGE: 4.90 ACRES PROPOSED BUILDINGS = 2.99 AC PROPOSED GARAGE = 1.91 AC

BUILDING COVERAGE ABOVE 30% = 0.76 ACRES (4.90 - 4.14) REQUIRED LAND PRESERVATION = 0.76 x 2 = 1.52 ACRES PROPOSED UNRESTRICTED LAND PRESERVATION AREA = 2.00 ACRES

GENERAL NOTES:

THIS PLAN IS BASED ON A SURVEY CONDUCTED IN THE FIELD BY NAVE NEWELL, INC., AND COMPLETED AUGUST 8, 2011 PROPERTY AS SHOWN IS IN NON-FLOOD PRONE COMMUNITY AS DEPICTED ON THE FEDERAL EMERGENCY AGENCY FIRM FLOOD INSURANCE RATE MAP COMMUNITY PANEL NO. 42045C0050F PER NO. 42045CINDOA, MAP REVISED NOVEMBER 18, 2009. 3. LOCATIONS OF EXISTING UTILITIES AS SHOWN HEREIN HAVE BEEN DEVELOPED FROM EXISTING UTILITY RECORDS, PLANS BY OTHERS AND/OR ABOVE GROUND EXAMINATION OF SITE. THE COMPLETENESS OR ACCURACIES OF THE LOCATIONS ARE NOT GUARANTEED. SHOULD ANY NEW CONSTRUCTION BE PROPOSED, THE CONTRACTOR MUST VERIFY LOCATIONS AND DEPTHS OF ALL UTILITIES BEFORE START OF WORK. 4. NO REVIEW OF THE PROPERTY REGARDING THE PRESENCE OF WETLANDS WAS ACCOMPLISHED AS A PART OF THIS SURVEY 5. NO REVIEW OF THE PROPERTY REGARDING THE PRESENCE OF HAZARDOUS MATERIAL WAS ACCOMPLISHED AS A PART OF

STANFORD HALL

CAMPUS

STEAM PLANT

TENNIS COURTS

MAINTENANCE

DRISCOLL

BARTLEY

FUTURE PERFORMING

ARTS CENTER

PIKE SOFTBALL FIELD

PIKE GARAGE

ST. MONICA

CAUGHLIN

KATHERINE

JAKE NEVIN

FIELDHOUSE

BUTLER ANNEX

STRUCTURES

PARKING GARAGE

. THE PROPOSED USES ARE TO BE SERVICED BY PUBLIC SEWER (LOWER MERION TOWNSHIP) AND PUBLIC WATER (AQUA PA). ALL PROPOSED UTILITIES IN CONJUNCTION WITH THIS SITE SHALL BE PLACED UNDERGROUND 8. PURSUANT TO SECTION 420 OF THE ACT OF JUNE 1, 1945, (PL1242, NO. 428), KNOWN AS THE "STATE HIGHWAY LAW", PENNDOT HIGHWAY OCCUPANCY PERMITS ARE REQUIRED FOR ANY PROPOSED CONSTRUCTION WITHIN THE RIGHT-OF-WAY OF LANCASTER AVENUE, S.R. 0030 ALL CONSTRUCTION IS TO BE IN COMPLIANCE WITH THE STANDARDS AND SPECIFICATIONS OF RADNOR TOWNSHIP. 10. THE PROPOSED BUILDING FOOTPRINTS NOTED ON THE PLAN ARE SCHEMATIC. THE ACTUAL ARCHITECTURAL PLANS SHALL

GRADING AND UTILITY CONNECTIONS ARE TO BE COORDINATED WITH THE ARCHITECTURAL PLANS, PRIOR TO CONSTRUCTION, TO AVOID ANY CONFLICTS. THE CONTRACTOR SHOULD NOTIFY THE OWNER OF ANY DISCREPANCIES PRIOR TO CONSTRUCTION. 11. THE PROPOSED SEWER AND WATER SERVICE CONNECTIONS ARE TO BE COORDINATED WITH THE ARCHITECTURAL PLANS TO ENSURE EXACT LOCATION. THE CONTRACTOR IS RESPONSIBLE FOR VERIFYING ALL UTILITY CONNECTION LOCATIONS, AND SHOULD NOTIFY THE OWNER OF ANY DISCREPANCIES PRIOR TO CONSTRUCTION. 12. THE OWNER SHALL HAVE THE RESPONSIBILITY FOR THE PERPETUAL MAINTENANCE OF THE PERMANENT STORM WATER DETENTION BASINS AND BASIN OUTLET STRUCTURES. NO CHANGES SHALL BE MADE TO THE STRUCTURES, PIPES OR FINISH GRADING WITHOUT PRIOR WRITTEN APPROVAL FROM THE TOWNSHIP

BE UTILIZED FOR BUILDING CONSTRUCTION AND MUST BE NO LARGER THAN SCHEMATIC FOOTPRINT SHOWN. THE PROPOSED

13. NO BUILDING OR OBSTRUCTION THAT WOULD OBSCURE THE VISION OF A MOTORIST SHALL BE PERMITTED WITHIN THE 14. THE PROJECT WILL REQUIRE A "GENERAL NPDES PERMIT" FROM THE PENNSYLVANIA DEPARTMENT OF ENVIRONMENTAL PROTECTION SUBJECT TO OBTAINING APPROVED EROSION AND SEDIMENTATION CONTROL PLANS FROM THE DELAWARE COUNTY CONSERVATION DISTRICT, PRIOR TO CLEARING OR EARTH MOVING ACTIVITY. 15. ALL CURVED SECTIONS OF CURBING SHALL HAVE A FIVE FOOT RADIUS (R=5'), UNLESS NOTED OTHERWISE AS SHOWN ON

16. THE INTENDED USE OF THE PROPOSED BUILDINGS ARE FOR STUDENT HOUSING AND ASSOCIATED RETAIL 17. ULTIMATE RIGHT-OF-WAY OF ITHAN AVENUE, AS SHOWN, IS OFFERED FOR DEDICATION TO RADNOR TOWNSHIP AS PART OF 18. ALL SLOPES IN EXCESS OF 14% WITHIN THE PROJECT LIMITS WERE CREATED BY MAN-MADE ACTIVITIES.

19. GRADING AND EROSION CONTROL PLANS MUST BE SUBMITTED AND APPROVED PRIOR TO ISSUANCE OF BUILDING PERMITS.

PROPERTY LINE — — — — — BUILDING SETBACK LINE --- LEGAL RIGHT-OF-WAY LINE EXISTING CURB EXISTING EDGE OF PAVEMENT EXISTING BUILDING --- x ---- x --- EXISTING FENCE ---- EXISTING RETAINING WALL ############# EXISTING RAILROAD TRACKS EXISTING WETLANDS LIMITS OF CICD DISTRICT PROPOSED RIGHT-OF-WAY LINE PROPOSED CURB - PROPOSED EDGE OF PAVEMENT PROPOSED BUILDING PROPOSED DECORATIVE FENCE

PROPOSED RETAINING WALL

MINIMUM REQUIRED PRESERVATION AREA

ADDITIONAL PRESERVATION AREA PROVIDED

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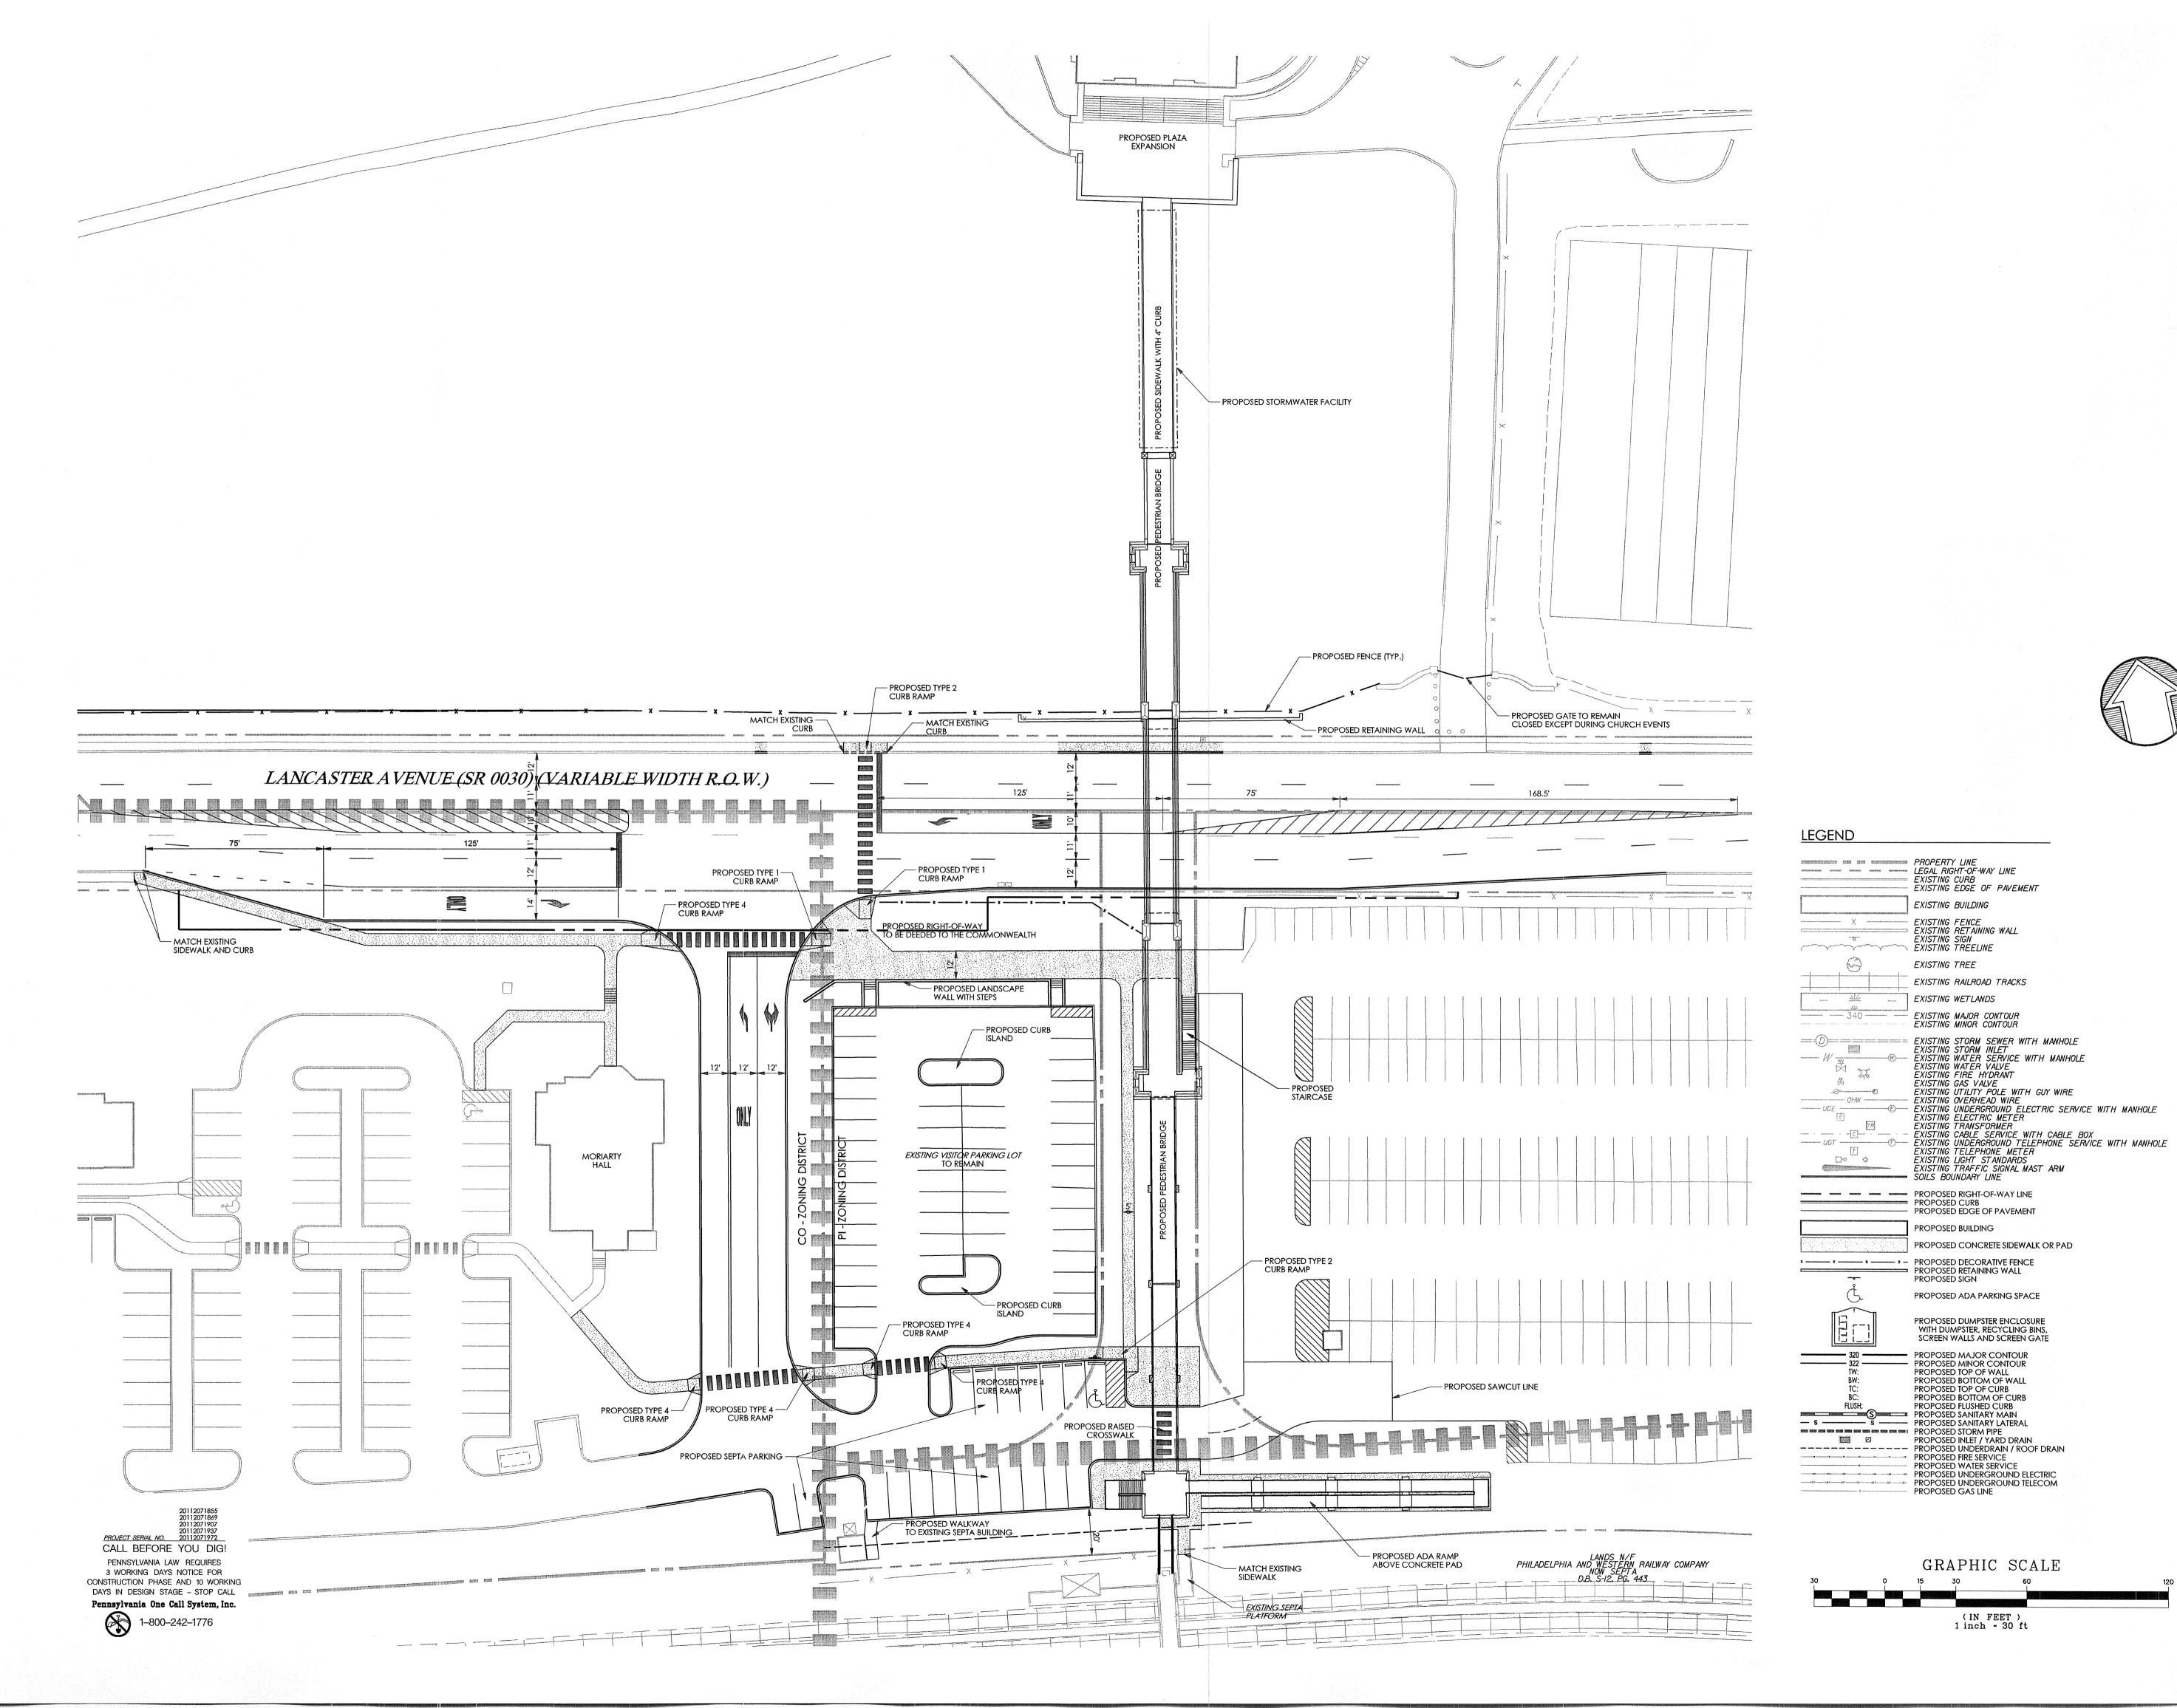


PRELIM. LAND DEVELOPMENT SUBMISSION

Revision

March 13, 2015 Date Composite Site Plan

Scale 1" = 150' Drawn By MMB



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fax: 910-649-8475

EXISTING BUILDING

EXISTING WATER VALVE EXISTING FIRE HYDRANT

SOILS BOUNDARY LINE

PROPOSED DUMPSTER ENCLOSURE

PROPOSED TOP OF CURB

WITH DUMPSTER, RECYCLING BINS, SCREEN WALLS AND SCREEN GATE

GRAPHIC SCALE


(IN FEET) 1 inch = 30 ft

EXISTING UNDERGROUND ELECTRIC SERVICE WITH MANHOLE

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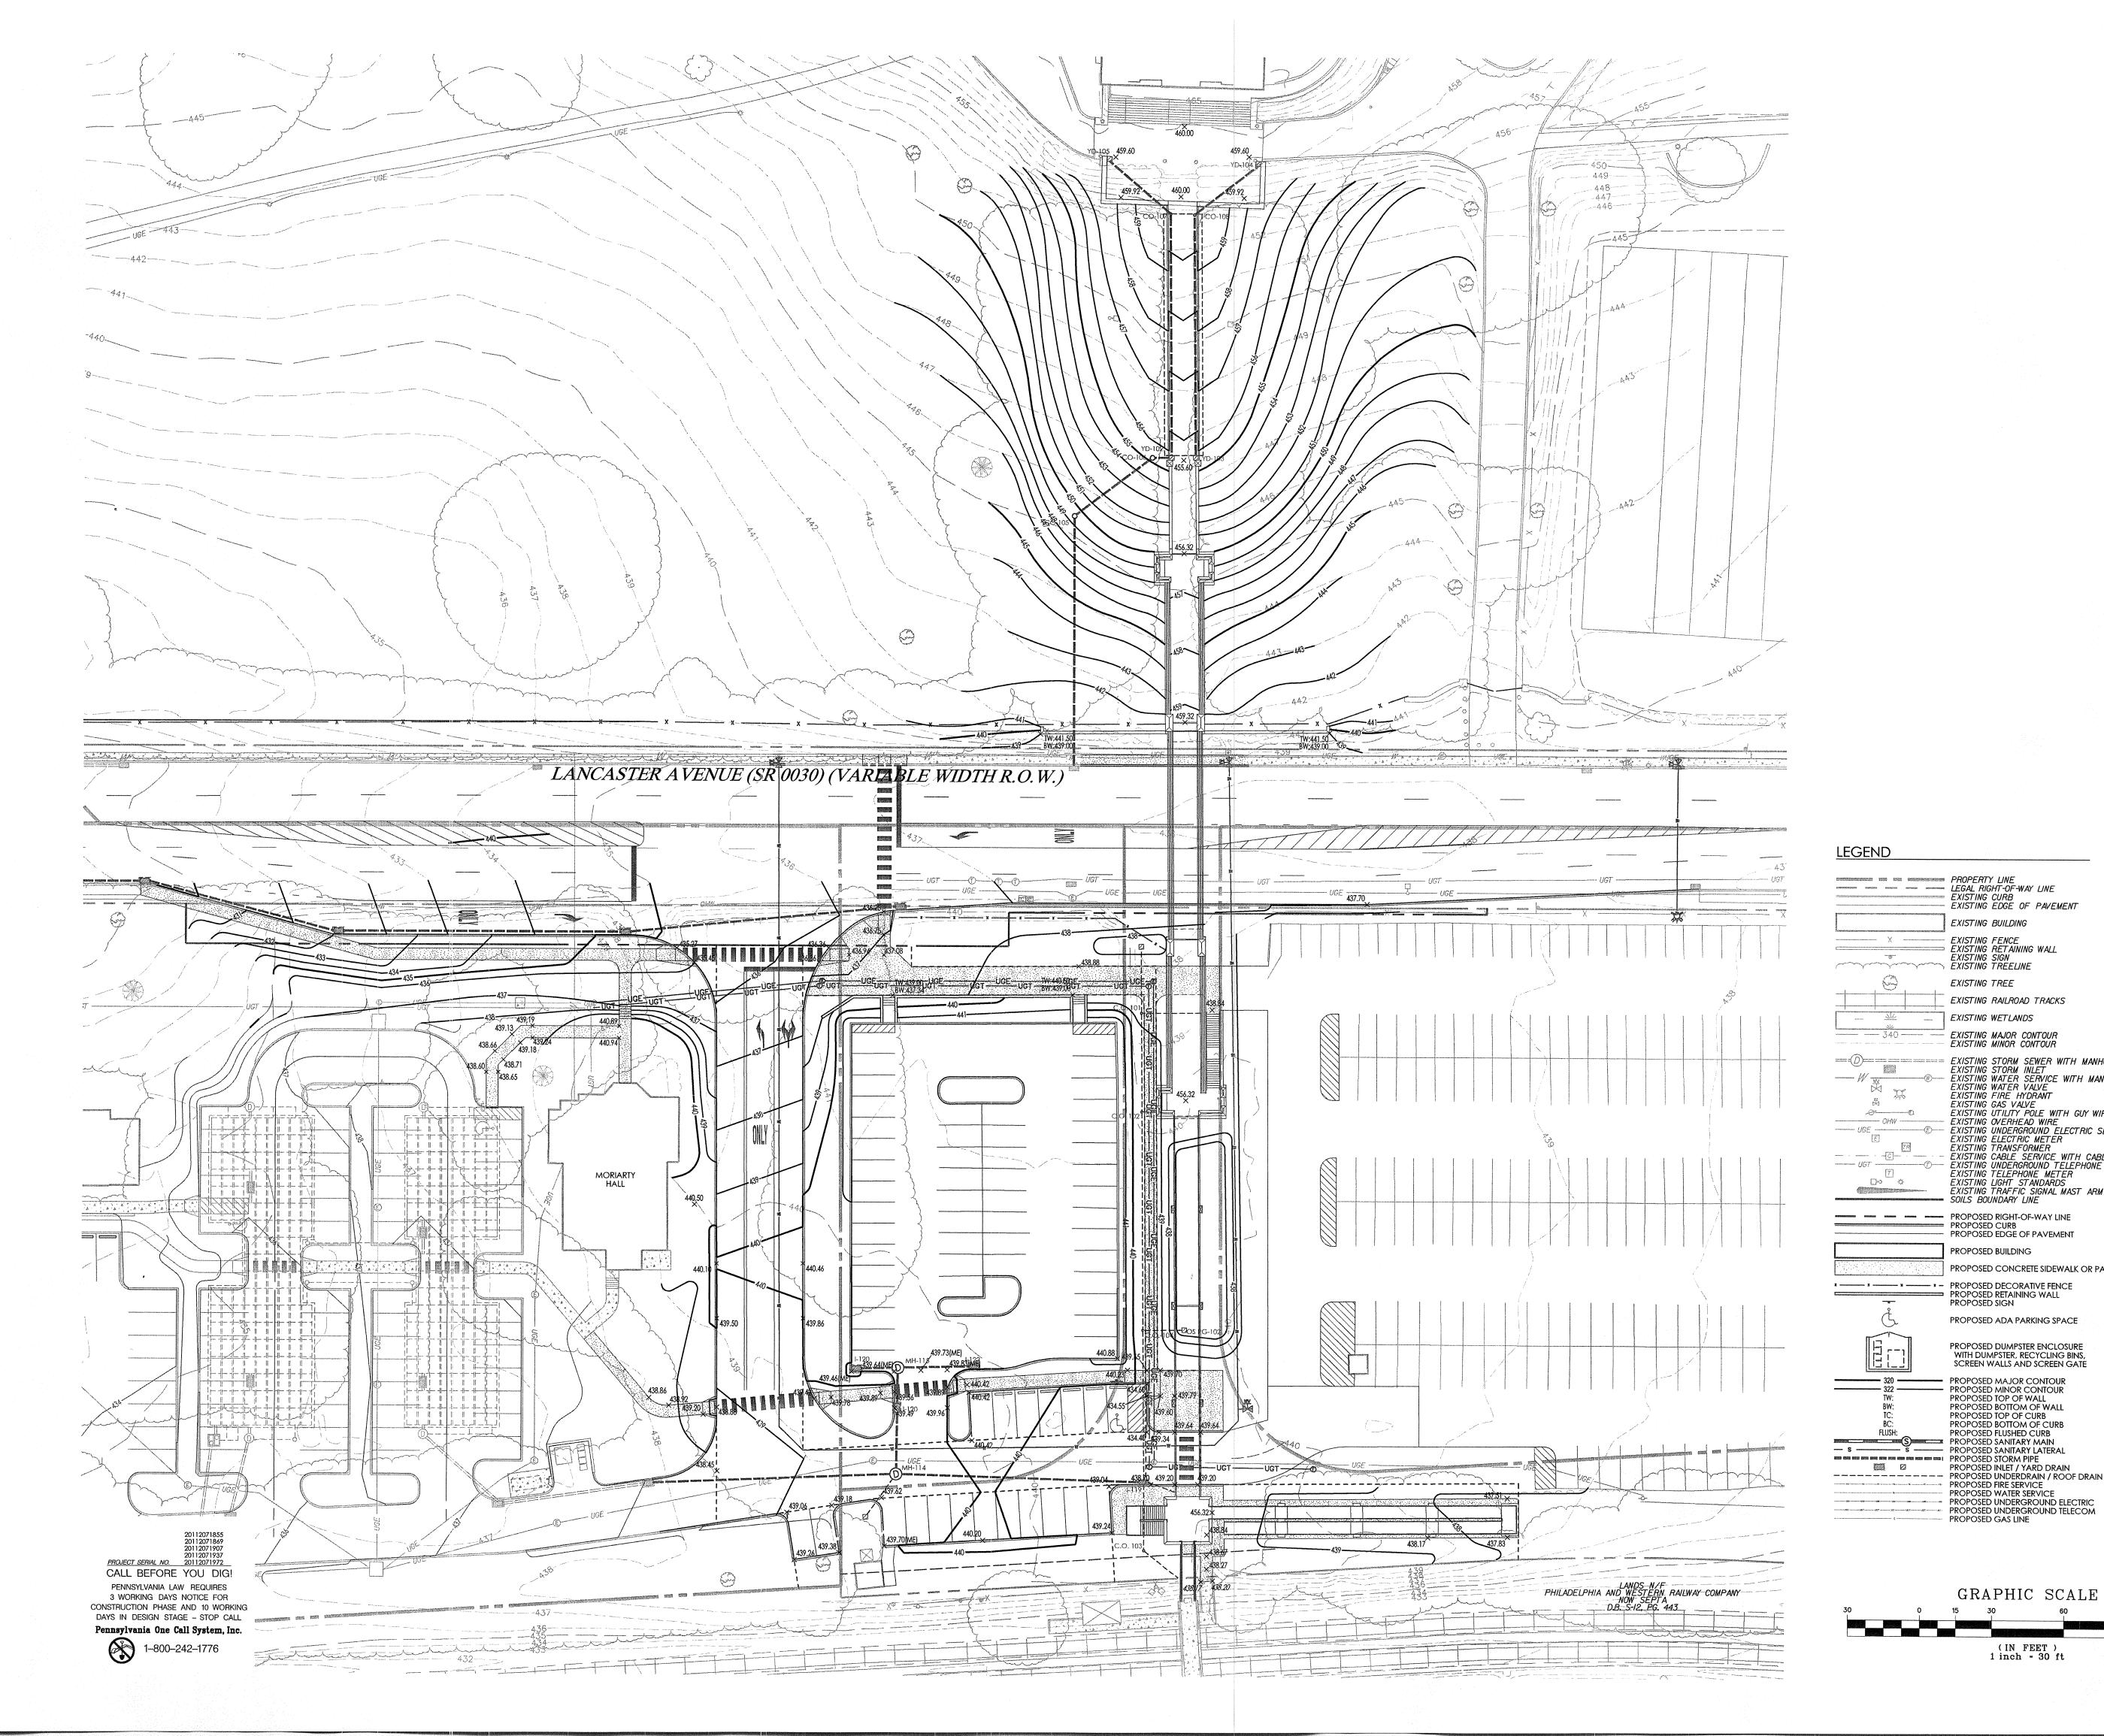
PRELIM. LAND DEVELOPMENT SUBMISSION

Revision

March 13, 2015 Date Title Site Plan

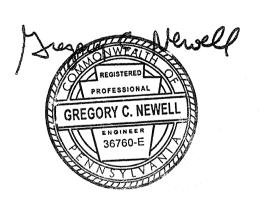1" = 30' Scale Drawn By DWN

Sheet No.



Church Walk and Bridge Lancaster and Ithan Avenues Villanova PA 19085

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EXISTING BUILDING

EXISTING TREE

EXISTING WETLANDS

EXISTING FENCE

EXISTING RETAINING WALL
EXISTING SIGN
EXISTING TREELINE

EXISTING RAILROAD TRACKS

EXISTING MAJOR CONTOUR

EXISTING MINOR CONTOUR

EXISTING WATER VALVE EXISTING FIRE HYDRANT EXISTING GAS VALVE

SOILS BOUNDARY LINE

PROPOSED BUILDING

EXISTING OVERHEAD WIRE

EXISTING STORM SEWER WITH MANHOLE EXISTING STORM INLET

EXISTING UTILITY POLE WITH GUY WIRE

PROPOSED CONCRETE SIDEWALK OR PAD

PROPOSED ADA PARKING SPACE

PROPOSED DUMPSTER ENCLOSURE WITH DUMPSTER, RECYCLING BINS, SCREEN WALLS AND SCREEN GATE

 PROPOSED MAJOR CONTOUR PROPOSED MINOR CONTOUR PROPOSED TOP OF WALL

PROPOSED BOTTOM OF WALL PROPOSED TOP OF CURB

PROPOSED BOTTOM OF CURB

PROPOSED INLET / YARD DRAIN

GRAPHIC SCALE

(IN FEET) 1 inch - 30 ft

PROPOSED FIRE SERVICE PROPOSED WATER SERVICE


PROPOSED GAS LINE

- EXISTING OVERHEAD WIRE
- EXISTING UNDERGROUND ELECTRIC SERVICE WITH MANHOLE
EXISTING ELECTRIC METER
EXISTING TRANSFORMER
- EXISTING CABLE SERVICE WITH CABLE BOX
- EXISTING UNDERGROUND TELEPHONE SERVICE WITH MANHOLE
EXISTING TELEPHONE METER
EXISTING LIGHT STANDARDS
EXISTING TRAFFIC SIGNAL MAST ARM

SOULS BOUNDARY LINE

XISTING WATER SERVICE WITH MANHOLE

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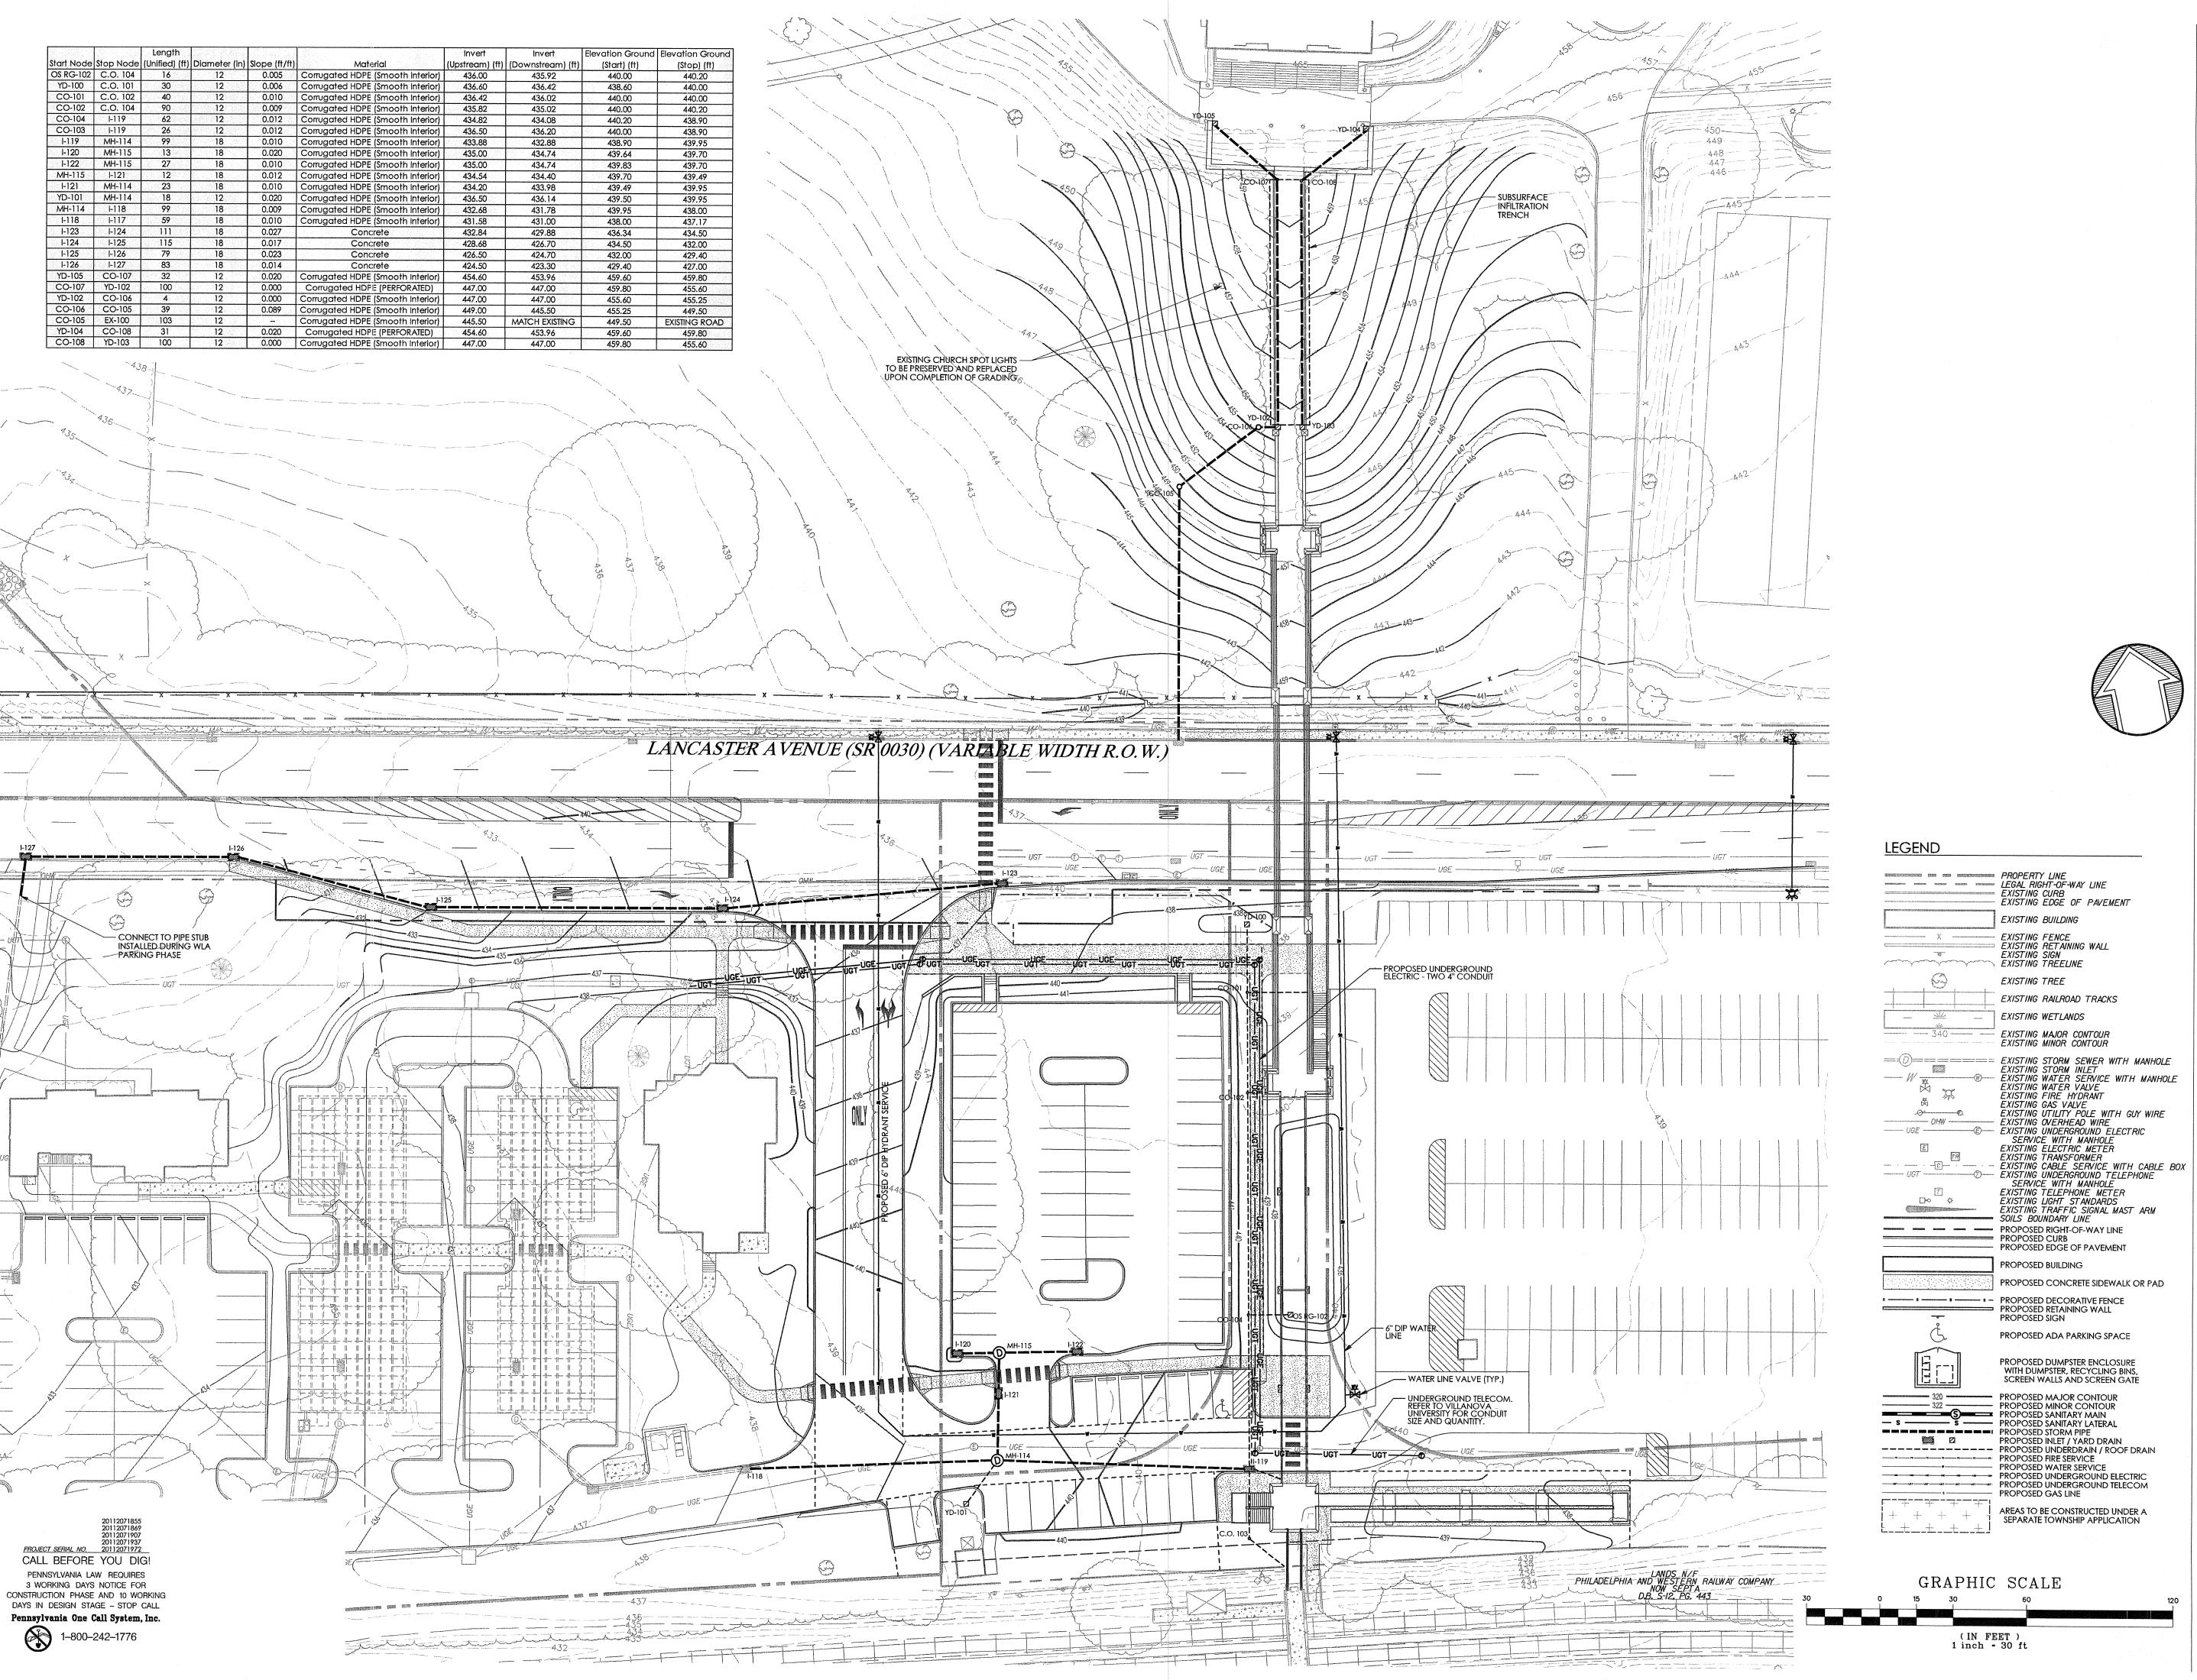


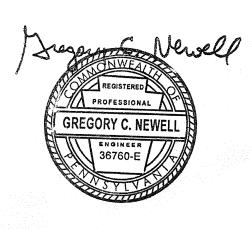PRELIM. LAND DEVELOPMENT SUBMISSION

Revision March 13, 2015 Title Grading Plan

Scale 1" = 30' Drawn By DWN

Sheet No. 5 of 20



Church Walk and Bridge
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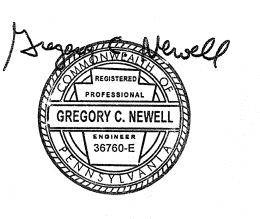
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PRELIM. LAND DEVELOPMENT SUBMISSION

SUBMISSION Revision


Date March 13, 2015
Title Utility Plan


Scale 1" = 30'
Drawn By DWN

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6 of 20



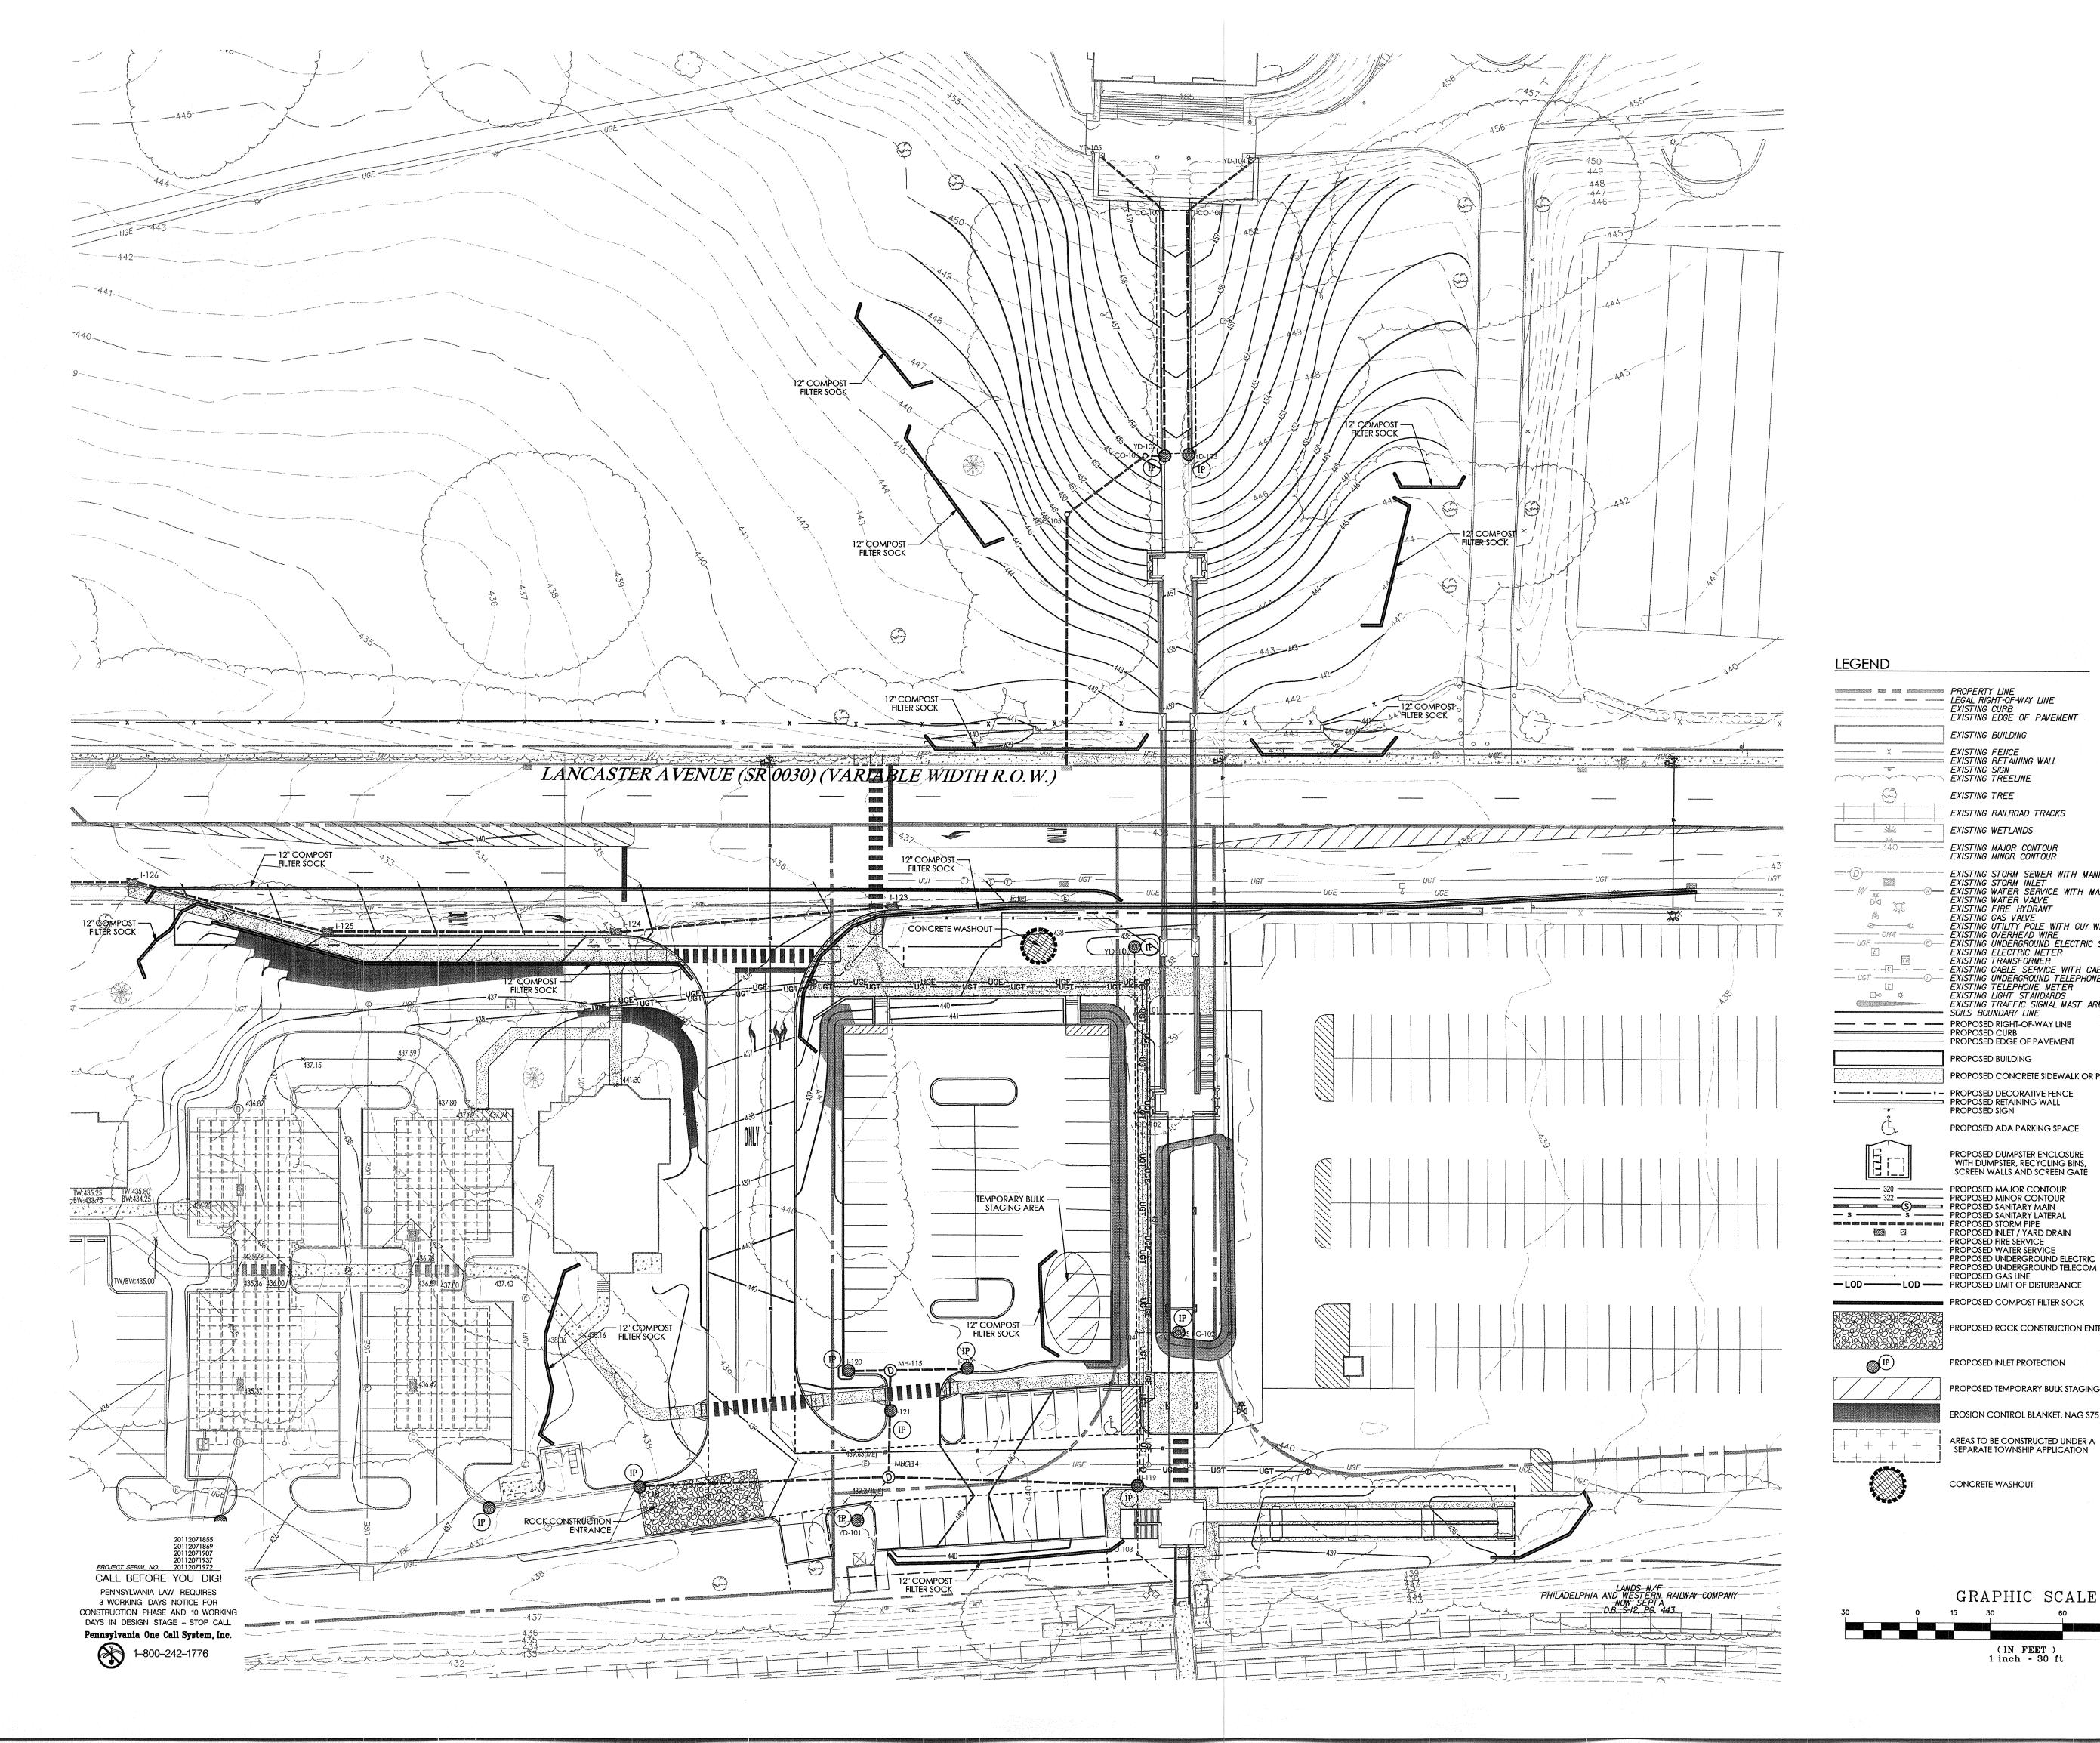

PROPERTY LINE
LEGAL RIGHT-OF-WAY LINE
EXISTING CURB
EXISTING EDGE OF PAVEMENT

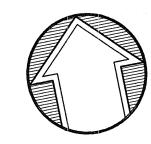EXISTING BUILDING

EXISTING TREE

EXISTING WETLANDS

EXISTING FENCE

EXISTING RETAINING WALL
EXISTING SIGN
EXISTING TREELINE

EXISTING RAILROAD TRACKS

EXISTING MAJOR CONTOUR EXISTING MINOR CONTOUR

EXISTING FIRE HYDRANT

SOILS BOUNDARY LINE

PROPOSED BUILDING

PROPOSED SIGN

- PROPOSED EDGE OF PAVEMENT

PROPOSED ADA PARKING SPACE

PROPOSED DUMPSTER ENCLOSURE WITH DUMPSTER, RECYCLING BINS SCREEN WALLS AND SCREEN GATE

PROPOSED INLET / YARD DRAIN

PROPOSED COMPOST FILTER SOCK

PROPOSED INLET PROTECTION

PROPOSED ROCK CONSTRUCTION ENTRANCE

PROPOSED TEMPORARY BULK STAGING AREA

EROSION CONTROL BLANKET, NAG \$75

AREAS TO BE CONSTRUCTED UNDER A

GRAPHIC SCALE

(IN FEET) 1 inch = 30 ft

SEPARATE TOWNSHIP APPLICATION

CONCRETE WASHOUT

PROPOSED FIRE SERVICE PROPOSED WATER SERVICE

PROPOSED CONCRETE SIDEWALK OR PAD

EXISTING STORM SEWER WITH MANHOLE
EXISTING STORM INLET
EXISTING WATER SERVICE WITH MANHOLE
EXISTING WATER VALVE

EXISTING FIRE HYDRANT
EXISTING GAS VALVE
EXISTING UTILITY POLE WITH GUY WIRE
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PRELIM. LAND DEVELOPMENT SUBMISSION

Revision

March 13, 2015 Title Erosion & Sedimentation Control Plan

Scale 1" = 30' Drawn By DWN

Sheet No.

GENERAL CONSERVATION NOTES AND SPECIFICATIONS

INTENT OF CONSERVATION PROGRAM: THE INTENT OF THIS PROGRAM IS TO PREVENT ACCELERATED EROSION OF THE EXPOSED SITE SOILS DURING THE CONSTRUCTION AND PERMANENT HEE PERIODS OF THE DEVELOPMENT. TH PROGRAM REQUIRES RETENTION OF ALL SEDIMENTS ON THE CONSTRUCTION SITE TO MINIMIZE THE IMPACT OF DEVELOPMENT ON EXISTING STREAMS AND ADJACENT PROPERTY OWNERS. THESE OBJECTIVES WILL BE ACHIEVED BY MINIMIZING THE EXPOSURE TIME OF POTENTIALLY EROSIVE SOILS TO RUNOFF AND INSTALLATION OF THE TEMPORARY CONSTRUCTION. THE INTENT OF THI PROGRAM SHOULD BE UNDERSTOOD AND IMPLEMENTED THROUGHOUT THE ENTIRE DEVELOPMENT. THE VARIOUS CONSTRUCTION TRADES SHOULD BE APPRAISED OF THIS PROGRAM AND DIRECTED TO PREVENT UNDUE DISTURBANCE OF PREPARED AND PROTECTED SURFACES

SURFACE STABILIZATION CRITERIA: ALL DENUDED SOIL SURFACES, INCLUDING SOIL STOCKPILES, ARE SUBJECT TO EROSION AND SHALL BE STABILIZED EITHER TEMPORARILY OR PERMANENTLY, IMMEDIATELY DURING NON-GERMINATION PERIODS, MULCH MUST BE APPLIED AT RECOMMENDED RATES. CRUSHED STONE ON PAVEMENT SUBGRADES IS CONSIDERED ADEQUATE PROTECTION. ALL DISTURBED ZONES AND VEGETATED REGIONS SHALL BE STABILIZED, PREFERABLY WITH A PERMANENT TREATMENT

SEEDING SHALL BE COMMON RYE GRASS APPLIED AT 45 LBS. PER ACRE. LIMING TO BE APPLIED AT 1 TON/ACRE. 50-50-50 FERTILIZER TO BE APPLIED AT 1000 LBS/ACRE. HAY OR STRAW MULCH TO BE APPLIED AT 3 TONS/ACRE

SEEDING SHALL BE 15% KENTUCKY BLUEGRASS, 35% KENTUCKY 31 FESCUE, 25% CHEWINGS FESCUE, 15% PERENNIAL RYE GRASS AND 10% RECLEANED REDTOP AT A RATE OF 60 LBS. PER ACRE. LIMING TO BE APPLIED AT 3 TONS/ACRE. 10-20-30 FERTILIZER TO BE APPLIED AT 1000 LBS/ACRE, HAY OR STRAW MULCH TO BE APPLIED AT 3 TONS/ACRE

THE NON-GERMINATING PERIODS ARE BETWEEN 6/15 THROUGH 8/15 AND 9/30 THROUGH 4/15. AREAS DISTURBED DURING THESE PERIODS MUST BE LIMED, FERTILIZED, SEEDED AND MULCHED IMMEDIATELY FOLLOWING THE END OF THOSE PERIODS. TOPSOIL TAKEN FROM CONSTRUCTION AREAS SHALL BE SEEDED WITH VEGETATIVE COVER AND STOCKPILES FOR RE-LISE IN FINISH GRADING. THERE IS TO BE NO EARTH DISTURBANCE OR VEGETATIVE CLEARING IN AREAS OUTSIDE OF THE DELINEATED AREAS TO BE DISTURBED

MAINTENANCE PROGRAM FOR TEMPORARY SEDIMENTATION CONTROLS STRUCTURES MAINTENANCE OF ALL TEMPORARY SEDIMENTATION CONTROL STRUCTURES SHALL BE THE RESPONSIBILITY OF THE DEVELOPER AND AS STATED BELOW:

1. SEDIMENT MUST BE REMOVED WHEN ACCUMULATIONS REACH ONE-HALF THE EFFECTIVE HEIGHT OF COMPOST FILTER SOCKS.

2. SEDIMENT MUST BE REMOVED FROM ROCK FILTERS WHEN COLLECTED SEDIMENT EGINS TO AFFECT THE FILTER'S FUNCTION. 3. INLET PROTECTION FILTER BAGS SHALL BE INSPECTED ON A WEEKLY BASIS AND AFTER EACH RAINFALL EVENT. BAGS SHALL BE EMPTIED AND RINSED OR REPLACED WHEN HALF FULL OR WHEN FLOW CAPACITY HAS BEEN REDUCED SO AS TO CAUSE

FLOODING OR BYPASSING OF THE INLET, DAMAGED OR CLOGGED BADS SHALL BE REPLACED. . SEDIMENT REMOVED FROM THE FACILITIES MAY BE REINCORPORATED INTO THE SITE'S EARTHWORK AS FILL OR TAKEN TO A SAFE, APPROVED LOCATION. UNTIL THE SITE IS STABILIZED, ALL EROSION AND SEDIMENTATION CONTROLS MUST BE MAINTAINED PROPERLY. MAINTENANCE MUST INCLUDE INSPECTIONS OF ALL CONTROLS AFTER EACH STORM EVENT AND ON A WEEKLY BASIS. ALL PREVENTATIVE AND REMEDIAL MAINTENANCE, REGRADING, RESEEDING, REMULCHING AND RENETTING MUST BE PERFORMED IMMEDIATELY.

MAINTENANCE OF TEMPORARY SEDIMENTATION CONTROL STRUCTURES

MAINTENANCE OF ALL TEMPORARY SEDIMENTATION CONTROL STRUCTURES SHALL BE IN ACCORDANCE WITH THESE PLANS AND THE "EROSION AND CONTROL NARRATIVE." INSPECTION AND MAINTENANCE OF ALL FACILITIES SHALL BE MADE AFTER EACH RAIN STORM EVENT AND ON A WEEKLY BASIS

SEDIMENT DISPOSAL:

SILT REMOVED FROM TEMPORARY SEDIMENT CONTROL STRUCTURES SHALL BE DISPOSED OF ON-SITE IN LANDSCAPED AREAS LOCATED OUTSIDE OF FLOOD PLAINS, WETLANDS, STEEP SLOPES, AND DRAINAGE SWALES. AREAS OF SEDIMENT DISPOSAL SHALL BE CONSIDERED C.V.A. SILT AND SEDIMENT CATEGORIZED AS CONTAMINATED SHALL DISPOSED OF PER THE SOIL MANAGEMENT NOTES

DUST CONTROL:

DUST AND OTHER PARTICULATES SHALL BE KEPT WITHIN TOLERABLE LIMITS BY USING WATER. APPLICATION SHALL BE AS NEEDED OR AS DIRECTED BY THE TOWNSHIP ENGINEER OR THE CONSERVATION DISTRICT CRITICAL VEGETATION AREAS (C.V.A.):

CRITICAL VEGETATION AREAS ARE TO BE GRADED, HYDROSEEDED AND MULCHED WITHIN 10 DAYS OF THE BEGINNING OF EXCAVATION. IN GENERAL CRITICAL VEGETATION AREAS ARE DEFINED AS CUT SLOPES STEEPER THAN 3:1, ALL FILL SLOPES STEEPER THAN 4:1 AND IN ALL DRAINAGE SWALES.

OTHER BMPS:

1. SEDIMENT SHALL BE REMOVED FROM STORM WATER INLET PROTECTION AFTER EACH RUNOFF EVENT.

VISUAL INSPECTIONS

THE PERMITTEE AND CO PERMITTEE(S) MUST ENSURE THAT VISUAL SITE INSPECTIONS ARE CONDUCTED WEEKLY, AND WITHIN 24 HOURS AFTER EACH MEASURABLE RAINFALL EVENT THROUGHOUT THE DURATION OF CONSTRUCTION AND UNTIL THE RECEIPT AND ACKNOWLEDGEMENT OF THE NOT BY THE DEPARTMENT OR AUTHORIZED CONSERVATION DISTRICT. THE VISUAL SITE INSPECTIONS AND REPORTS SHALL BE COMPLETED IN A FORMAT PROVIDED BY THE DEPARTMENT, AND CONDUCTED BY QUALIFIED PERSONN TRAINED AND EXPERIENCED IN EROSION AND SEDIMENT CONTROL, TO ASCERTAIN THAT E&S BMPS AND PCSM BMPS ARE PROPERLY CONSTRUCTED AND MAINTAINED TO EFFECTIVELY MINIMIZE POLLUTION TO THE WATERS OF THIS COMMONWEALTH A WRITTEN REPORT OF EACH INSPECTION SHALL UTILIZE PADEP FORM 3150-FM-BWEW0083 DATED FEBRUARY 2012 AND BE KEPT ON SITE AT ALL TIMES AND INCLUDE AT A MINIMUM:

A SUMMARY OF SITE CONDITIONS, E&S BMP AND PCSM BMP, IMPLEMENTATION AND MAINTENANCE AND COMPLIANCE ACTIONS 2. THE DATE, TIME, NAME AND SIGNATURE OF THE PERSON CONDUCTING THE

NONCOMPLIANCE REPORTING

TERMINATION OF COVERAGE

WHERE E&S, PCSM OR PPC BMPS ARE FOUND TO BE INOPERATIVE OR INEFFECTIVE DURING AN INSPECTION, OR ANY OTHER TIME, THE PERMITTEE AND COPERMITTEE(S) SHALL, WITHIN 24 HOURS, CONTACT THE DEPARTMENT OR AUTHORIZED CONSERVATION DISTRICT, BY PHONE OR PERSONAL CONTACT, FOLLOWED BY THE SUBMISSION OF A WRITTEN REPORT WITHIN 5 DAYS OF THE INITIAL CONTACT. NONCOMPLIANCE REPORTS SHALL INCLUDE THE FOLLOWING INFORMATION 1 ANY CONDITION ON THE PROJECT SITE WHICH MAY ENDANGER PUBLIC HEALTH. SAFETY, OR THE ENVIRONMENT, OR INVOLVE INCIDENTS WHICH CAUSE OR

HREATEN POLLUTION. 2. THE PERIOD OF NONCOMPLIANCE, INCLUDING EXACT DATES AND TIMES AND/OR ANTICIPATED TIME WHEN THE ACTIVITY WILL RETURN TO COMPLIANCE; 3. STEPS BEING TAKEN TO REDUCE, ELIMINATE, AND PREVENT RECURRENCE OF

HE NONCOMPLIANCE: AND 4. THE DATE OR SCHEDULE OF DATES, AND IDENTIFYING REMEDIES FOR CORRECTING NONCOMPLIANCE CONDITIONS.

REDUCTION, LOSS, OR FAILURE OF THE BMPS

UPON REDUCTION, LOSS, OR FAILURE OF THE BMPS, THE PERMITTEE AND CO PERMITTEE SHALL TAKE IMMEDIATE ACTION TO RESTORE THE BMPS OR PROVIDE AN ALTERNATIVE METHOD OF TREATMENT. SUCH RESTORED BMPS OR ALTERNATIVE TREATMENT SHALL BE AT LEAST AS EFFECTIVE AS THE ORIGINAL BMPS.

NOT: UPON PERMANENT STABILIZATION OF EARTH DISTURBANCE ACTIVITIES ASSOCIATED WITH CONSTRUCTION ACTIVITY THAT ARE AUTHORIZED BY THIS PERMIT AND WHEN BMPS IDENTIFIED IN THE PCSM PLAN HAVE BEEN PROPERLY INSTALLED THE PERMITTEE AND/OR CO PERMITTEE OF THE FACILITY MUST SUBMIT A NOT FORM HAT IS SIGNED IN ACCORDANCE WITH PART B, SECTION 1.C, SIGNATORY REQUIREMENTS, OF THIS PERMIT. ALL LETTERS CERTIFYING DISCHARGE TERMINATION ARE TO BE SENT O THE DEPARTMENT OR AUTHORIZED CONSERVATION DISTRICT. THE NOT MUST CONTAIN THE FOLLOWING INFORMATION: FACILITY NAME, ADDRESS, AND LOCATION, DPERATOR NAME AND ADDRESS, PERMIT NUMBER, IDENTIFICATION AND PROOF OF ACKNOWLEDGMENT FROM THE PERSON(S) WHO WILL BE RESPONSIBLE FOR OPERATION AND MAINTENANCE OF THE PCSM BMPS IN ACCORDANCE WITH THE APPROVED PCSM PLAN, AND THE REASON FOR PERMIT TERMINATION. UNTIL THE PERMITTEE HAS RECEIVED WRITTEN ACKNOWLEDGEMENT OF THE NOT, THE PERMITTEE WILL REMAIN RESPONSIBLE FOR OPERATING AND MAINTAINING ALL E&S BMPS AND PCSM BMPS ON THE PROJECT SITE

AND WILL BE RESPONSIBLE FOR VIOLATIONS OCCURRING ON THE PROJECT SITE. COMPLETION CERTIFICATE AND FINAL PLANS

WITHIN 30 DAYS AFTER THE COMPLETION OF EARTH DISTURBANCE ACTIVITIES AUTHORIZED BY THIS PERMIT, INCLUDING THE PERMANENT STABILIZATION OF THE SITE AND PROPER INSTALLATION OF PCSM BMPS IN ACCORDANCE WITH THE APPROVED PCSM PLAN, OR UPON SUBMISSION OF THE NOT IF SOONER, THE PERMITTEE SHALL FILE WITH THE DEPARTMENT OR AUTHORIZED CONSERVATION DISTRICT A STATEMENT SIGNED BY A LICENSED PROFESSIONAL AND BY THE PERMITTEE CERTIFYING THAT WORK HAS BEEN PERFORMED IN ACCORDANCE WITH THE TERMS AND CONDITIONS OF THIS PERMIT AND THE APPROVED E&S AND PCSM PLANS.

SOIL EROSION AND SEDIMENTATION CONTROL NOTES

LANCASTER AVENUE

1. ALL EARTH DISTURBANCES, INCLUDING CLEARING AND GRUBBING AS WELL AS CUTS AND FILLS SHALL BE DONE IN ACCORDANCE WITH THE APPROVED EROSION AND SEDIMENTATION CONTROL (E&S) PLAN. A COPY OF THE APPROVED E&S PLAN (STAMPED, SIGNED AND DATED BY THE REVIEWING AGENCY) MUST BE AVAILABLE AT THE PROJECT SITE AT ALL TIMES. THE REVIEWING AGENCY SHALL BE NOTIFIED OF ANY CHANGES TO THE APPROVED F&S PLAN PRIOR TO IMPLEMENTATION OF THOSE CHANGES. THE REVIEWING AGENCY MAY REQUIRE A WRITTEN

SUBMITTAL OF THOSE CHANGES FOR REVIEW AND APPROVAL AT ITS DISCRETION 2. AT LEAST 7 DAYS PRIOR TO STARTING ANY EARTH DISTURBANCE ACTIVITIES, INCLUDING CLEARING AND GRUBBING, THE OWNER AND/OR OPERATOR SHALL INVITE ALL CONTRACTORS, THE LANDOWNER, APPROPRIATE MUNICIPAL OFFICIALS, THE E&S PLAN PREPARER, THE PCSM PLAN PREPARER, THE LICENSED PROFESSIONAL RESPONSIBLE FOR OVERSIGHT OF CRITICAL STAGES OF IMPLEMENTATION OF THE PCSM PLAN, AND A REPRESENTATIVE FROM THE LOCAL CONSERVATION DISTRICT TO AN ON-SITE PRECONSTRUCTION MEETING

AT LEAST 3 DAYS PRIOR TO STARTING ANY EARTH DISTURBANCE ACTIVITIES. OR EXPANDING INTO AN AREA PREVIOUSLY UNMARKED, THE PENNSYLVANIA ONE CALL SYSTEM INC. SHALL BE NOTIFIED AT 1-800-242-1776 FOR THE LOCATION OF EXISTING UNDERGROUND UTILITIES. 4. ALL EARTH DISTURBANCE ACTIVITIES SHALL PROCEED IN ACCORDANCE WITH THE SEQUENCE PROVIDED ON THE PLAN DRAWINGS. DEVIATION FROM THAT SEQUENCE MUST BE APPROVED IN WRITING FROM THE LOCAL CONSERVATION DISTRICT OR BY THE DEPARTMENT PRIOR TO IMPLEMENTATION.

AREAS TO BE FILLED ARE TO BE CLEARED, GRUBBED, AND STRIPPED OF TOPSOIL TO REMOVE TREES, VEGETATION, ROOTS AND OTHER OBJECTIONABLE MATERIAL. 6. CLEARING, GRUBBING, AND TOPSOIL STRIPPING SHALL BE LIMITED TO THOSE AREAS DESCRIBED IN EACH STAGE OF THE CONSTRUCTION SEQUENCE. GENERAL SITE CLEARING, GRUBBING AND TOPSOIL STRIPPING MAY NOT COMMENCE IN ANY STAGE OR PHASE OF THE PROJECT UNTIL THE E&S BMPS SPECIFIED BY THE BMP SEQUENCE FOR THAT STAGE OR PHASE HAVE BEEN INSTALLED AND ARE FUNCTIONING AS DESCRIBED IN THIS E&S PLAN. 7. AT NO TIME SHALL CONSTRUCTION VEHICLES BE ALLOWED TO ENTER AREAS OUTSIDE THE LIMIT OF

DISTURBANCE BOUNDARIES SHOWN ON THE PLAN MAPS. THESE AREAS MUST BE CLEARLY MARKED AND FENCED OFF BEFORE CLEARING AND GRUBBING OPERATIONS BEGIN. 8. TOPSOIL REQUIRED FOR THE ESTABLISHMENT OF VEGETATION SHALL BE STOCKPILED AT THE LOCATION(S) SHOWN ON THE PLAN MAPS(S) IN THE AMOUNT NECESSARY TO COMPLETE THE FINISH GRADING OF ALL EXPOSED AREAS THAT ARE TO BE STABILIZED BY VEGETATION. EACH STOCKPILE SHALL BE PROTECTED IN THE MANNER SHOWN ON THE PLAN DRAWINGS. STOCKPILE SLOPES SHALL BE 2H:1V OR FLATTER. STOCKPILE HEIGHTS SHALL NOT EXCEED 35 FEET.

9. IMMEDIATELY UPON DISCOVERING UNFORESEEN CIRCUMSTANCES POSING THE POTENTIAL FOR ACCELERATED EROSION AND/OR SEDIMENT POLLUTION, THE OPERATOR SHALL IMPLEMENT APPROPRIATE BEST MANAGEMEN PRACTICES TO MINIMIZE THE POTENTIAL FOR EROSION AND SEDIMENT POLLUTION AND NOTIFY THE LOCAL CONSERVATION DISTRICT AND/OR THE REGIONAL OFFICE OF THE DEPARTMENT. 10. BEFORE INITIATING ANY REVISION TO THE APPROVED EROSION AND SEDIMENT CONTROL PLAN OR REVISIONS

TO OTHER PLANS WHICH MAY AFFECT THE EFFECTIVENESS OF THE APPROVED E&S CONTROL PLAN, THE OPERATOR MUST RECEIVE APPROVAL OF THE REVISIONS FROM THE DELAWARE COUNTY CONSERVATION DISTRICT, THE OPERATOR SHALL ASSURE THAT THE APPROVED EROSION AND SEDIMENT CONTROL PLAN IS PROPERLY AND COMPLETELY

11. ALL BUILDING MATERIALS AND WASTES SHALL BE REMOVED FROM THE SITE AND RECYCLED OR DISPOSED OF IN ACCORDANCE WITH THE DEPARTMENT'S SOLID WASTE MANAGEMENT REGULATIONS AT 25 PA. CODE 260.1 ET SEQ., 271.1, AND 287.1 ET. SEG. NO BUILDING MATERIALS OR WASTES OR UNUSED BUILDING MATERIALS SHALL BE BURNED, BURIED, DUMPED, OR DISCHARGED AT THE SITE. 12. ALL OFF-SITE WASTE AND BORROW AREAS MUST HAVE AN E&S PLAN APPROVED BY THE LOCAL CONSERVATION DISTRICT OR THE DEPARTMENT FULLY IMPLEMENTED PRIOR TO BEING ACTIVATED.

13. THE CONTRACTOR IS RESPONSIBLE FOR ENSURING THAT ANY MATERIAL BROUGHT ON SITE IS CLEAN FILL FORM FP-001 MUST BE RETAINED BY THE PROPERTY OWNER FOR ANY FILL MATERIAL AFFECTED BY A SPILL OR RELEASE OF A REGULATED SUBSTANCE BUT QUALIFYING AS CLEAN FILL DUE TO ANALYTICAL TESTING. 14. ALL PUMPING OF WATER FROM ANY WORK AREA SHALL BE DONE ACCORDING TO THE PROCEDURE DESCRIBED IN THIS PLAN, OVER UNDISTURBED VEGETATED ARES 15. VEHICLES AND EQUIPMENT MAY NEITHER ENTER NOR EXIT DIRECTLY FROM THE PROJECT SITE ONTO WEST

16. UNTIL THE SITE IS STABILIZED, ALL EROSION AND SEDIMENTATION BMP'S MUST BE MAINTAINED PROPERLY. MAINTENANCE MUST INCLUDE INSPECTIONS OF ALL EROSION AND SEDIMENTATION BMP'S AFTER EACH RUNOFF EVENT AND ON A WEEKLY BASIS. ALL SITE INSPECTIONS, THE COMPLIANCE INSPECTIONS, AND THE DATE, TIME, AND NAME OF THE PERSON CONDUCTING THE INSPECTION WILL BE DOCUMENTED IN AN INSPECTION LOG KEPT FOR THIS PURPOSE. THE INSPECTION LOG WILL BE KEPT ON SITE AT ALL TIMES AND MADE AVAILABLE TO THE DISTRIC UPON REQUEST. ALL PREVENTATIVE AND REMEDIAL MAINTENANCE WORK, INCLUDING CLEAN OUT, REPAIR, replacement, regrading, reseeding, remulching, and renetting, must be performed immediately. If EROSION AND SEDIMENTATION BMP'S FAIL TO PERFORM AS EXPECTED, REPLACEMENT BMP'S OR MODIFICATIONS OF THOSE INSTALLED WILL BE NEEDED, WHERE BMP'S ARE FOUND TO FAIL TO ALLEVIATE EROSION AND SEDIMENT POLLUTION THE PERMITTEE OR CO-PERMITTEE SHALL INCLUDE THE FOLLOWING INFORMATION: A. THE LOCATION AND SEVERITY OF THE BMP'S FAILURE AND ANY POLLUTION EVENTS. B. ALL STEPS TAKEN TO REDUCE, ELIMINATE AND PREVENT THE RECURRENCE OF THE

NON-COMPLIANCE. C. THE TIME FRAME TO CORRECT THE NON-COMPLIANCE, INCLUDING THE EXACT DATES WHEN THE ACTIVITY WILL RETURN TO COMPLIANCE AFTER FINAL SITE STABILIZATION HAS BEEN ACHIEVED, TEMPORARY EROSION AND SEDIMENT BMP'S MUST BE REMOVED. AREAS DISTURBED DURING THEIR REMOVAL OF THE BMP'S MUST BE STABILIZED IMMEDIATELY. 17. SEDIMENT TRACKED ONTO ANY PUBLIC ROADWAY OR SIDEWALK SHALL BE RETURNED TO THE SITE IMMEDIATELY AND DISPOSED IN THE MANNER DESCRIBED IN THIS PLAN. IN NO CASE SHALL THE SEDIMENT BE WASHED,

SHOVELED, OR SWEPT INTO ANY ROADSIDE DITCH, STORM SEWER, OR SURFACE WATER. 18. ALL SEDIMENT REMOVED FROM BMPS SHALL BE DISPOSED OF IN THE MANNER DESCRIBED ON THE PLAN 19. AREAS WHICH ARE TO BE TOP SOILED SHALL BE SCARIFIED TO A MINIMUM DEPTH OF 3 TO 5 INCHES — 6
TO 12 INCHES ON COMPACTED SOILS — PRIOR TO PLACEMENT OF TOPSOIL. AREAS TO BE VEGETATED SHALL HAVE
A MINIMUM 4 INCHES OF TOPSOIL IN PLACE PRIOR TO SEEDING AND MULCHING. FILL OUTSLOPES SHALL HAVE A

20. ALL FILLS SHALL BE COMPACTED AS REQUIRED TO REDUCE EROSION, SLIPPAGE, SETTLEMENT, SUBSIDENCE or other related problems. Fill intended to support buildings, structures and conduits, etc. shall BE COMPACTED IN ACCORDANCE WITH LOCAL REQUIREMENTS OR CODES. ALL EARTHEN FILLS SHALL BE PLACED IN COMPACTED LAYERS NOT TO EXCEED 9 INCHES IN THICKNESS. 22. FILL MATERIALS SHALL BE FREE OF BRUSH, ROOTS, SOD, OR OTHER FOREIGN OR OBJECTIONABLE MATERIALS

THAT WOULD INTERFERE WITH OR PREVENT CONSTRUCTION OF SATISFACTORY FILLS. FROZEN MATERIALS OR SOFT, MUCKY, OR HIGHLY COMPRESSIBLE MATERIALS SHALL NOT BE INCORPORATED INTO FILLS. FILL SHALL NOT BE PLACED ON SATURATED OR FROZEN SURFACES. SEEPS OR SPRINGS ENCOUNTERED DURING CONSTRUCTION SHALL BE HANDLED IN ACCORDANCE WITH THE STANDARD AND SPECIFICATION FOR SUBSURFACE DRAIN OR OTHER APPROVED METHOD.

ALL GRADED AREAS SHALL BE PERMANENTLY STABILIZED IMMEDIATELY UPON REACHING FINISHED GRADE. CUT SLOPES IN COMPETENT BEDROCK AND ROCK FILLS NEED NOT BE VEGETATED. SEEDED AREAS WITHIN 50 FEET OF A SURFACE WATER, OR AS OTHERWISE SHOWN ON THE PLAN DRAWINGS, SHALL BE BLANKETED ACCORDING TO THE STANDARDS OF THIS PLAN, EROSION CONTROL BLANKET IS REQUIRED TO STABILIZE ALL SLOPES 3:1 AND GREATER. ALL EROSION CONTROL BLANKET SHALL BE NORTH AMERICAN GREEN \$75 OR APPROVED EQUAL. 26. IMMEDIATELY AFTER EARTH DISTURBANCE ACTIVITIES CEASE IN ANY AREA OR SUBAREA OF THE PROJECT. PERATOR SHALL STABILIZE ALL DISTURBED AREAS. DURING NON-GERMINATING MONTHS, MULCH OR PROTECTIVE BLANKETING SHALL BE APPLIED AS DESCRIBED IN THE PLAN. AREAS NOT AT FINISHED GRADE, WHICH WILL BE REACTIVATED WITHIN 1 YEAR, MAY BE STABILIZED IN ACCORDANCE WITH THE TEMPORARY STABILIZATION SPECIFICATIONS. THOSE AREAS WHICH WILL NOT BE REACTIVATED WITHIN 1 YEAR SHALL BE STABILIZED IN

ACCORDANCE WITH THE PERMANENT STABILIZATION SPECIFICATIONS. PERMANENT STABILIZATION IS DEFINED AS A MINIMUM UNIFORM, PERFENNIAL 70% VEGETATIVE COVER OR OTHER PERMANENT NON-VEGETATIVE COVER WITH A DENSITY SUFFICIENT TO RESIST ACCELERATED EROSION. CUT AND FILL SLOPES SHALL BE CAPABLE OF RESISTING FAILURE DUE TO SLUMPING, SLIDING, OR OTHER MOVEMENTS. E&S BMPS SHALL REMAIN FUNCTIONAL AS SUCH UNTIL ALL AREAS TRIBUTARY TO THEM ARE PERMANENTLY STABILIZED OR UNTIL THEY ARE REPLACED BY ANOTHER BMP APPROVED BY THE LOCAL CONSERVATION DISTRICT OR

THE DEPARTMENT 29. UPON COMPLETION OF ALL EARTH DISTURBANCE ACTIVITIES AND PERMANENT STABILIZATION OF ALL DISTURBED AREAS, THE OWNER AND/OR OPERATOR SHALL CONTACT THE LOCAL CONSERVATION DISTRICT FOR AN INSPECTION PRIOR TO REMOVAL/CONVERSION OF THE E&S BMPS. 30. AFTER FINAL SITE STABILIZATION HAS BEEN ACHIEVED, TEMPORARY EROSION AND SEDIMENT BMPS MUST BE REMOVED OR CONVERTED TO PERMANENT POST CONSTRUCTION STORMWATER MANAGEMENT BMPS. AREAS DISTURBED DURING REMOVAL OR CONVERSION OF THE BMPS SHALL BE STABILIZED IMMEDIATELY. IN ORDER TO ENSURE RAPID

REVEGETATION OF DISTURBED AREAS, SUCH REMOVAL/CONVERSIONS ARE TO BE DONE ONLY DURING THE GERMINATING SEASON 31. UPON COMPLETION OF ALL EARTH DISTURBANCE ACTIVITIES AND PERMANENT STABILIZATION OF ALL DISTURBED AREAS, THE OWNER AND/OR OPERATOR SHALL CONTACT THE LOCAL CONSERVATION DISTRICT TO

SCHEDULE A FINAL INSPECTION. 32. FAILURE TO CORRECTLY INSTALL E&S BMPS, FAILURE TO PREVENT SEDIMENT-LADEN RUNOFF FROM LEAVING THE CONSTRUCTION SITE OR FAILURE TO TAKE IMMEDIATE CORRECTIVE ACTION TO RESOLVE FAILURE OF E&S BMPS MAY RESULT IN ADMINISTRATIVE, CIVIL, AND/OR CRIMINAL PENALTIES BEING INSTITUTED BY THE DEPARTMENT AS DEFINED IN SECTION 602 OF THE PENNSYLVANIA CLEAN STREAMS LAW. THE CLEAN STREAMS LAW PROVIDES FOR UP TO \$10,000 PER DAY IN CIVIL PENALTIES, UP TO \$10,000 IN SUMMARY CRIMINAL PENALTIES, AND UP O \$25,000 IN MISDEMEANOR CRIMINAL PENALTIES FOR EACH VIOLATION.

33. SHOULD ANY MEASURES CONTAINED WITHIN THIS PLAN PROVE INCAPABLE OF ADEQUATELY REMOVING SEDIMENT FROM ON-SITE FLOWS PRIOR TO DISCHARGE OR STABILIZING THE SURFACES INVOLVED, ADDITIONAL MEASURES MUST BE IMMEDIATELY IMPLEMENTED BY THE DEVELOPER TO ELIMINATE ALL SUCH PROBLEMS. THE DELAWARE COUNTY CONSERVATION DISTRICT MUST BE NOTIFIED BY THE DEVELOPER OF ANY AND ALL CHANGES OR MODIFICATIONS TO THE CONTROLS. 34. THE CONTRACTOR IS ADVISED TO BECOME THOROUGHLY FAMILIAR WITH THE PROVISION OF APPENDIX 64

EROSION CONTROL RULES AND REGULATIONS, TITLE 25, PART 1, DEPARTMENT OF ENVIRONMENTAL PROTECTION SUB-PART C, PROTECTION OF NATURAL RESOURCES. ARTICLE III, WATER RESOURCES, CHAPTER 102, EROSION THE PROPOSED CONSERVATION MEASURES MUST BE IN COMPLIANCE WITH PADEP CHAPTER 102 REGULATIONS.

THE PROJECT'S NEAREST SURFACE WATER IS VALLEY RUN. THE CHAPTER 93 CLASSIFICATION IS CWF/MF-COLD WATER FISHES / MIGRATORY FISHES WATERWAY. 37. UPON THE INSTALLATION OR STABILIZATION OF ALL PERIMETER SEDIMENT CONTROL BMPS AND AT LEAST 3 DAYS PRIOR TO PROCEEDING WITH THE BULK EARTH DISTURBANCE ACTIVITIES, THE PERMITTEE OR CO-PERMITTEE SHALL PROVIDE NOTIFICATION TO THE DEPARTMENT OR AUTHORIZED CONSERVATION DISTRIC 38. CONCRETE WASH WATER SHALL BE HANDLED IN THE MANNER DESCRIBED ON THE PLAN DRAWINGS. IN NO CASE SHALL IT BE ALLOWED TO ENTER ANY SURFACE WATERS OR GROUNDWATER SYSTEMS.

39. CLEAN FILL IS DEFINED AS: UNCONTAMINATED, NON-WATER SOLUBLE, NON-DECOMPOSABLE, INERT SOLID MATERIAL. THE TERM INCLUDES SOIL, ROCK, STONE, DREDGED MATERIAL, USED ASPHALT, AND BRICK, BLOCK, OR CONCRETE FROM CONSTRUCTION AND DEMOLITION ACTIVITIES THAT IS SEPARATE FROM OTHER WASTE AND IS RECOGNIZABLE AS SUCH. THE TERM DOES NOT INCLUDE MATERIALS PLACED IN OR ON THE WATERS OF THE COMMONWEALTH UNLESS OTHERWISE AUTHORIZED. (THE TERM "USED" ASPHALT DOES NOT INCLUDE MILLED ASPHALT OR ASPHALT THAT HAS BEEN PROCESSED FOR RE-USE). CLEAN FILL AFFECTED BY A SPILL OR RELEASE OF A REGULATED SUBSTANCE: FILL MATERIALS AFFECTED BÝ A SPILL OR RELEASE OF A REGULATED SUBSTANCE STILL QUALIFIES AS CLEAN FILL PROVIDED THE TESTING REVEALS THAT THE FILL MATERIAL CONTAINS CONCENTRATIONS OF REGULATED SUBSTANCES THAT ARE BELOW THE RESIDENTIAL LIMITS IN TABLES FP-1g AND FP-1b FOUND IN HE DEPARTMENT'S POLICY "MANAGEMENT OF FILL". ANY PERSON PLACING CLEAN FILL THAT HAS BEEN AFFECTED BY A SPILL OR RELEASE OF A REGULATED SUBSTANCE MUST USE FORM FP-001 TO CERTIFY THE ORIGIN OF THE ILL MATERIAL AND THE RESULTS OF THE ANALYTICAL TESTING TO QUALIFY THE MATERIAL AS CLEAN FILL. FORM FP-001 MUST BE RETAINED BY THE OWNER OF THE PROPERTY RECEIVING THE FILL. A COPY OF FORM FP-001 CAN BE FOUND AT THE END OF THESE INSTRUCTIONS ON THE DEPARTMENT'S WEBSITE. ENVIRONMENTAL DUE DILIGENCE: THE APPLICANT MUST PERFORM DUE DILIGENCE TO DETERMINE IF THE FILL MATERIALS ASSOCIATED WITH THE PROJECT QUALIFY AS CLEAN FILL ENVIRONMENTAL DUE DILIGENCE IS DEFINED AS: INVESTIGATIVE TECHNIQUES INCLUDING, BUT NOT LIMITED TO, VISUAL PROPERTY INSPECTIONS, ELECTRONIC DATA BASE SEARCHES, REVIEW OF PROPERTY OWNERSHIP, REVIEW OF PROPERTY USE HISTORY, SANBORN MAPS, ENVIRONMENTAL QUESTIONNAIRES, TRANSACTION SCREENS, ANALYTICAL TESTING, ENVIRONMENTAL ASSESSMENTS OR AUDITS. ANALYTICAL TESTING IS NOT A REQUIRED PART OF DUE DILIGENCE UNLESS VISUAL INSPECTION AND/OR REVIEW OF THE PAST LAND USE OF THE PROPERTY INDICATES THAT THE FILL MAY HAVE BEEN SUBJECTED TO A SPILL OR RELEASE OF A REGULATED SUBSTANCE. IF THE FILL MAY HAVE BEEN AFFECTED BY A SPILL OR RELEASE OF A REGULATED SUBSTANCE, IT

GENERAL NOTES FOR UTILITY CONSTRUCTION

EXCAVATED MATERIAL SHOULD BE STAGED ON THE UPSTREAM SIDE OF A TRENCH. THE DAILY EXTENT OF TRENCHING SHOULD NOT EXCEED WHAT CAN BE BACKFILLED AND STABILIZED IN ONE WORKING DAY. LIMIT ADVANCED CLEARING AND GRUBBING OPERATIONS TO A DISTANCE EQUAL TO TWO TIMES THE LENGTH OF PIPE INSTALLATION THAT CAN BE

MUST BE TESTED TO DETERMINE IF IT QUALIFIES AS CLEAN FILL. TESTING SHOULD BE PERFORMED IN

ACCORDANCE WITH APPENDIX A OF THE DEPARTMENT'S POLICY "MANAGEMENT OF FILL".

4. WORK CREWS AND EQUIPMENT FROM TRENCHING, PLACEMENT OF PIPE, AND BACKFILLING WILL BE SELF CONTAINED AND SEPARATE FROM CLEARING AND GRUBBING AND SITE RESTORATION AND STABILIZATION OPERATIONS. WATER WHICH ACCUMULATES IN THE OPEN TRENCH WILL BE COMPLETELY REMOVED BY PUMPING BEFORE PIPE PLACEMENT AND/OR BACKFILLING BEGINS. WATER REMOVED FROM THE TRENCH SHALL BE PUMPED THROUGH A

ON THE DAY FOLLOWING PIPE PLACEMENT AND TRENCH BACKFILLING, THE DISTURBED AREA WILL BE GRADED TO FINAL CONTOURS AND IMMEDIATELY STABILIZED. SOILS EXCAVATED FROM EXISTING SURFACE LAYER SHOULD BE STOCKPILED SEPARATELY AND RETURNED AS INAL SURFACE LAYER FOLLOWING TRENCH BACKFILLING.

ANTICIPATED E&S BMP RELATED CONSTRUCTION WASTES AND DISPOSAL PROCEDURES

TRASH & LITTER

SILT REMOVED FROM TEMPORARY SEDIMENT CONTROL STRUCTURES SHALL BE DISPOSED OF ON-SITE IN LANDSCAPED AREAS LOCATED


OUTSIDE OF FLOOD PLAINS, WETLANDS, STEEP SLOPES, AND DRAINAGE SWALES. SILT AND SEDIMENT CATEGORIZED AS CONTAMINATED SHALL DISPOSED OF PER THE SOIL MANAGEMENT NOTES.

ONSITE. ONCE WASHWATER SOLIDIFIES THE HARDENED CONCRETE SHALL BE

TRASH AND LITTER SHALL BE REMOVED FROM EROSION AND SEDIMENTATION CONTROL BMPS AND DISPOSED OF IN APPROPRIATE TRASH RECEPTACLE. CONCRETE WASHWATER CONCRETE WASHWATER SHALL BE DISPOSED OF IN THE LOCATION SHOWN

DISPOSED OF OFF-SITE IN AN APPROVED MANNER

NOTE: ANY APPLICABLE MATERIAL SHALL BE RECYCLED IN ACCORDANCE TO THE APPROPRIATE REGULATIONS.

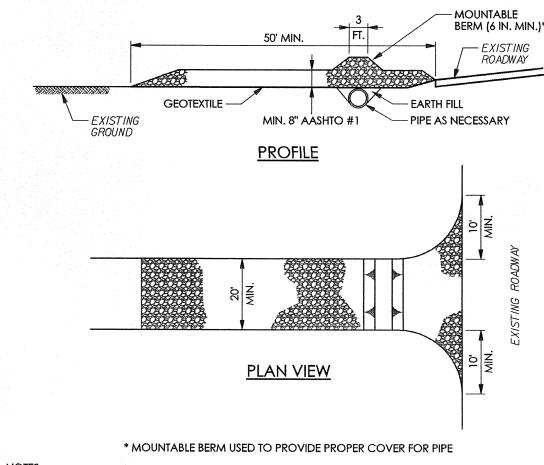

REMOVE TOPSOIL PRIOR TO INSTALLATION OF ROCK CONSTRUCTION ENTRANCE. EXTEND ROCK OVER FULL

OF DITCH BEING CROSSED.

OPTIONAL 6 IN. COMPOST LAYER

OPTIONAL 6 IN. SUMP

AASHTO NO. 57

FIRMLY ANCHORED

OR FILTER FABRIC

---- R-3 ROCK

WOOD POSTS

HEIGHT OF ROCK ---

FILTER = 5 HEIGHT

OF STRAW BALES OR FILTER FABRIC FENCE

UPSLOPE FACE IN HQ AND EV WATERSHEDS.

OUTLET CROSS-SECTION

3 FT. MIN.

UP-SLOPE FACE

A ROCK FILTER OUTLET SHALL BE INSTALLED WHERE FAILURE OF A SILT FENCE OR STRAW BALE BARRIER

STANDARD CONSTRUCTION DETAIL #4-6

ROCK FILTER OUTLET

NOT TO SCALE

HAS OCCURRED DUE TO CONCENTRATED FLOW. ANCHORED COMPOST LAYER SHALL BE USED ON


SEDIMENT SHALL BE REMOVED WHEN ACCUMULATIONS REACH 1/3 THE HEIGHT OF THE OUTLET.

RUNOFF SHALL BE DIVERTED FROM ROADWAY TO A SUITABLE SEDIMENT REMOVAL BMP PRIOR TO ENTERING MOUNTABLE BERM SHALL BE INSTALLED WHEREVER OPTIONAL CULVERT PIPE IS USED AND PROPER PIPE COVER AS SPECIFIED BY MANUFACTURER IS NOT OTHERWISE PROVIDED. PIPE SHALL BE SIZED APPROPRIATELY FOR SIZE

MAINTENANCE: ROCK CONSTRUCTION ENTRANCE THICKNESS SHALL BE CONSTANTLY MAINTAINED TO THE SPECIFIED DIMENSIONS BY ADDING ROCK. A STOCKPILE SHALL BE MAINTAINED ON SITE FOR THIS PURPOSE. ALL SEDIMENT DEPOSITED ON PAVED ROADWAYS SHALL BE REMOVED AND RETURNED TO THE CONSTRUCTION SITE MMEDIATELY. IF EXCESSIVE AMOUNTS OF SEDIMENT ARE BEING DEPOSITED ON ROADWAY, EXTEND LENGTH OF ROCK CONSTRUCTION ENTRANCE BY 50 FOOT INCREMENTS UNTIL CONDITION IS ALLEVIATED OR INSTALL WASH RACK. WASHING THE ROADWAY OR SWEEPING THE DEPOSITS INTO ROADWAY DITCHES, SEWERS, CULVERTS, OR OTHER DRAINAGE COURSES IS NOT ACCEPTABLE.


STANDARD CONSTRUCTION DETAIL #3-1 ROCK CONSTRUCTION ENTRANCE NOT TO SCALE

> WELL VEGETATED, GRASSY AREA DISCHARGE HOSE INTAKE HOSE - HEAVY DUTY LIFTING STRAPS (RECOMMENDED) PLAN VIEW

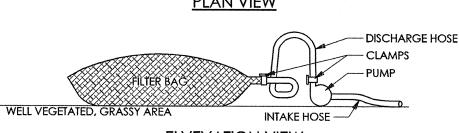

<u>ELVEVATION VIEW</u>

LOW VOLUME FILTER BAGS SHALL BE MADE FROM NON-WOVEN GEOTEXTILE MATERIAL SEWN WITH HIGH STRENGTH, DOUBLE STITCHED "J" TYPE SEAMS. THEY SHALL BE CAPABLE OF TRAPPING PARTICLES LARGER HAN 150 MICRONS. HIGH VOLUME FILTER BAGS SHALL BE MADE FROM WOVEN GEOTEXTILES THAT MEET THE FOLLOWING STANDARDS:

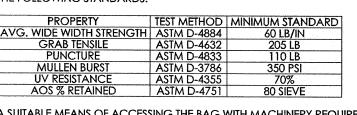

A SUITABLE MEANS OF ACCESSING THE BAG WITH MACHINERY REQUIRED FOR DISPOSAL PURPOSES SHALL BE PROVIDED. FILTER BAGS SHALL BE REPLACED WHEN THEY BECOME 1/2 FULL OF SEDIMENT. SPARE BAGS SHALL BE KEPT AVAILABLE FOR REPLACEMENT OF THOSE THAT HAVE FAILED OR ARE FILLED. BAGS SHALL BE PLACED ON STRAPS TO FACILITATE REMOVAL UNLESS BAGS COME WITH LIFTING STRAPS ALREADY ATTACHED. BAGS SHALL BE LOCATED IN WELL-VEGETATED (GRASSY) AREA, AND DISCHARGE ONTO STABLE, EROSION RESISTANT AREAS. WHERE THIS IS NOT POSSIBLE, A GEOTEXTILE UNDERLAYMENT AND FLOW PATH SHALL BE PROVIDED. BAGS MAY BE PLACED ON FILTER STONE TO INCREASE DISCHARGE CAPACITY, BAGS SHALL NOT BE

PLACED ON SLOPES GREATER THAN 5%. FOR SLOPES EXCEEDING 5%, CLEAN ROCK OR OTHER NON-ERODIBLE AND NON-POLLUTING MATERIAL MAY BE PLACED UNDER THE BAG TO REDUCE SLOPE STEEPNESS. NO DOWNSLOPE SEDIMENT BARRIER IS REQUIRED FOR MOST INSTALLATIONS. COMPOST BERM OR COMPOST FILTER SOCK SHALL BE INSTALLED BELOW BAGS LOCATED IN HQ OR EV WATERSHEDS, WITHIN 50 FEET OF ANY RECEIVING SURFACE WATER OR WHERE GRASSY AREA IS NOT AVAILABLE.

THE PUMP DISCHARGE HOSE SHALL BE INSERTED INTO THE BAGS IN THE MANNER SPECIFIED BY THE MANUFACTURER AND SECURELY CLAMPED. A PIECE OF PVC PIPE IS RECOMMENDED FOR THIS PURPOSE. THE PUMPING RATE SHALL BE NO GREATER THAN 750 GPM OR 1/2 THE MAXIMUM SPECIFIED BY THE MANUFACTURER, WHICHEVER IS LESS. PUMP INTAKES SHALL BE FLOATING AND SCREENED. FILTER BAGS SHALL BE INSPECTED DAILY. IF ANY PROBLEM IS DETECTED, PUMPING SHALL CEASE IMMEDIATELY

STANDARD CONSTRUCTION DETAIL #3-16 PUMPED WATER FILTER BAG NOT TO SCALE



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PRELIM. LAND DEVELOPMENT SUBMISSION

Revision


March 13, 2015 Title Erosion & Sedimentation Control Detail Sheet


N.T.S. Scale Drawn By DWN

Sheet No

Contractor to verify all dimensions in field and inform


AND NOT RESUME UNTIL THE PROBLEM IS CORRECTED.

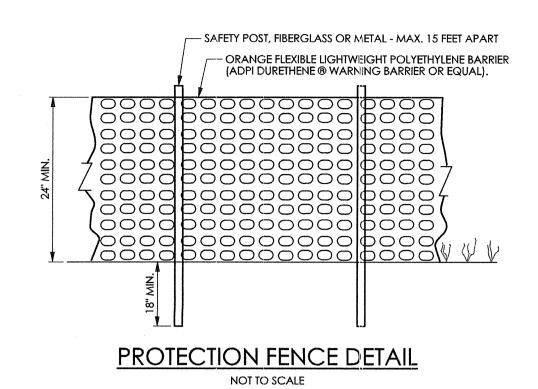

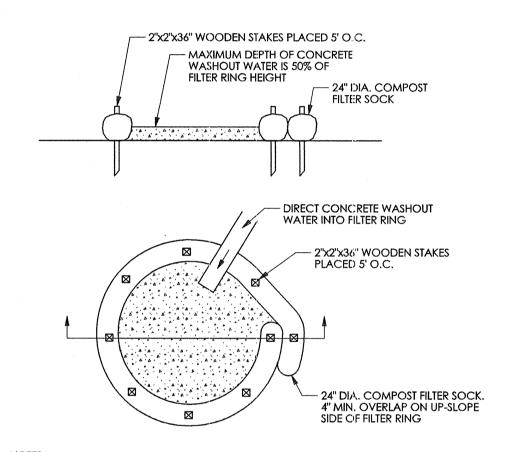

A SUITABLE IMPERVIOUS GEO-MEMBRANE SHALL BE PLACED AT THE LOCATION OF THE WASHOUT PRIOR TO INSTALLING THE SOCKS.
INSTALL ON FLAT GRADE FOR OPTIMUM PERFORMANCE. 18" DIAMETER FILTER SOCKS MAY BE STACKED ONTO DOUBLE 24" DIAMETER SOCKS IN PYRAMIDAL CONFIGURATION FOR ADDEDHEIGHT. ALL CONCRETE WASHOUT FACILITIES SHOULD BE INSPECTED DAILY. DAMAGED OR LEAKING WASHOUTS SHOULD BE DEACTIVATED AND REPAIRED OR REPLACED IMMEDIATELY.

> CONTROLLED NON-DISCHARGE **CONCRETE WASH OUT** NOT TO SCALE

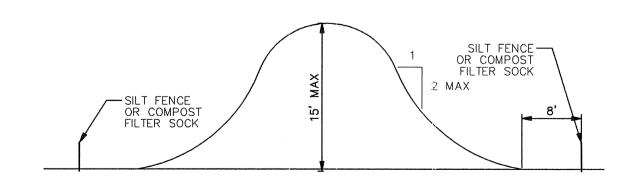


TYPICAL SOIL STOCKPILE CROSS SECTION

NOT TO SCALE

SILT FENCE MUST COMPLETELY ENCIRCLE STOCKPILE

TOPSOIL SHALL NOT BE REMOVED FROM THE DEVELOPMENT SITE OR USED AS FILL. TOPSOIL SHALL BE REMOVED FROM THE AREAS OF CONSTRUCTION AND STORED SEPARATELY. THE TOPSOIL SHALL BE STABILIZED TO MINIMIZE EROSION DURING STORAGE. UPON COMPLETION OF CONSTRUCTION, THE TOPSOIL SHALL BE UNIFORMLY REDISTRIBUTED ON THE SITE.

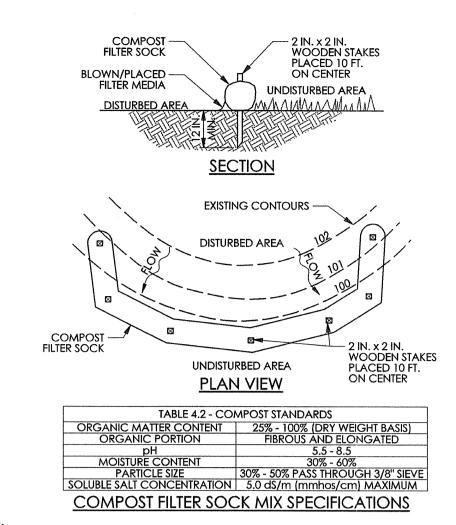

SOCK FABRIC SHALL MEET STANDARDS OF TABLE 4.1 OF THE PA DEP EROSION CONTROL MANUAL. COMPOST COMPOST FILTER SOCK SHALL BE PLACED AT EXISTING LEVEL GRADE, BOTH ENDS OF THE BARRIER SHALL BE EXTENDED AT LEAST 8 FEET UP SLOPE AT 45 DEGREES TO THE MAIN BARRIER ALIGNMENT. MAXIMUM SLOPE LENGTH ABOVE ANY BARRIER SHALL NOT EXCEED THAT SPECIFIED FOR THE SIZE OF THE SOCK AND THE SLOPE OF ITS TRIBUTARY AREA.

TRAFFIC SHALL NOT BE PERMITTED TO CROSS COMPOST FILTER SOCKS.


ACCUMULATED SEDIMENT SHALL BE REMOVED WHEN IT REACHES 1/2 THE ABOVE GROUND HEIGHT OF THE BARRIER AND DISPOSED IN THE MANNER DESCRIBED ELSEWHERE IN THE PLAN. COMPOST FILTER SOCKS SHALL BE INSPECTED WEEKLY AND AFTER EACH RUNOFF EVENT, DAMAGED SOCKS SHALL BE REPAIRED ACCORDING TO MANUFACTURER'S SPECIFICATIONS OR REPLACED WITHIN 24 HOURS

BIODEGRADABLE COMPOST FILTER SOCKS SHALL BE REPLACED AFTER 6 MONTHS; PHOTODEGRADABLE SOCKS AFTER 1 YEAR. POLYPROPYLENE SOCKS SHALL BE REPLACED ACCORDING TO MANUFACTURER'S

UPON STABILIZATION OF THE AREA TRIBUTARY TO THE SOCK, STAKES SHALL BE REMOVED. THE SOCK MAY BE LEFT IN PLACE AND VEGETATED OR REMOVED. IN THE LATTER CASE, THE MESH SHALL BE CUT OPEN AND THE MULCH SPREAD AS A SOIL SUPPLEMENT. WHERE SOCKS ARE PLACED ON PAVED SURFACES, CONCRETE BLOCKS SHOULD BE USED IMMEDIATELY

> STANDARD CONSTRUCTION DETAIL #4-1 COMPOST FILTER SOCK

DOWNSLOPE OF THE SOCKS (AT THE SAME INTERVALS RECOMMENDED FOR THE STAKES) TO HELP HOLD THE SOCK IN PLACE.

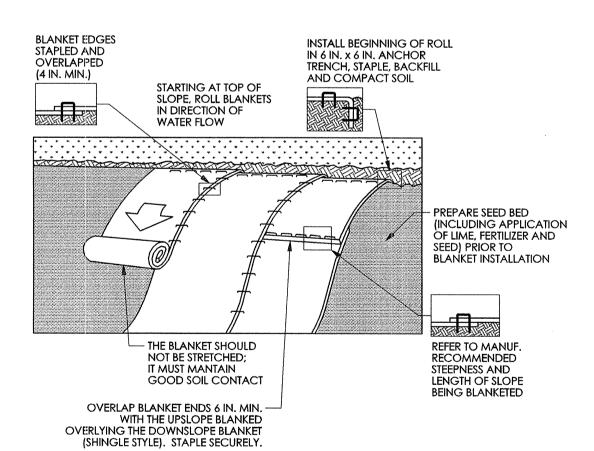

SEED AND SOIL AMENDMENTS SHALL BE APPLIED ACCORDING TO THE RATES IN THE PLAN DRAWINGS PRIOR TO


PROVIDE ANCHOR TRENCH AT TOE OF SLOPE IN SIMILAR FASHION AS AT TOP OF SLOPE. SLOPE SURFACE SHALL BE FREE OF ROCKS, CLODS, STICKS, AND GRASS.

BLANKET SHALL HAVE GOOD CONTINUOUS CONTACT WITH UNDERLYING SOIL THROUGHOUT ENTIRE LENGTH. LAY BLANKET LOOSELY AND STAKE OR STAPLE TO MAINTAIN DIRECT CONTACT WITH SOIL. DO NOT STRETCH

THE BLANKET SHALL BE STAPLED IN ACCORDANCE WITH THE MANUFACTURER'S RECOMMENDATIONS.

BLANKETED AREAS SHALL BE INSPECTED WEEKLY AND AFTER EACH RUNOFF EVENT UNTIL PERENNIAL VEGETATION IS ESTABLISHED TO A MINIMUM UNIFORM 70% COVERAGE THROUGHOUT THE BLANKETED AREA. DAMAGED OR DISPLACED BLANKETS SHALL BE RESTORED OR REPLACED WITHIN 4 CALENDAR DAYS.

STANDARD CONSTRUCTION DETAIL #11-1 EROSION CONTROL BLANKET INSTALLATION NOT TO SCALE

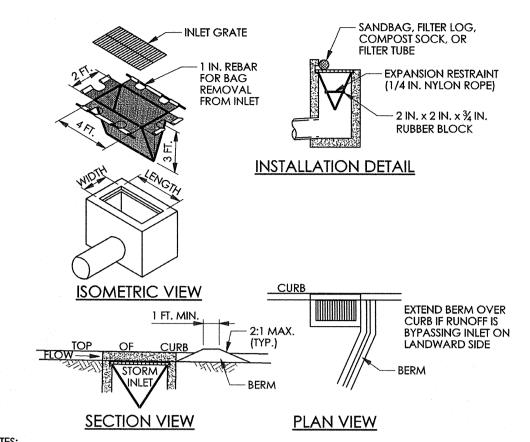

MAXIMUM DRAINAGE AREA = 1/2 ACRE.


INLET PROTECTION SHALL NOT BE REQUIRED FOR INLET TRIBUTARY TO SEDIMENT BASIN OR TRAP. BERMS SHALL BE REQUIRED FOR ALL INSTALLATIONS.

ROLLED EARTHEN BERM SHALL BE MAINTAINED UNTIL ROADWAY IS STONED. ROAD SUBBASE BERM SHALL BE MAINTAINED UNTIL ROADWAY IS PAVED. SIX INCH MINIMUM HEIGHT ASPHALT BERM SHALL BE MAINTAINED UNTIL ROADWAY SURFACE RECEIVES FINAL COAT. AT A MINIMUM, THE FABRIC SHALL HAVE A MINIMUM GRAB TENSILE STRENGTH OF 120 LBS, A MINIMUM BURST STRENGTH OF 200 PSI, AND A MINIMUM TRAPEZOIDAL TEAR STRENGTH OF 50 LBS. FILTER BAGS SHALL BE CAPABLE OF TRAPPING ALL PARTICLES NOT PASSING A NO. 40 SIEVE.


INLET FILTER BAGS SHALL BE INSPECTED ON A WEEKLY BASIS AND AFTER EACH RUNOFF EVENT. BAGS SHALL BE EMPTIED AND RINSED OR REPLACED WHEN HALF FULL OR WHEN FLOW CAPACITY HAS BEEN REDUCED SO AS TO CAUSE FLOODING OR BYPASSING OF THE INLET. DAMAGED OR CLOGGED BAGS SHALL BE REPLACED. A SUPPLY SHALL BE MAINTAINED ON SITE FOR REPLACEMENT OF BAGS, ALL NEEDED REPAIRS SHALL BE INITIATED IMMEDIATELY AFTER THE INSPECTION. DISPOSE OF ACCUMULATED SEDIMENT AS WELL AS ALL USED BAGS ACCORDING TO THE PLAN NOTES.

DO NOT USE ON MAJOR PAVED ROADWAYS WHERE PONDING MAY CAUSE TRAFFIC HAZARDS.

STANDARD CONSTRUCTION DETAIL #4-15 FILTER BAG INLET PROTECTION - TYPE C INLET NOT TO SCALE

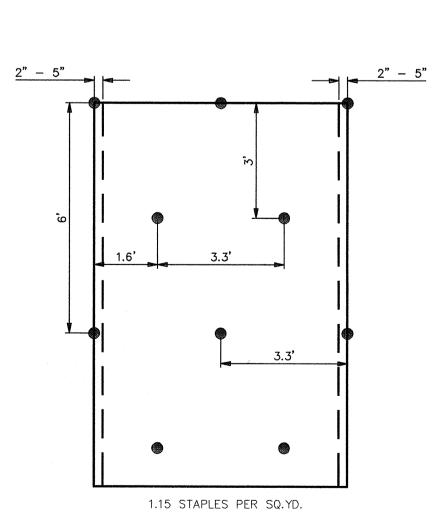

EROSION CONTROL BLANKET STAPLE PATTERN NOT TO SCALE

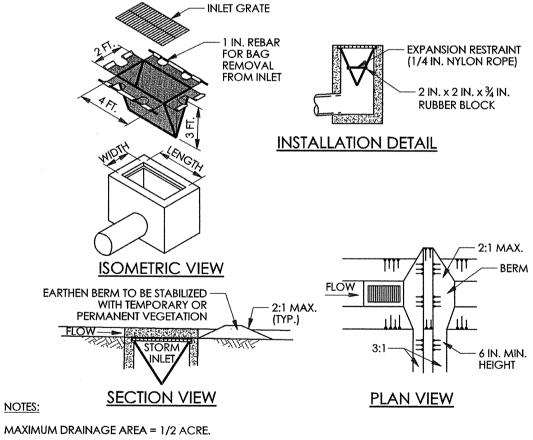

INLET PROTECTION SHALL NOT BE REQUIRED FOR INLET TRIBUTARY TO SEDIMENT BASIN OR TRAP. BERMS SHALL BE REQUIRED FOR ALL INSTALLATIONS.

ROLLED EARTHEN BERM IN ROADWAY SHALL BE MAINTAINED UNTIL ROADWAY IS STONED. ROAD SUBBASE BERM ON ROADWAY SHALL BE MAINTAINED UNTIL ROADWAY IS PAVED. EARTHEN BERM IN CHANNEL SHALL BE MAINTAINED UNTIL PERMANENT STABILIZATION IS COMPLETED OR REMAIN PERMANENTLY. AT A MINIMUM, THE FABRIC SHALL HAVE A MINIMUM GRAB TENSILE STRENGTH OF 120 LBS., A MINIMUM BURST

CAPABLE OF TRAPPING ALL PARTICLES NOT PASSING A NO. 40 SIEVE. INLET FILTER BAGS SHALL BE INSPECTED ON A WEEKLY BASIS AND AFTER EACH RUNOFF EVENT. BAGS SHALL BE EMPTIED AND RINSED OR REPLACED WHEN HALF FULL OR WHEN FLOW CAPACITY HAS BEEN REDUCED SO AS TO CAUSE FLOODING OR BYPASSING OF THE INLET. DAMAGED OR CLOGGED BAGS SHALL BE REPLACED. A SUPPLY SHALL BE MAINTAINED ON SITE FOR REPLACEMENT OF BAGS, ALL NEEDED REPAIRS SHALL BE

INITIATED IMMEDIATELY AFTER THE INSPECTION. DISPOSE ACCUMULATED SEDIMENT AS WELL AS ALL USED

STRENGTH OF 200 PSI, AND A MINIMUM TRAPEZOIDAL TEAR STRENGTH OF 50 LBS. FILTER BAGS SHALL BE

BAGS ACCORDING TO THE PLAN NOTES. DO NOT USE ON MAJOR PAVED ROADWAYS WHERE PONDING MAY CAUSE TRAFFIC HAZARDS.

STANDARD CONSTRUCTION DETAIL #4-16 FILTER BAG INLET PROTECTION - TYPE M INLET

NOT TO SCALE

Villanova University Church Walk and Bridge Lancaster and Ithan Avenues Villanova PA 19085

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Revision

Date March 13, 2015 Title


Erosion & Sedimentation Control Detail Sheet


Scale N.T.S. Drawn By DWN


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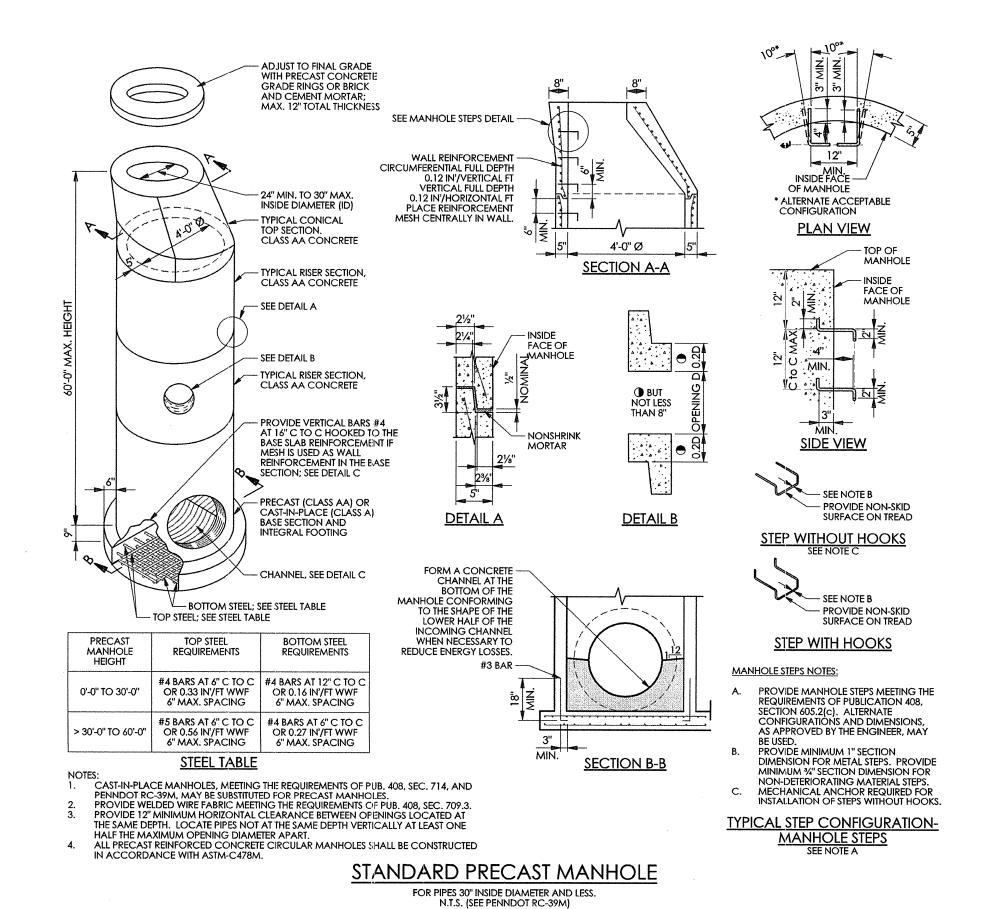
Contractor to verify all dimensions in field and inform


THIS PLAN FOR EROSION AND SEDIMENTATION CONTROL PURPOSES ONLY. Contractor to verify all dimensions in field and inform Architect of any discrepancies before starting work.



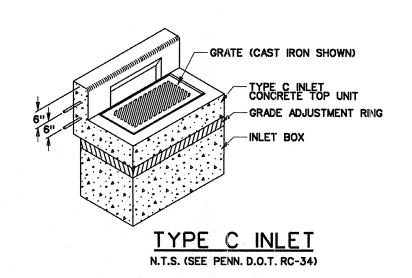


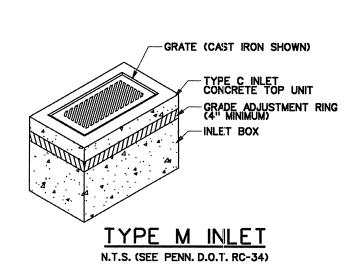

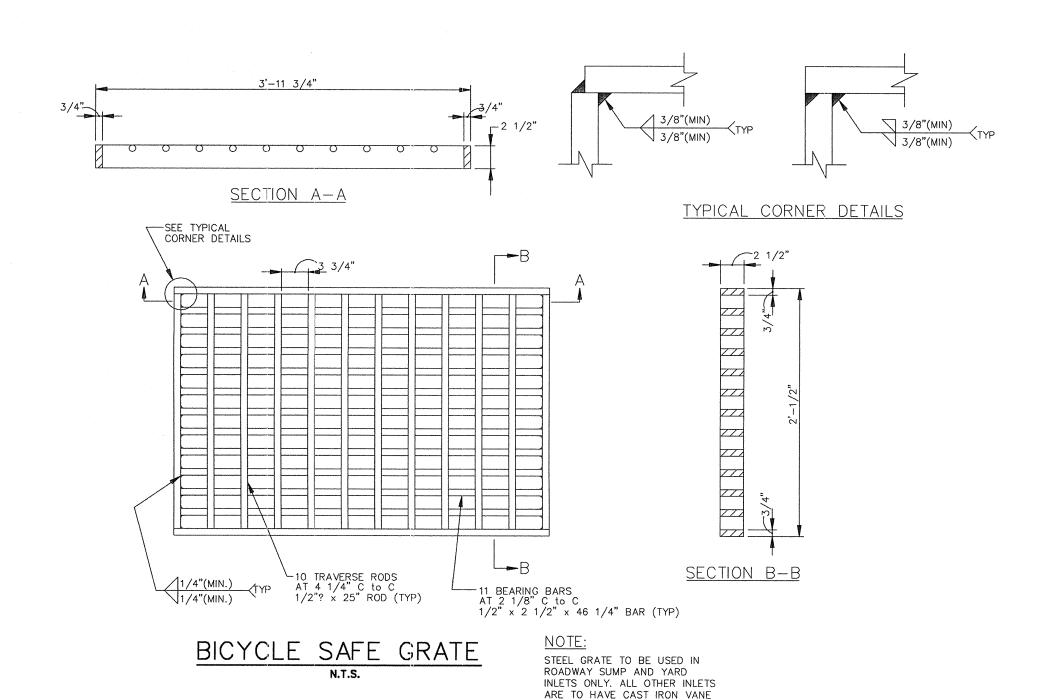

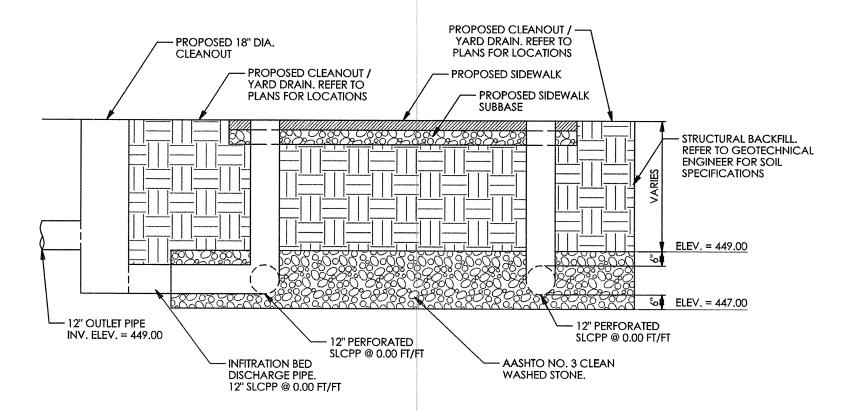

INFILTRATION TRENCH DETAIL

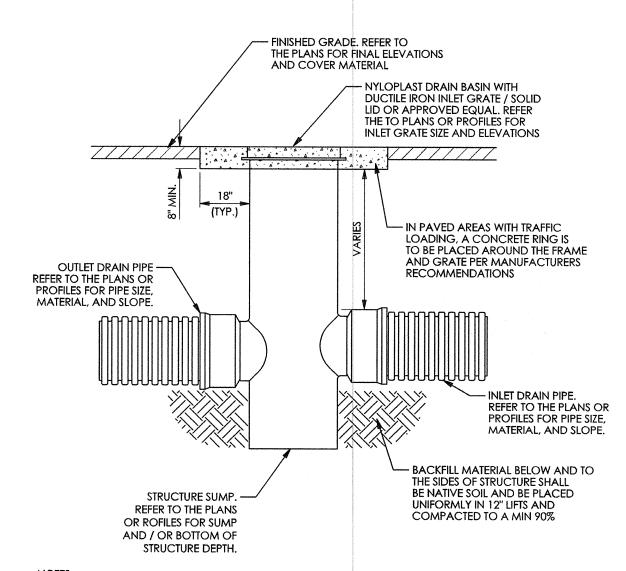


SURFACE DRAINAGE INLETS SHALL INCLUDE THE DRAIN BASIN SIZE AND TYPE AS INDICATED ON THE DRAWINGS. THE DUCTILE IRON GRATES FOR EACH OF THESE FITTINGS ARE TO BE CONSIDERED AN INTEGRAL PART OF THE SURFACE DRAINAGE INLET AND SHALL BE FURNISHED BY THE SAME MANUFACTURER. THE SURFACE DRAINAGE INLETS SHALL BE AS MANUFACTURED BY NYLOPLAST, A DIVISION OF ADVANCED DRAINAGE SYSTEMS, INC., OR PRIOR APPROVED EQUAL.
 REFER TO MANUFACTURERS MATERIAL AND PRODUCT INSTALLATION SPECIFICATIONS FOR ALL


BASIN, GRATE, AND BACKFILL MATERIAL SPECIFICATIONS.

5. ALL PIPING JOINTS ONSITE ARE TO BE WATERTIGHT.


NYLOPLAST DRAIN BASIN / CLEANOUT

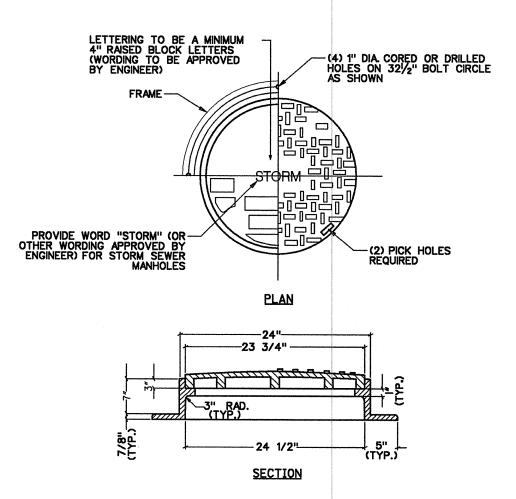

HEAVY DUTY CAST IRON MANHOLE FRAME AND SELF-SEALING COVER

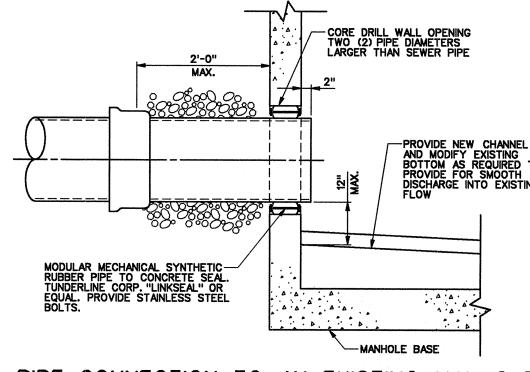


PIPE CONNECTION TO AN EXISTING MANHOLE

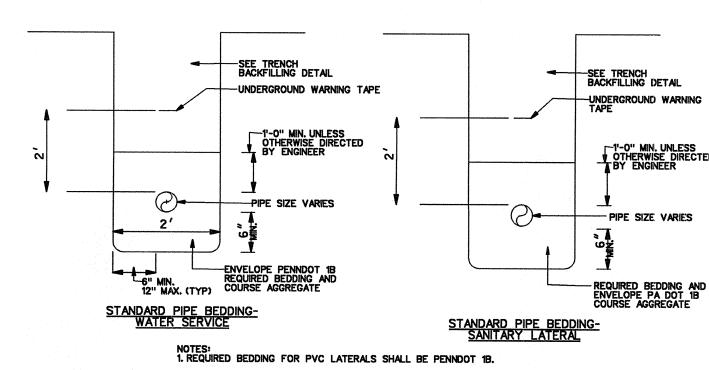

1. REQUIRED BEDDING FOR PVC LATERALS SHALL BE PENNDOT 1B.

PIPE BEDDING/ENVELOPE DETAIL

N.T.S.

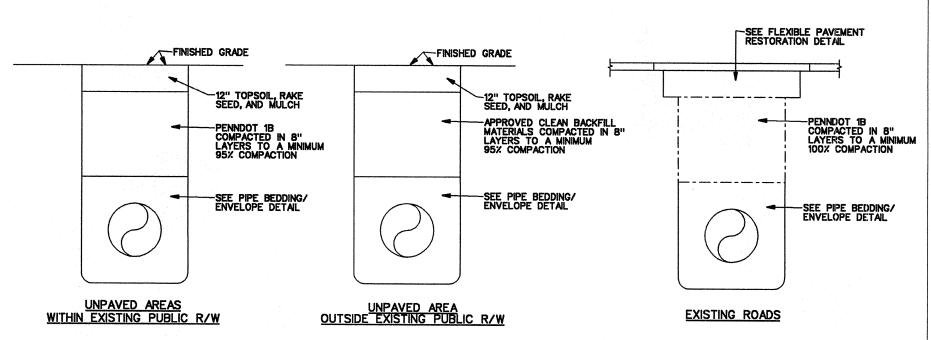

1. TRENCH COMPACTION TO BE TESTED, AT THE CONTRACTOR'S EXPENSE, IN ACCORDANCE WITH PENNDOT PUB 40B.
2. CLEAN FILL MUST BE APPROVED BY THE CITY'S ENGINEER PRIOR TO PLACEMENT IN THE TRENCH.

3. AREAS AROUND MANHOLES AND OTHER APPURTENANCES SHALL BE HAND COMPACTED AS DIRECTED BY THE CITY'S ENGINEER.

TRENCH BACKFILL

N.T.S.

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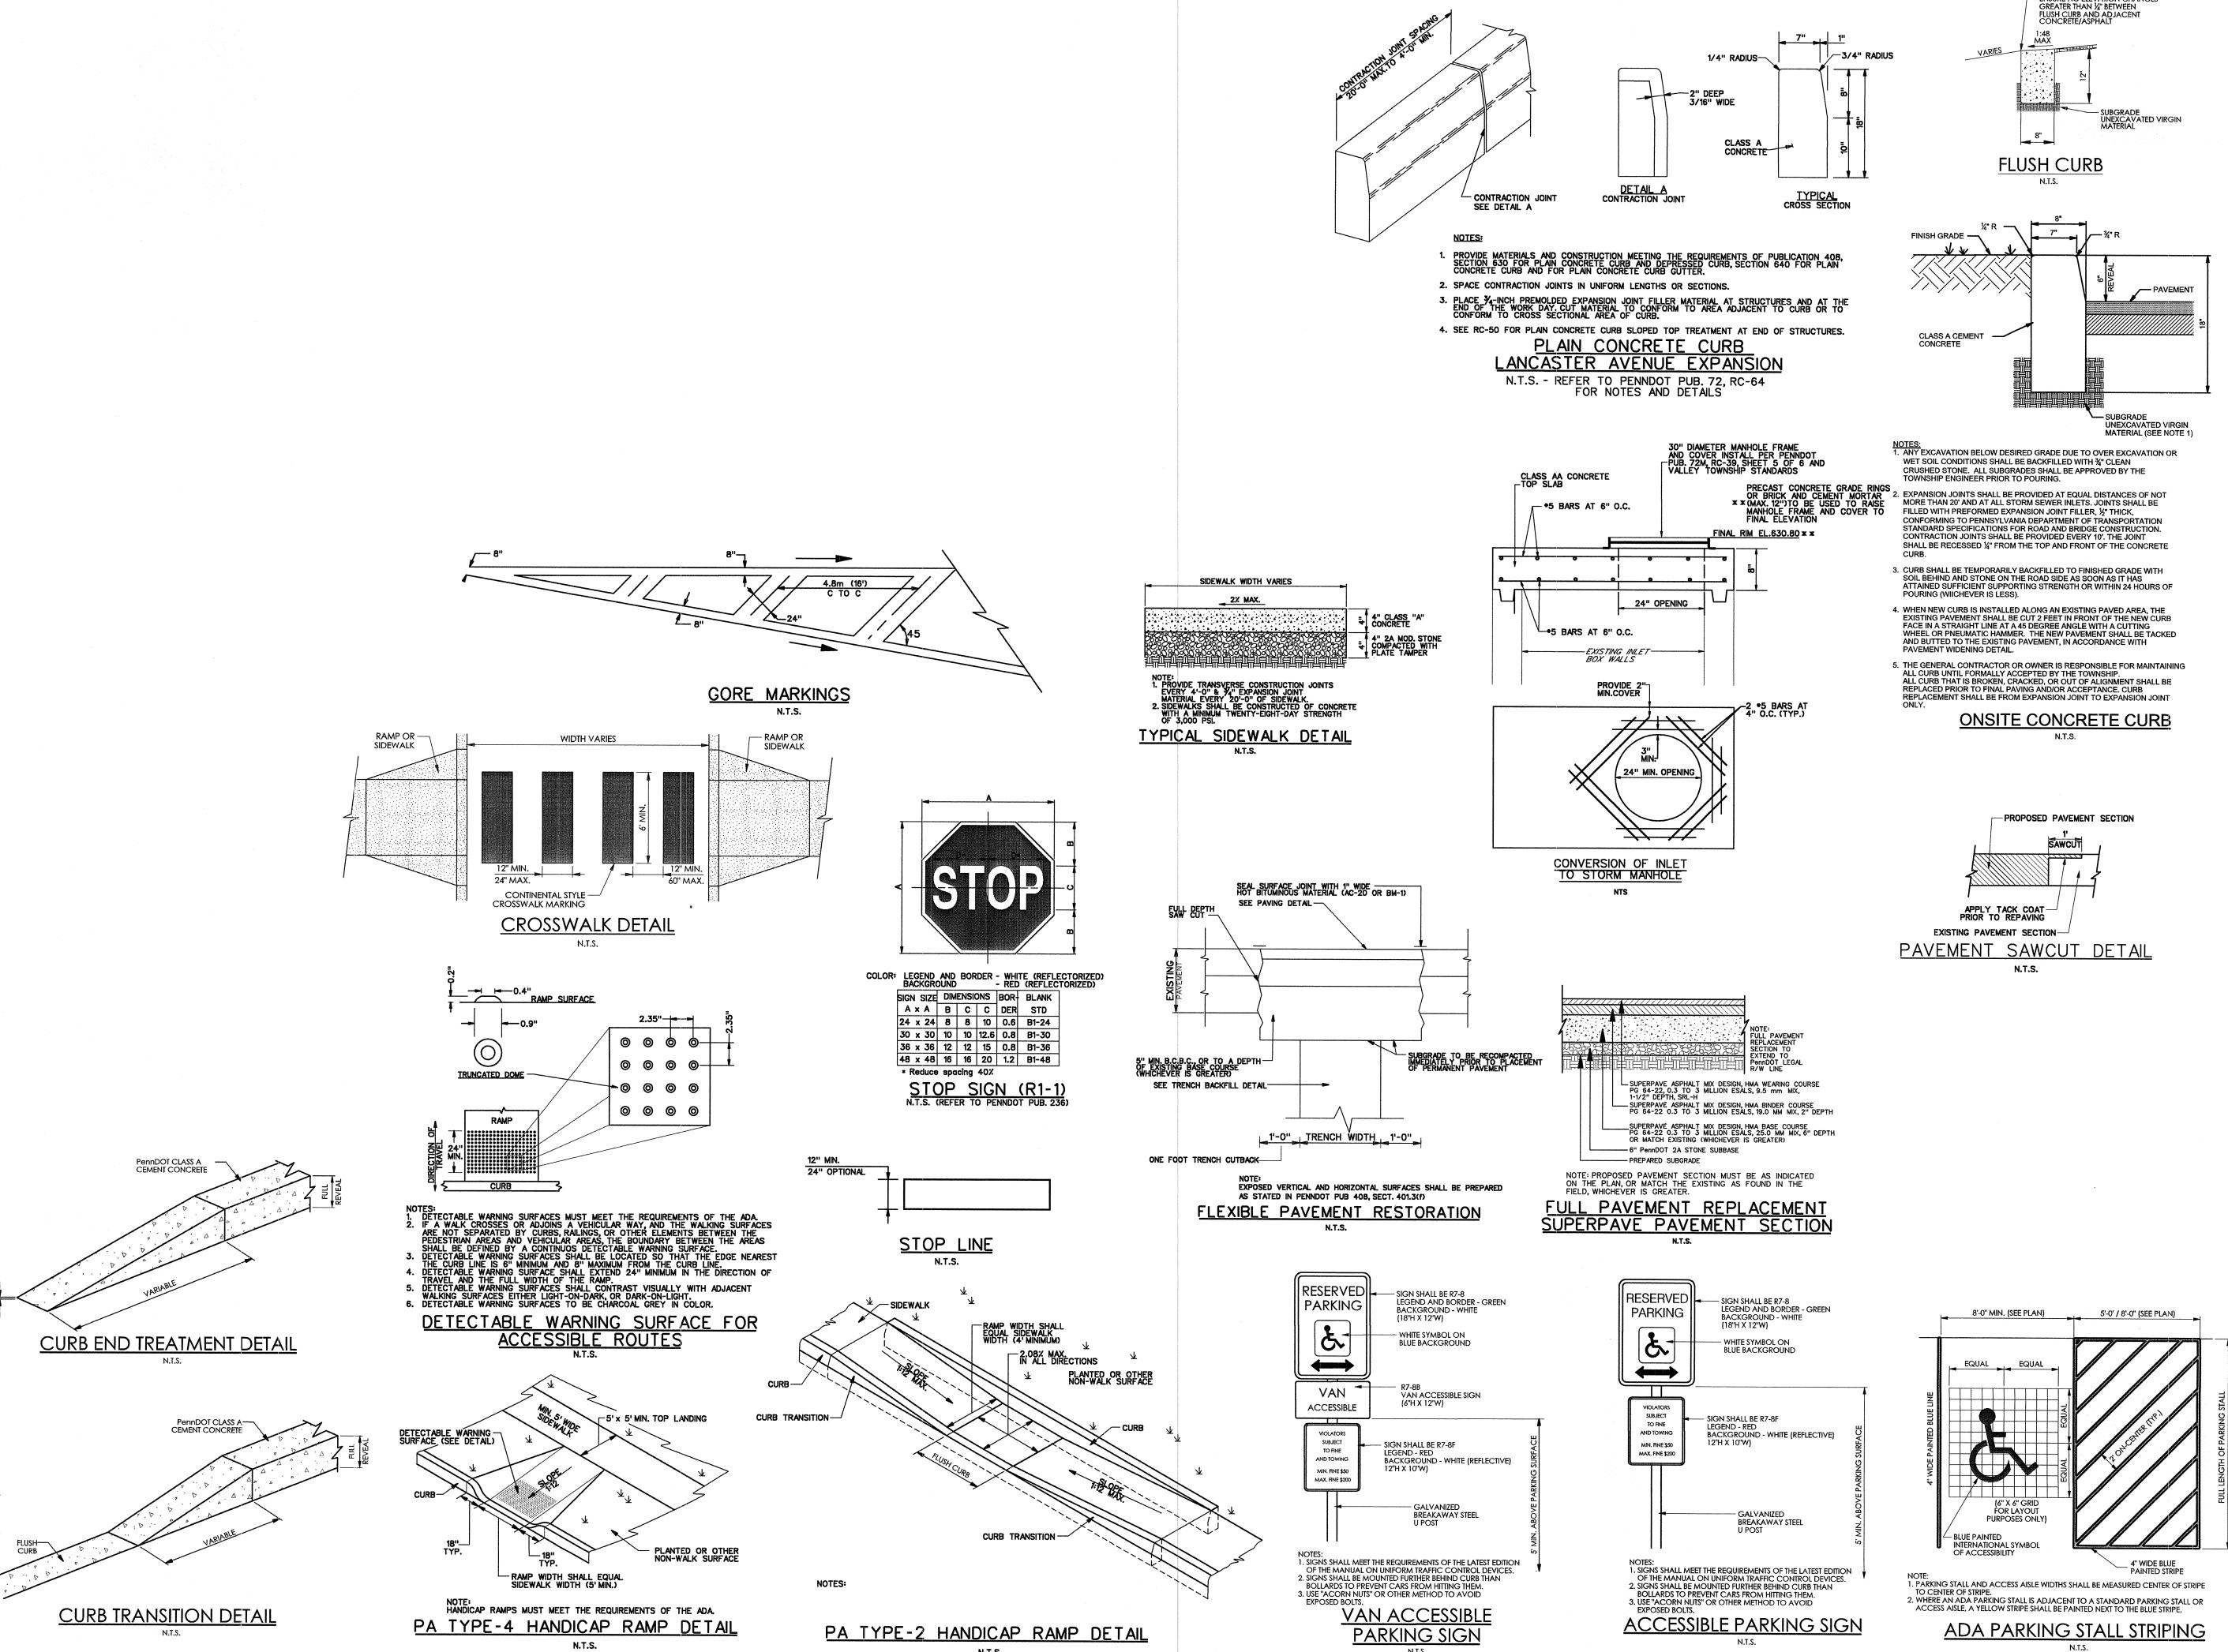
Title Construction Detail Sheet

Scale N.T.S.
Drawn By MMB

C6.1

Sheet No.

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N.T.S.

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-ENSURE NO ELEVATION CHANGES

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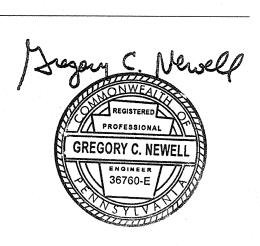
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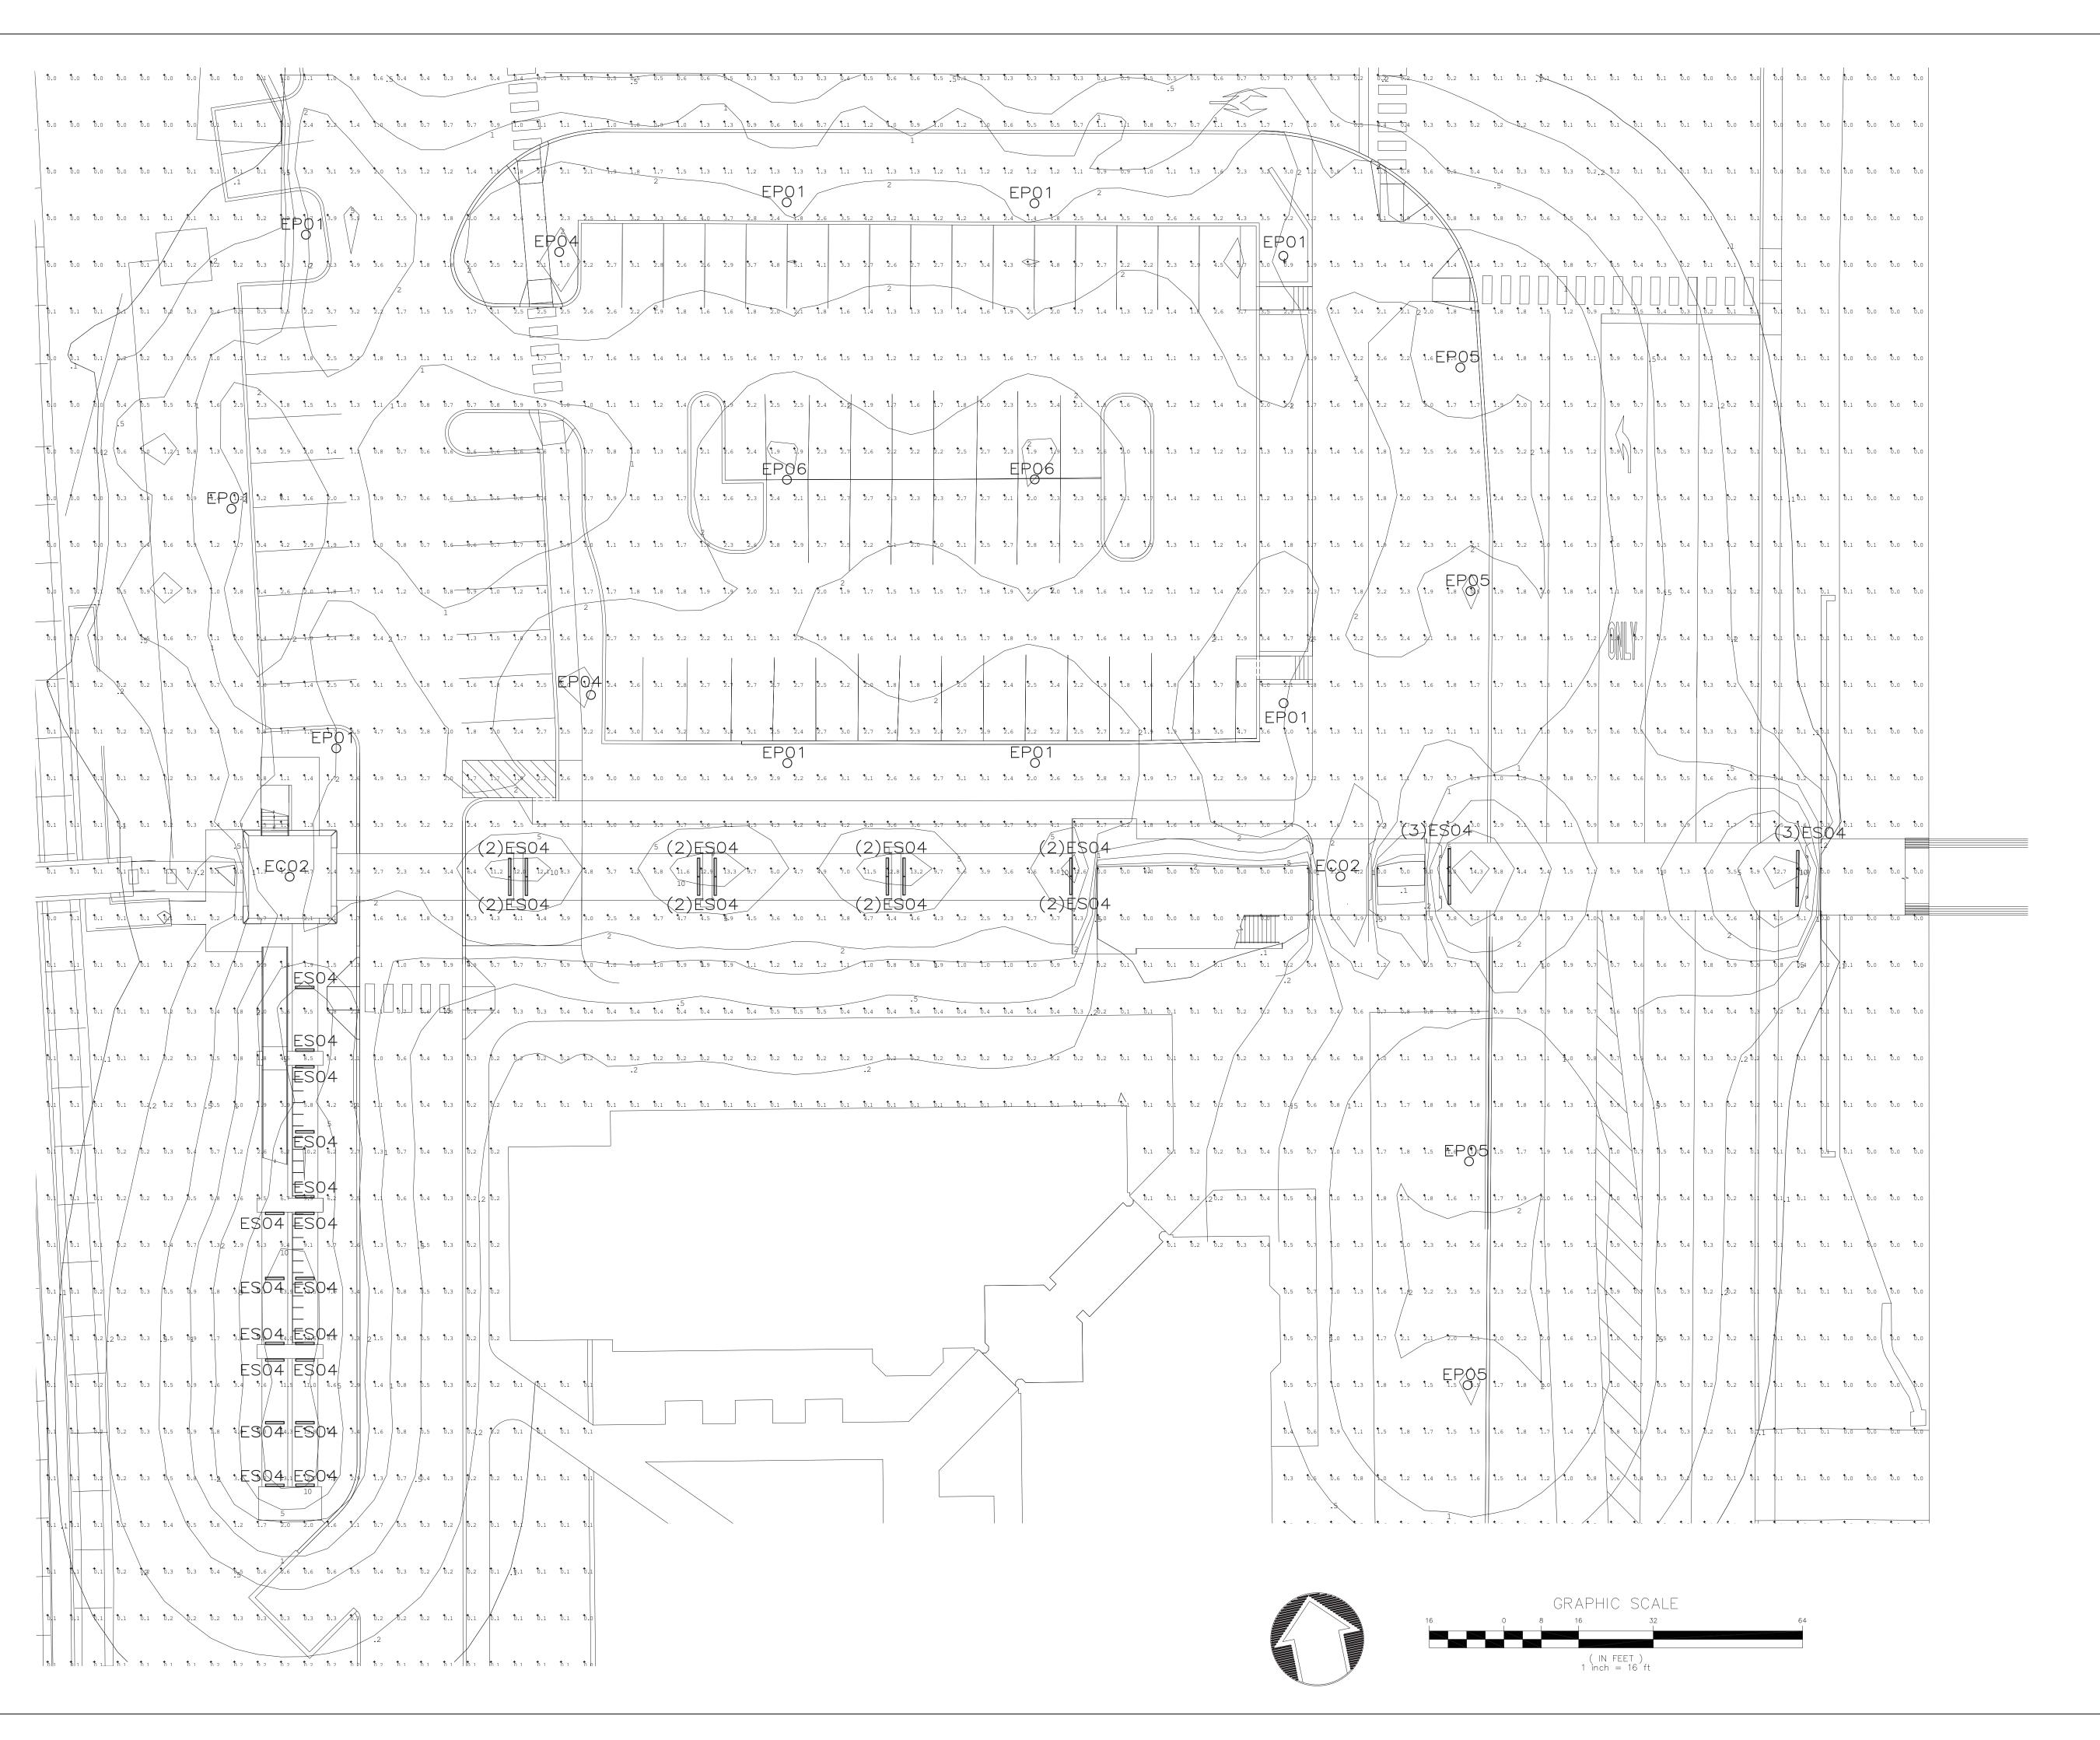
March 13, 2015 Title Construction Detail Sheet

N.T.S. Scale Drawn By MMB

C6.2

Sheet No.

12 of 20



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PRELIM. LAND DEVELOPMENT SUBMISSION - NOT FOR CONSTRUCTION Revision

Date March 13, 2015


Title Site Lighting Plan

Street Level

Scale 1" = 16'
Drawn By JO/JL

C7.

Sheet No. 13 of 20

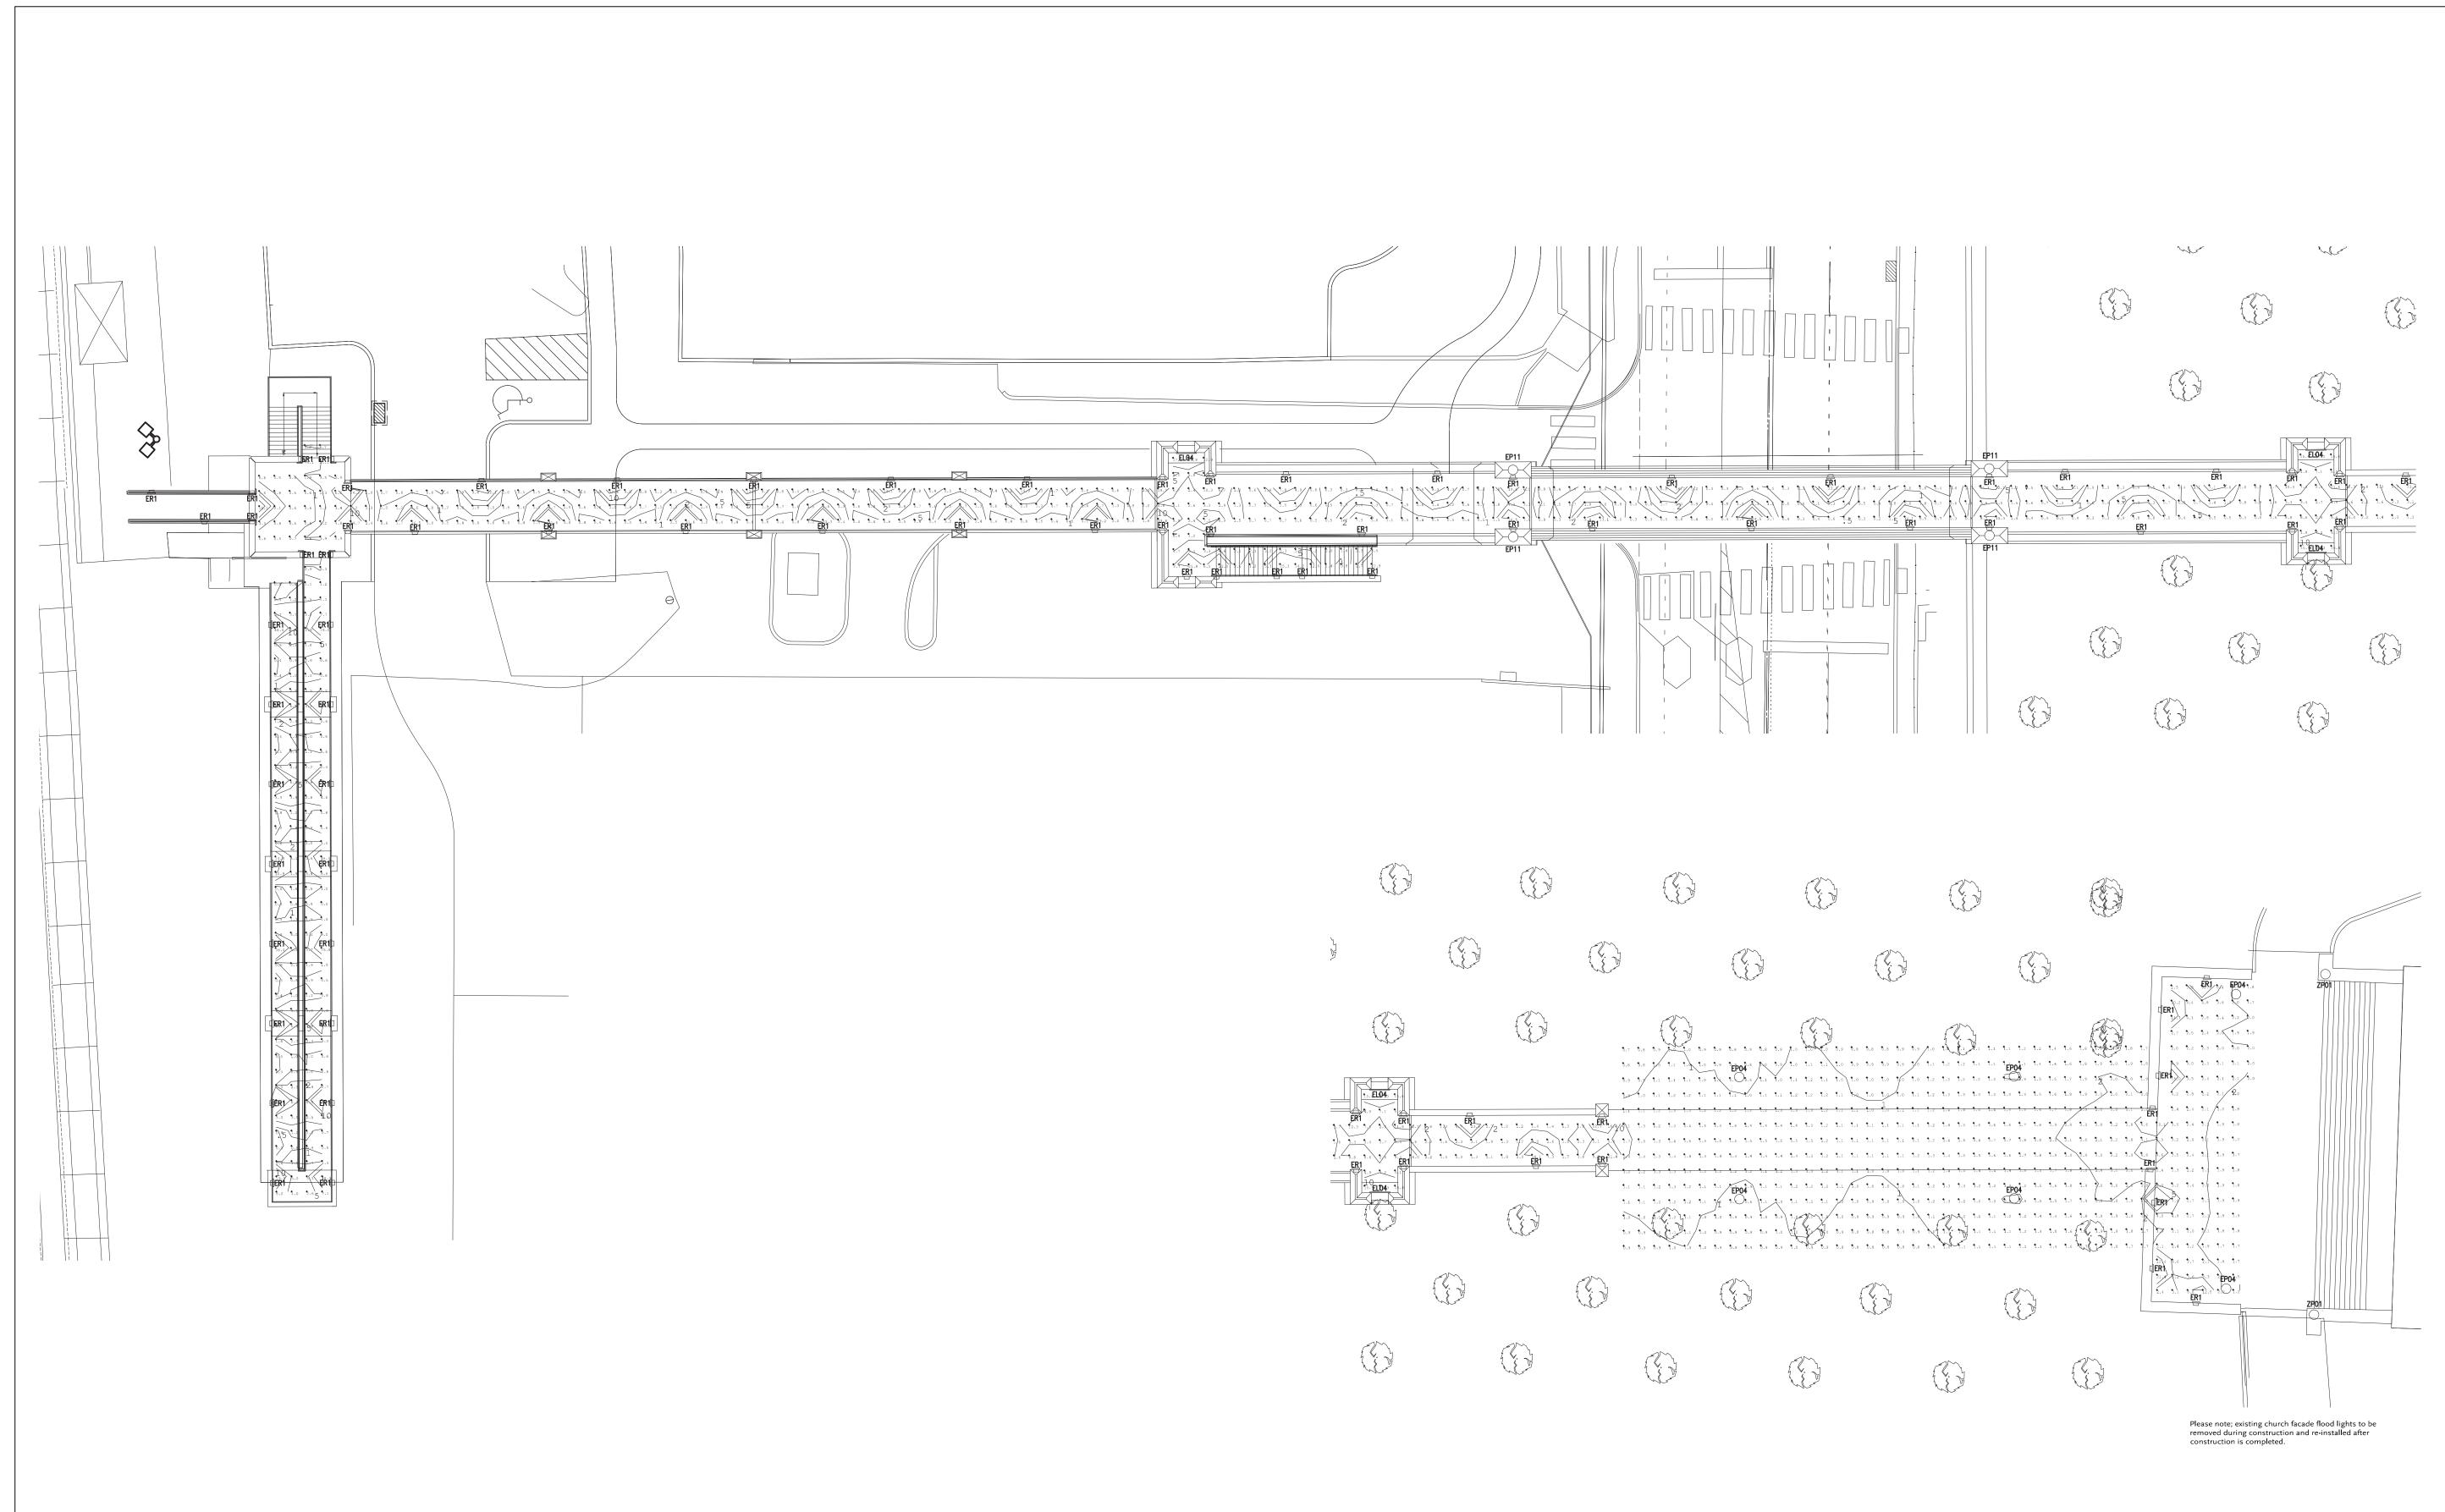

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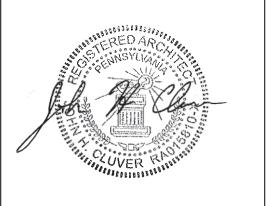
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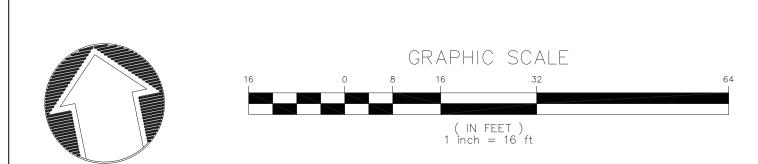
PRELIM. LAND DEVELOPMENT SUBMISSION - NOT FOR CONSTRUCTION Revision


Date March 13, 2015
Title Site Lighting Plan
Bridge level


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Drawn By JO/JL

C7.2

Sheet No. 14




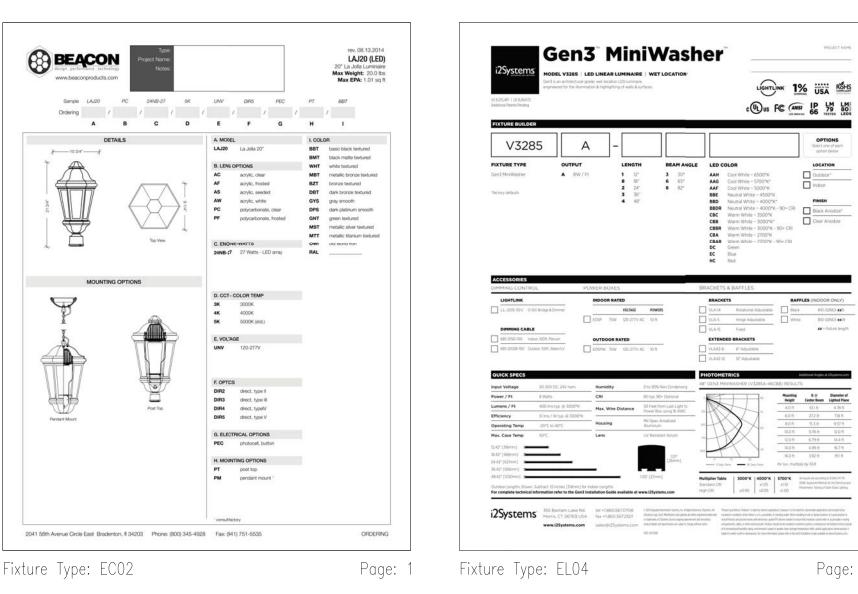


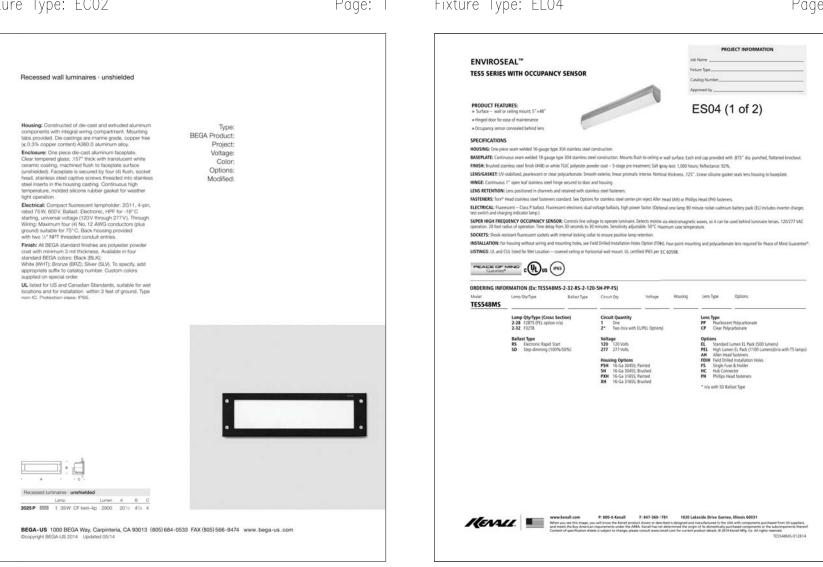


Page: 1 Fixture Type: ES04

Fixture Type: ER1

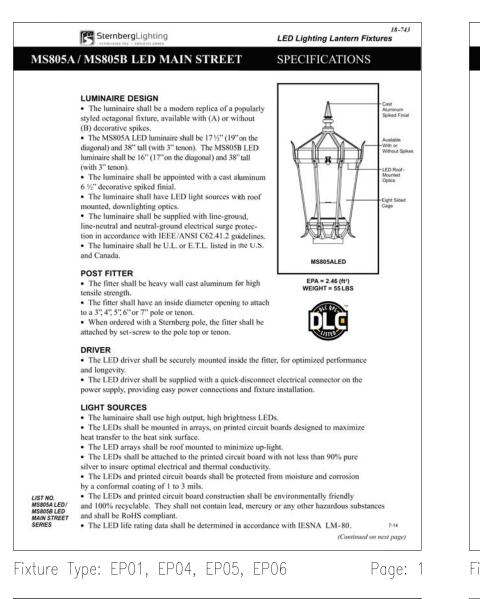

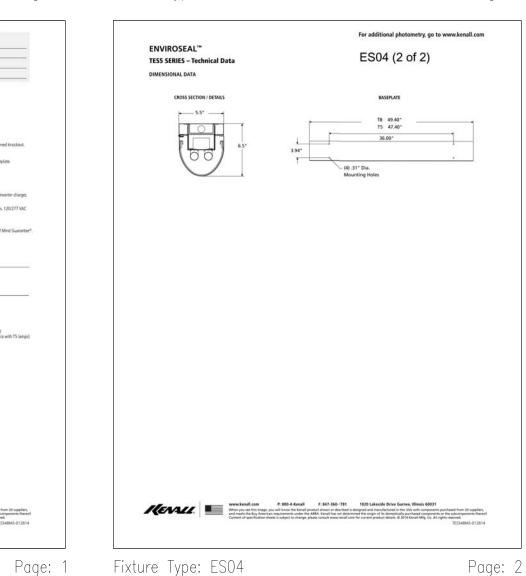



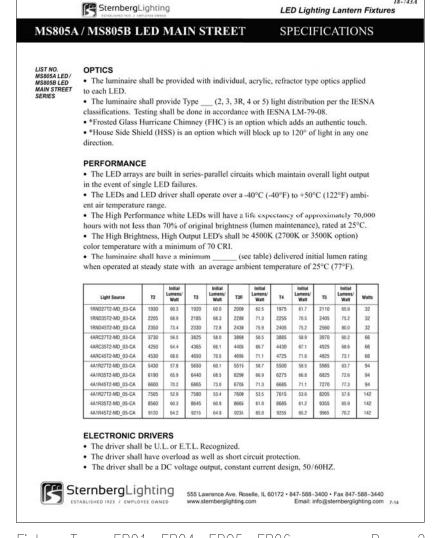

SternbergLighting

LUMINAIRE HOUSING

PHOTOCELL OPTIONS

• The photocell is 120-277 volt.

Electronic Cell Option

diffused (SV1).

MS805A / MS805B LED MAIN STREET SPECIFICATIONS

The driver shall be rated at full load with THD<20% and a power factor of greater than 0.90.

· The driver shall contain over-heat protection which reduces output to less than half

The luminaire shall be provided with a cast aluminum roof with optimized heat sinks to

The lens panels shall be made of vandal resistant, clear seeded acrylic (CSA). Available

in optional clear textured acrylic (CTA), clear acrylic (CA), flat frosted acrylic (SV2) or flat

· Arms with decorative filigree shall have meticulously detailed scroll work and gracefully

The arms shall be bolted to a post mount adaptor which is welded to the pole to ensure

. On single post-top fixtures, the photocell shall be mounted in the fitter and pre-wired to the

The photocell is not pre-wired since drivers are mounted in the fitters and packaged separately.

EC02 EXTERIOR PENDANT MOUNTED DECORATIVE LED

EL04 EXTERIOR 4'-0" LONG LINEAR LED FIXTURE WITH

AND ELECTRICAL FEED.

FINISH ON ALL ITEMS

FIXTURE WITH NEUTRAL WHITE OUTPUT, CLEAR

ACRYLIC LENS, DIRECT TYPE III OUT OFF DISTRIBUTION

AND BLACK TEXTURED FINISH ON ALL ITEMS. LOCATED IN UNDERCROFT OF SEPTA STAIRWAY PLATFORM.

NEUTRAL WHITE DISTRIBUTION, WIDE BEAM ANGLE,

REMOTE DRIVER AND OUTDOOR RATING. PROVIDE

EXTERIOR GRADE NEMA BOX FOR REMOTE DRIVER.

REFER TO ARCHITECTURAL DETAILS FOR MOUNTING

LENSES, INTEGRAL DIMMING DRIVER, ROOF MOUNTED OUT OFF OPTIC WITH TYPE III DISTRIBUTION ON 12'-0"

DECORATIVE POLE, BLACK TEXTURED FINISH ON ALL

LENSES, INTEGRAL DIMMING DRIVER, ROOF MOUNTED CUT OFF OPTIC WITH TYPE V DISTRIBUTION ON 12'-0"

LENSES, INTEGRAL DIMMING DRIVER, ROOF MOUNTED CUT OFF OPTIC WITH TYPE V DISTRIBUTION ON 14'-0"

DECORATIVE POLE. BLACK TEXTURED FINISH ON ALL

LENSES, INTEGRAL DIMMING DRIVER, ROOF MOUNTED CUT OFF OPTIC WITH TYPE V DISTRIBUTION ON 10'-0"

|DECORATIVE POLE ON 2' CONC. BASE. BLACK TEXTURED|

|FIXTURE. RELOCATED FROM CHURCH PLAZA RETAINING

ER1 RECESSED COMPACT FLUCRESCENT WALL LIGHT WITH BEGA

TRANSLUCENT WHITE CERAMIC COATING, CUSTOM

ARCHITECTURAL DETAILS FOR DIFFERENT MOUNTING

HIGH ABUSE FIXTURE WITH INTEGRAL ELECTRONIC

BALLAST, WHITE POLYCARBONATE WRAP AROUND

DIFFUSER AND BRUSHED STAINLESS STEEL FINISH. PROVIDE PIGEON SPIKES ON TOP OF FIXTURE.

FIXURE LOCATED ON RETAINING WALLS IN CHURCH

ZP01 EXISTING PIER MOUNTED DECORATIVE LANTERN

PLAZA TO REMAIN.

ES04 EXTERIOR SURFACE MOUNTED LINEAR FLUORESCENT KENALL

WALLS TO PIERS ON MAIN SPAN OF BRIDGE.

COLOR, LOCATED ON BRIDGE; REFER TO

CONDITIONS AND ELECTRICAL FEED.

EP11 EXTERIOR PIER MOUNTED DECORATIVE LANTERN EXISTING WF

INTEGRAL ELECTRONIC BALLAST, CLEAR LENS WITH LIGHTING

DECORATIVE POLE. BLACK TEXTURED FINISH ON ALL

EP01 | EXTERIOR DECORATIVE LED POLE MOUNTED LANTERN | STERNBERG | MS805ALED/ | INCLUDED |

EP04 EXTERIOR DECORATIVE LED POLE MOUNTED LANTERN STERNBERG MS805ALED/ INCLUDED

EP05 | EXTERIOR DECORATIVE LED POLE MOUNTED LANTERN | STERNBERG | MS805ALED/ | INCLUDED |

EP06 EXTERIOR DECORATIVE LED POLE MOUNTED LANTERN STERNBERG MS805ALED/ INCLUDED

FIXTURE WITH CAST ALUM. HOUSING, CLEAR ACRYLIC LIGHTING 3/OTHER/4AI

|FIXTURE WITH CAST ALUM. HOUSING, CLEAR ACRYLIC |LIGHTING |3/OTHER/4AI|

|FIXTURE WITH CAST ALUM. HOUSING, CLEAR ACRYLIC | LIGHTING | 3/ OTHER/ 4AI |

FIXTURE WITH CAST ALUM. HOUSING, CLEAR ACRYLIC | LIGHTING | 3/ OTHER/ 4AI

On multiple head fixtures, photocells shall be mounted in the pole shaft, on an access

• The photocell is instant-on at 1.5 foot-candles and turns off 5-10 seconds at 2-3

SternbergLighting
555 Lawrence Ave. Roselle, IL 60172 • 847-588-3400 • Fax 847-588-3440
www.sternberglighting.com
www.sternberglighting.com
Email: info@sternberglighting.com

proper alignment to the base.

• (Twin TA and Twin 579 arms) The arms shall be attached to a decorative center hub

· The driver shall have a minimum efficiency of 88%.

· The luminaire shall be made of heavy wall cast aluminum alloy.

provide maximum life and performance for the LED light sources.

· The arms shall be cast aluminum and/or extruded aluminum.

· The arms shall be pre-wired for ease of installation.


which will fit the center tenon of the pole (not shown).

Photocells shall be electronic button type.

Fixture Type: EP01, EP04, EP05, EP06

rating if the case temperature reaches 85°C.

LED Lighting Lantern Fixtures

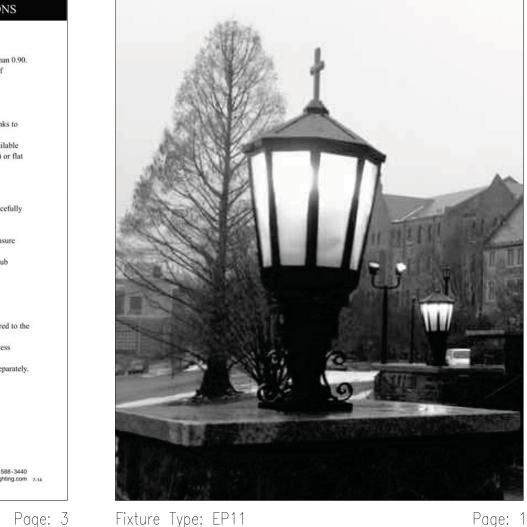

Fixture Type: EP11

LIGHTING FIXTURE SCHEDULE

LIGHTING

|LAJ20-AC- |INCLUDED|

|LSL2-48-LED-|INGLUDED|

24NB-27-4K-

UNV-DIR3-

NW-24-CL

T3/MDL/CA/

T5/MDL/CA/

T5/MDL/CA/

T5/MDL/CA/

2025P

EXISTING VIF

232-RS-1-120-

PHILIPS PL-L 39

TES548MS- | PHILIPS | F32T8/TL830 | 2 | 54 | 277 | 5.5"H

/ALTO

_____120 | 7/8"**×**1

|120 |15"W

|57 |277 |15"W |26"h

1 39 277 4 7/8" ×20 4"

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www.HarmanGroup.com MEP&FP ENGINEER Bala Consulting Engineers, Inc. 443 South Gulph Road King of Prussia, PA 19406 phone: 610-649-8000 fax: 910-649-8475

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PRELIM. LAND DEVELOPMENT SUBMISSION - NOT FOR CONSTRUCTION Revision


Date March 13, 2015 Title Site Lighting Details

Scale NTS

Drawn By JO/JL

150f 20 Sheet No.



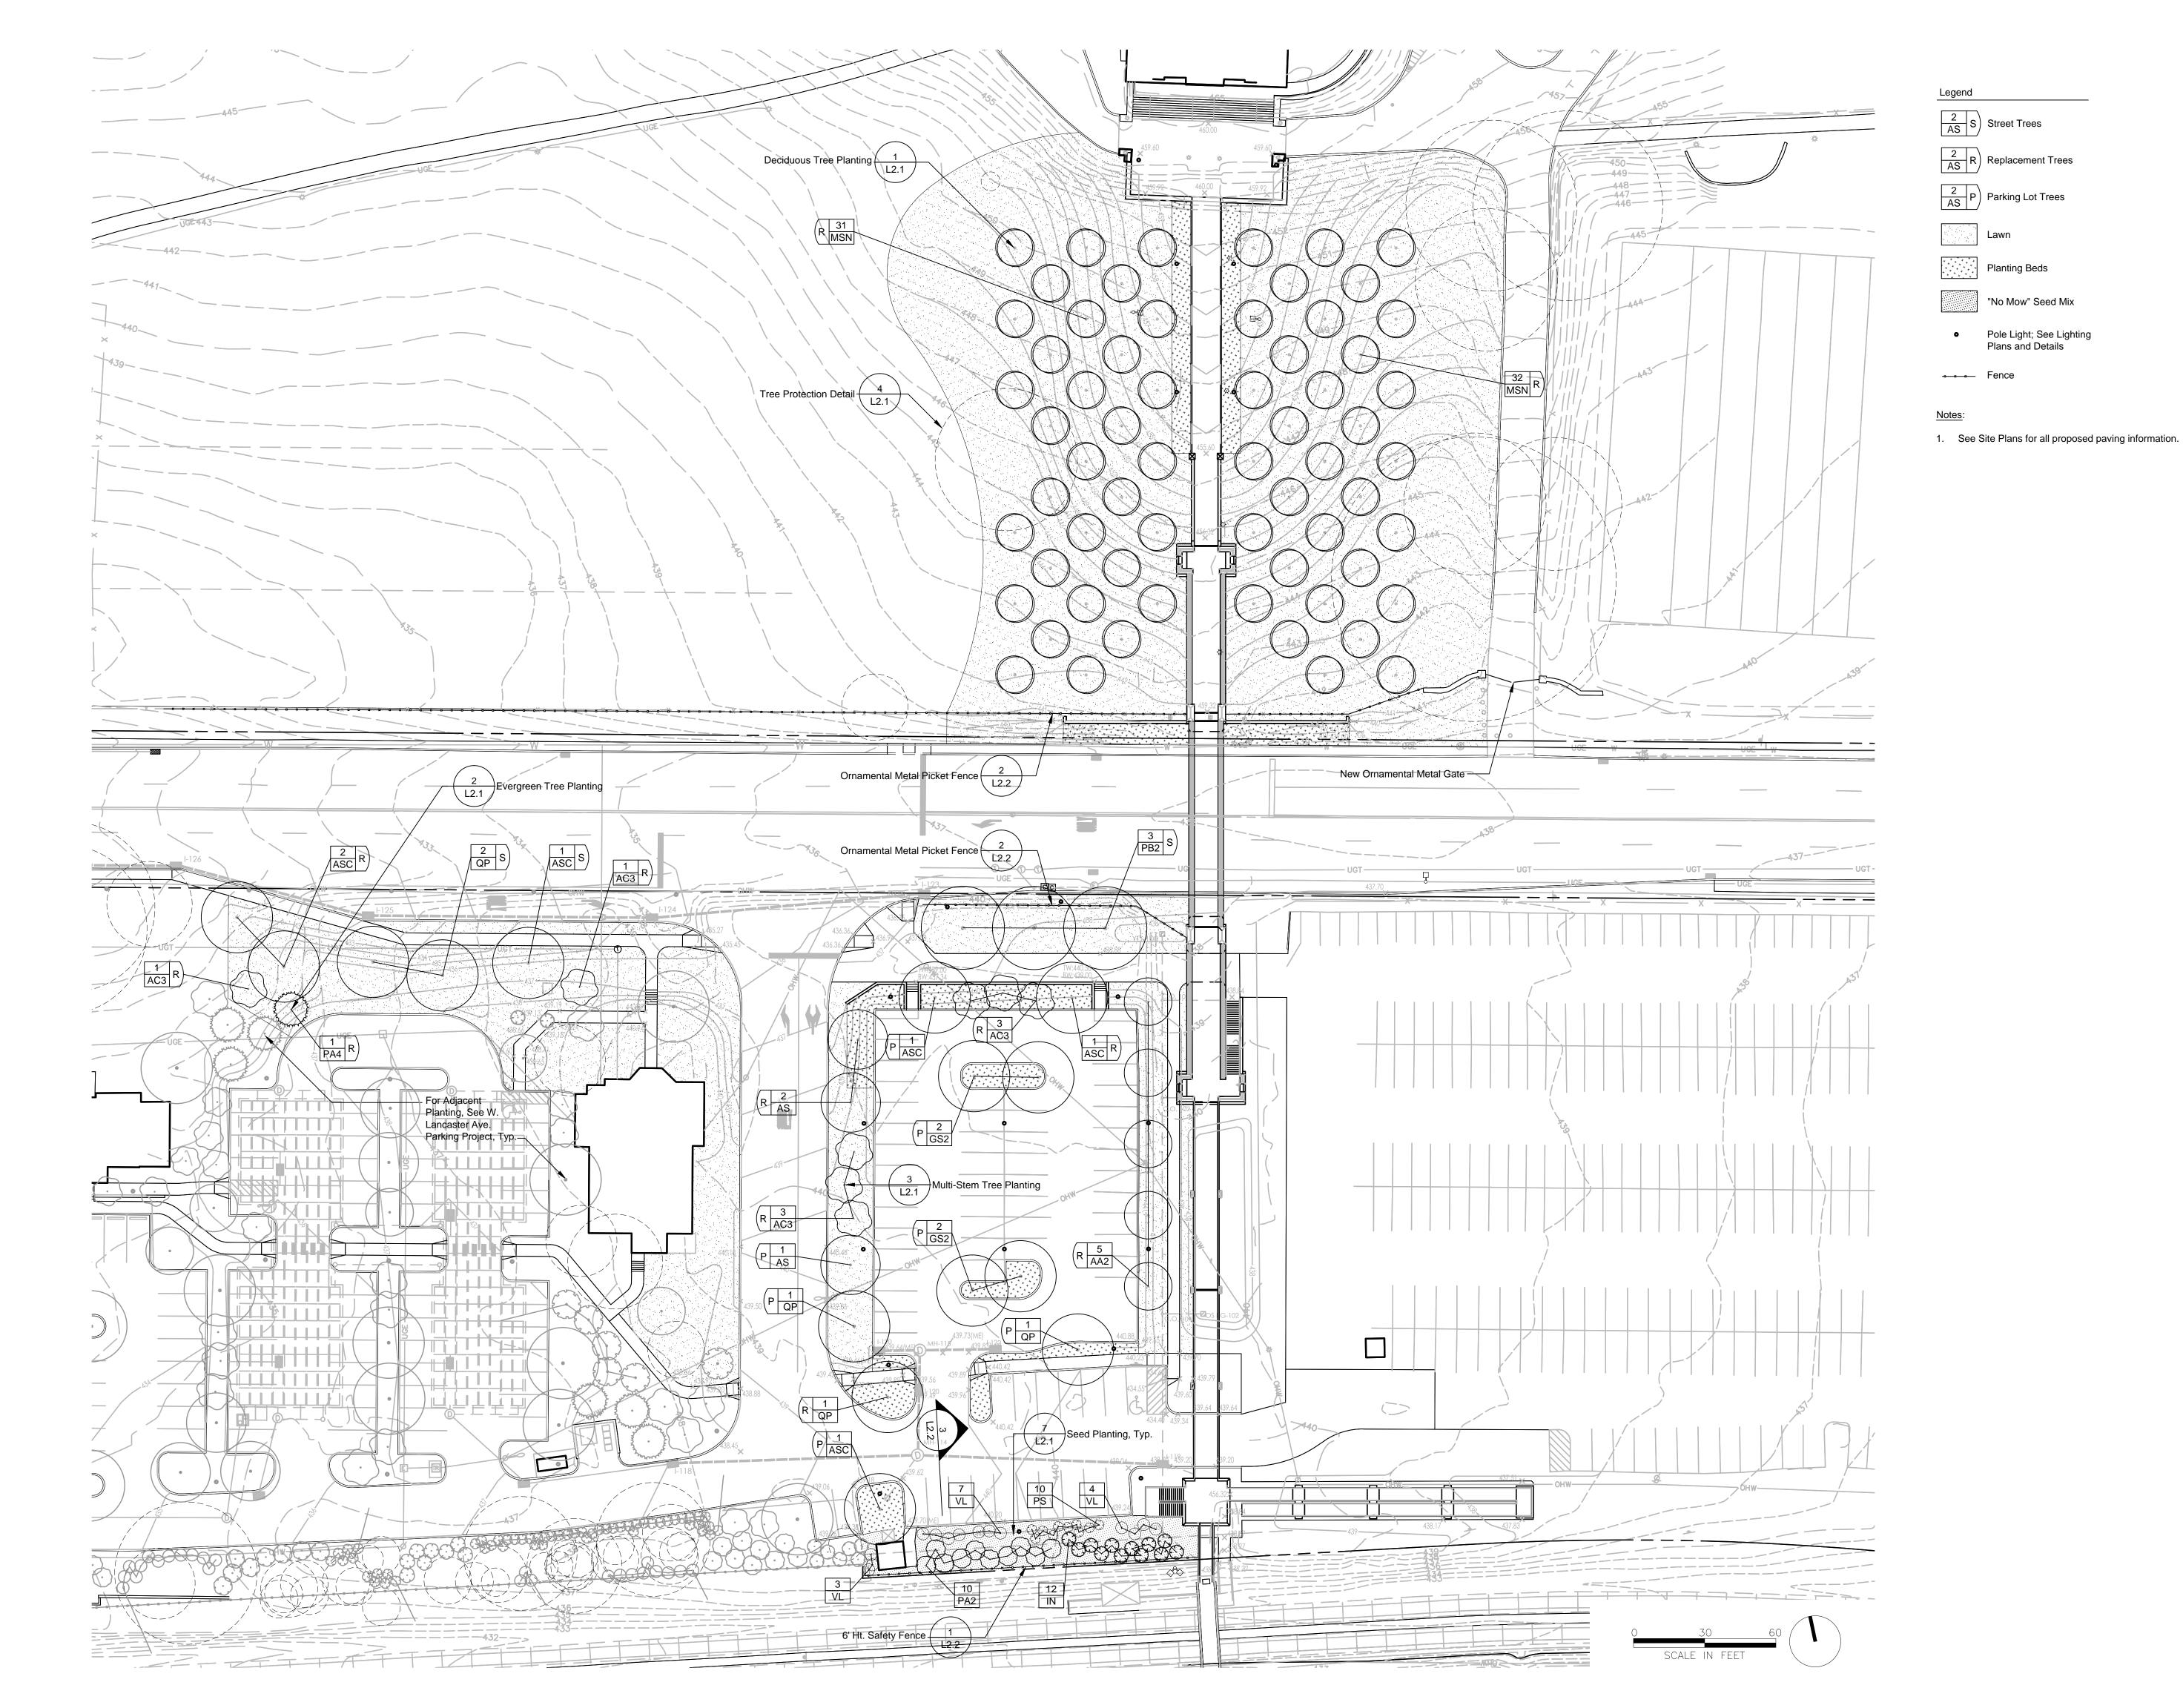

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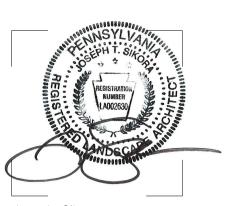
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PRELIM. LAND DEVELOPMENT SUBMISSION

Revision Date

Title

March 13, 2015 Planting Plan

Scale 1" = 30'-0"

Drawn By RM

1.0

Sheet No.

16 of 20



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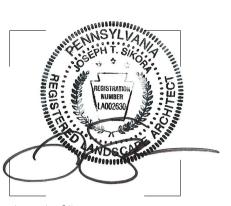
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PRELIM. LAND DEVELOPMENT SUBMISSION

Revision Date

Title

March 13, 2015 Planting Plan at Aldwyn Triangle

Scale 1" = 30'-0"

Drawn By RM

L1.1

Sheet No. 17 of 20

	REQUIRED	PROPOSED
STREET TREES		•
LANCASTER AVENUE (South Side Only) = 164' FT. SECTION 255-38.B INTERVALS OF NOT MORE THAN 30 FEET	164'/30' = 5 TREES	5 TREES
BUFFER SCREENS		
SOUTHERN PROPERTY LINE ADJACENT TO R-100 TRAIN RIGHT OF WAY SECTION 255-42 CLASS 'B' BUFFER SCREEN OPTION SELECTED: (1) EVERGREEN PER 15 FEET (INFORMALLY ARRANGED) PLUS; (1) EVERGREEN SHRUB PER 8 FEET (INFORMALLY ARRANGED)	142'/15' = 9 EVERGREEN TREES 142'/8' = 18 EVERGREEN SHRUBS	22 EVERGREEN TREES 24 EVERGREEN SHRUBS
REPLACEMENT TREES		
6 TO 18 INCH DBH REMOVED = (1) REPLACEMENT TREE 19 TO 29 INCH DBH REMOVED = (3) REPLACEMENT TREES** 30 INCH DBH OR GREATER REMOVED = (6) REPLACEMENT TREES***	(84) REMOVALS @ 6 TO 18 INCH = 84 REPLACEMENTS (4) REMOVALS @ 19 TO 29 INCH = (4) x 3= 12 REPLACEMENTS (5) REMOVALS @ 30 INCH+ = (5) x 6 = 30 REPLACEMENTS TOTAL REPLACEMENT TREES REQUIRED = 126 TREES	LARGE CANOPY TREES = 45 TREES ORNAMENTAL TREES = 83 TREES EVERGREEN TREES = 1 TREES TOTAL TREES PROPOSED = 129 TREES (INCLUDES 27 LARGE CANOPY TREES ANI 5 ORNAMENTAL TREES AT ALDWYN TRIANGLE - SEE SHEET L1.1 FOR LOCATIONS; 7 LARGE CANOPY TREES ANI 7 ORNAMENTAL TREES AT PIKE GARAGE SEE PIKE FIELD GARAGE PROJECT FOR LOCATIONS)
PARKING LOT		
SECTION 255-29.B (1) ONE TREE FOR EVERY FIVE PARKING SPACES IN SINGLE BAYS AND ONE TREE FOR EVERY TEN PARKING SPACES IN DOUBLE BAYS	19 SINGLE BAY SPACES/ 5 = 3.8 TREES 48 DOUBLE BAY SPACES/ 10 = 4.8 TREES TOTAL PARKING LOT TREES REQUIRED = 9 TREES	9 TREES

NOTES:

1. QUANTITY, AND ARRANGEMENT OF PLANT MATERIAL WITHIN BUFFER SCREEN WILL PRODUCE A VISUAL SCREEN NOT TO BE SEEN THROUGH AND PROVIDE IMMEDIATE VISUAL SCREENING TO THE ABUTTING PROPERTY OR DISTRICT AS PER SECTION 280-71.A. OF THE TOWNSHIP ZONING ORDINANCE.

<u>PLANT SCHE</u>	<u>DUL</u>				_		
CANOPY TREES	QTY	BOTANICAL NAME	COMMON NAME	CONT	CAL	SIZE	REMARKS
AA2	5	ACER RUBRUM 'ARMSTRONG'	ARMSTRONG RED MAPLE	B & B	2 1/2" - 3"		MATCHED SPECIMENS
AS	7	ACER RUBRUM `SOMERSET`	SOMERSET RED MAPLE	В&В	2" - 2 1/2"		
ASC	7	ACER SACCHARUM `COMMEMORATION`	COMMEMORATION SUGAR MAPLE	В&В	2"-2-1/2"		
GS2	4	GLEDITSIA TRIACANTHOS `SKYLINE`	SKYLINE HONEY LOCUST	В&В	2 1/2" - 3"		MATCHED SPECIMENS; FULL HEAD
_R	3	LIQUIDAMBAR STYRACIFLUA 'ROTUNDILOBA' TM	ROUND-LOBED SWEET GUM	В&В	2 1/2" - 3"		MATCHED SPECIMENS; FULL HEAD
NS	5	NYSSA SYLVATICA	SOUR GUM	B & B	2" - 2 1/2"		SPECIMEN QUALITY
PB2	3	PLATANUS X ACERIFOLIA `BLOODGOOD`	LONDON PLANE TREE	В&В	2 1/2" - 3"		MATCHED; SPECIMEN QUALITY
QA	6	QUERCUS ALBA	WHITE OAK	В&В	2"-2-1/2"		SPECIMEN QUALITY
QP	8	QUERCUS PHELLOS	WILLOW OAK	В&В	2"-2-1/2"		
TD3	5	TAXODIUM DISTICHUM	BALD CYPRESS	В&В	2" - 2 1/2"		
	•			•	•		
EVERGREEN TREES	QTY	BOTANICAL NAME	COMMON NAME	CONT	CAL	SIZE	REMARKS
N	12	ILEX X 'NELLIE R STEVENS'	NELLIE STEVENS HOLLY	В&В		8`-10` HT.	SPECIMENS; FULL TO GROUND; 6' MAX. O.C. SPACING IN BUFFER
PA2	10	PICEA ABIES	NORWAY SPRUCE	В&В		8`-10` HT.	SPECIMENS; FULL TO GROUND; 8` MAX. O.C SPACING
PA4	1	PICEA ORIENTALIS 'AUREA'	SPRUCE	В&В		8`-10` HT.	
				•	•		
DRNAMENTAL TREES	QTY	BOTANICAL NAME	COMMON NAME	CONT	CAL	SIZE	REMARKS
VC3	11	AMELANCHIER CANADENSIS	SHADBLOW SERVICEBERRY MULTI-TRUNK	В&В		8`-10` HT.	FULL SPECIMENS; MIN. 5 STEMS
CP	2	CRATAEGUS PHAENOPYRUM	WASHINGTON HAWTHORN	В&В	2" - 2 1/2"		
MSN	63	MALUS X `SNOWDRIFT`	SNOWDRIFT CRAB APPLE	В&В	2" - 2 1/2"		
	<u>.</u>			•	•	'	
SHRUBS	QTY	BOTANICAL NAME	COMMON NAME	CONT	SIZE		REMARKS
PS .	10	PRUNUS LAUROCERASUS `SCHIPKAENSIS`	SCHIPKA LAUREL	B & B	3` - 4` HT.		DENSE, FULL PLANTS; 4` MAX. O.C. SPACING
/L	14	VIBURNUM RHYTIDOPHYLLUM	LEATHERLEAF VIBURNUM	В&В	5`-6` HT.		DENSE, FULL PLANTS; 5` MAX. O.C. SPACING

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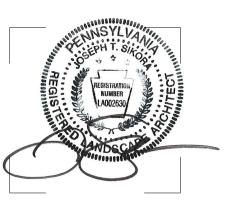
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PRELIM. LAND DEVELOPMENT SUBMISSION

Revision

Date March 13, 2015 Title Planting Schedule and Tabulations

Scale As Indicated


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Sheet No.

Contractor to verify all dimensions in field and inform

18 of 20

Architect of any discrepancies before starting work.

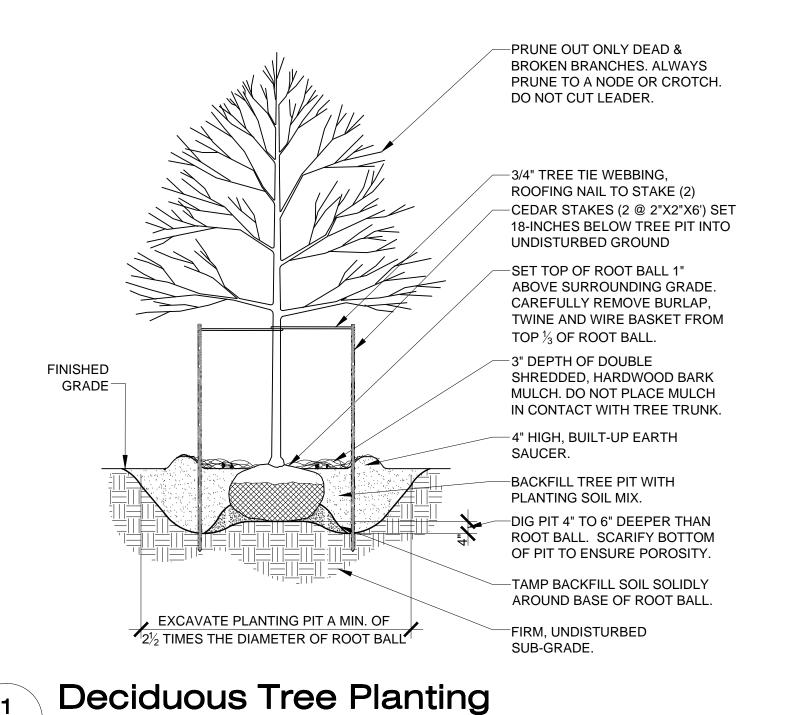

PERCOLATE SUFFICIENTLY FOR PROPER TREE GROWTH. TEST EACH PIT. REINFORCED RUBBER HOSE. #12 GALV. WIRE (3) SET TOP OF ROOT BALL 1" ABOVE SURROUNDING GRADE. CAREFULLY REMOVE BURLAP, TWINE AND WIRE BASKET FROM TOP 1/3 OF ROOT BALL. 3" DEPTH OF DOUBLE SHREDDED, HARDWOOD BARK MULCH. DO NOT PLACE MULCH FINISHED IN CONTACT WITH TREE TRUNK. GRADE -- CEDAR STAKES (2"X2"X2') SET BELOW TREE PIT IN UNDISTURBED GROUND 4" HIGH, BUILT-UP EARTH SAUCER. FILL PLANTING PIT WITH PLANTING SOIL MIX. DIG PIT 4" TO 6" DEEPER THAN ROOT BALL. SCARIFY BOTTOM OF PIT TO ENSURE POROSITY. TAMP BACKFILL SOIL SOLIDLY AROUND BASE OF ROOT BALL.

1. ALL TREE PITS SHALL

FIRM, UNDISTURBED

SUB-GRADE.

PRUNE OUT ONLY DEAD AND **BROKEN BRANCHES; ALWAYS** PRUNE TO A NODE OR NOTCH; DO NOT CUT LEADER REINFORCED RUBBER HOSE; SET TOP OF ROOT FLARE AT 1" ABOVE COLOR SHALL BE BLACK SURROUNDING GRADE; CAREFULLY REMOVE BURLAP, TWINE, AND WIRE BASKET FROM TOP 1/2 OF ROOT BALL #12 GALV. WIRE 3" DEPTH OF DOUBLE SHREDDED ROUGH SAWN WOOD STAKES -HARDWOOD BARK MULCH; SEE SET18" BELOW TREE PIT IN SPECIFICATIONS UNDISTURBED GROUND; QUANTITY, 3 PER TREE; SEE SPECIFICATIONS PLANTING SOIL MIX; SEE SPECIFICATIONS TAMP BACKFILL SOIL SOLIDLY AROUND FINISHED GRADE BASE OF ROOT BALL $^{ extsf{-}}\mathsf{DIG}$ PIT 4" TO 6" DEEPER THAN ROOT BALL AT PERIMETER OF ROOT BALL; SCARIFY BOTTOM OF PIT TO ENSURE POROSITY 2 1/2 TIMES DIAMETER FIRM, UNDISTURBED SUBGRADE OF ROOTBALL

Evergreen Tree Planting L2.1 N.T.S.

EXCAVATE PLANTING PIT A MIN. OF

2½ TIMES THE DIAMETER OF ROOT BALL

Multi-Stem Tree Planting Scale: 0 1' 2' 4' Scale: 1/2"=1'-0"

-PROPOSED 6' HIGH CHAIN LINK FENCING -CRITICAL ROOT ZONE DRIPLINE ---TREE **EXISTING** 2" DIA. GALVANIZED – STEEL POSTS TREE PROTECTION SIGN. MAX. 10'-0" LOCATE EVERY 20' MIN. 2" MESH #9 GAUGE POST SPACING CHAINLINK FENCE REMOVAL IS APPROVED BY OWNERS EXISTING GRADE


1. NO STORAGE OF MATERIALS OR OPERATION OF EQUIPMENT SHALL BE PERMITTED WITHIN TREE PROTECTION FENCING. 2. A 4" LAYER OF COARSE MULCH OR WOODCHIPS IS TO BE PLACED BENEATH THE DRIPLINE OF THE PROTECTED TREES. MULCH IS TO BE KEPT 12" FROM THE TRUNK.

3. A PROTECTIVE BARRIER OF 6' CHAIN LINK FENCING SHALL BE INSTALLED AROUND THE DRIPLINE OF THE PROTECTED TREE(S). THE FENCING CAN BE MOVED WITHIN THE DRIPLINE IF AUTHROIZED BY THE CONSULTING ARBORIST BUT NOT CLOSER THAN 2' FROM THE TRUNK OF ANY TREE. FENCE POSTS SHALL BE 2.0" IN DIAMETER AND ARE TO BE DRIVEN 2' INTO THE GROUND. THE DISTANCE BETWEEN POSTS SHALL NOT BE MORE THAN 10'. THIS ENCLOSED AREA IS THE TREE PROTECTION ZONE (TPV2). 4. FENCING SHALL BE MAINTAINED THROUGHOUT THE DURATION OF THE WORK AT THE SITE OR UNTIL

REPRESENTATIVE. 5. ADDITIONAL WARNING SIGNS SHOULD ALSO BE PLACED ON THE FENCING AND IN APPROPRIATE AREAS NEAR THE WORK ZONE TREE PROTECTION FENCE SHALL BE INSPECTED AND MAINTAINED BY THE CONTRACTOR AT THE END OF

EVERY DAY FOR THE DURATION OF THE PROJECT. THE FENCE SHALL BE REPAIRED WHERE NECESSARY. WHERE FENCE MUST BE LOCATED WITHIN FIVE(5) FEET OF EXISTING TREE TRUNK, THE TRUNK PROTECTION DETAIL SHALL ALSO BE USED. TREE PROTECTION MEASURES SHALL COMPLY WITH ALL TOWNSHIP REGULATIONS AND ORDINANCES.

L2.1 N.T.S.

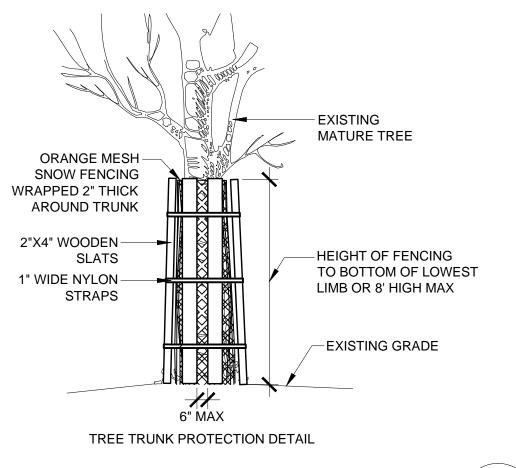


SEE PLANS AND PLANT SCHEDULE FOR SPACING CROWN OF ROOT BALL SHOULD SIT 1" ABOVE FINISHED GRADE 3" DEPTH OF DOUBLE SHREDDED HARDWOOD BARK MULCH; DO NOT PLACE MULCH IN CONTACT WITH TRUNK OF SHRUB; SEE SPECIFICATIONS 12" MINIMUM DEPTH OF PLANTING SOIL MIX. SEE SPECIFICATIONS

> TILL APPROXIMATELY 1/2 OF PLANTING SOIL MIX WITH TOP 6" OF EXISTING SUBSOIL. SEE SPECIFICATIONS. -EXISTING SUBSOIL

Tree Protection Detail

L2.1 N.T.S.

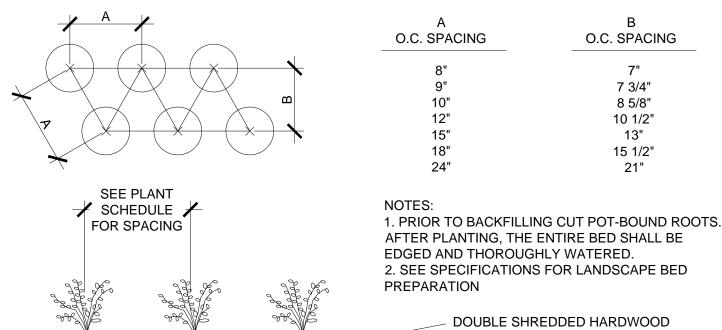


BARK MULCH; AT A 2" DEPTH; SEE SPECIFICATIONS PLANTING SOIL MIX, 8" DEPTH (SEE SPECIFICATIONS)


SUBGRADE

SECTION VIEW

Groundcover Planting

L2.1 N.T.S.

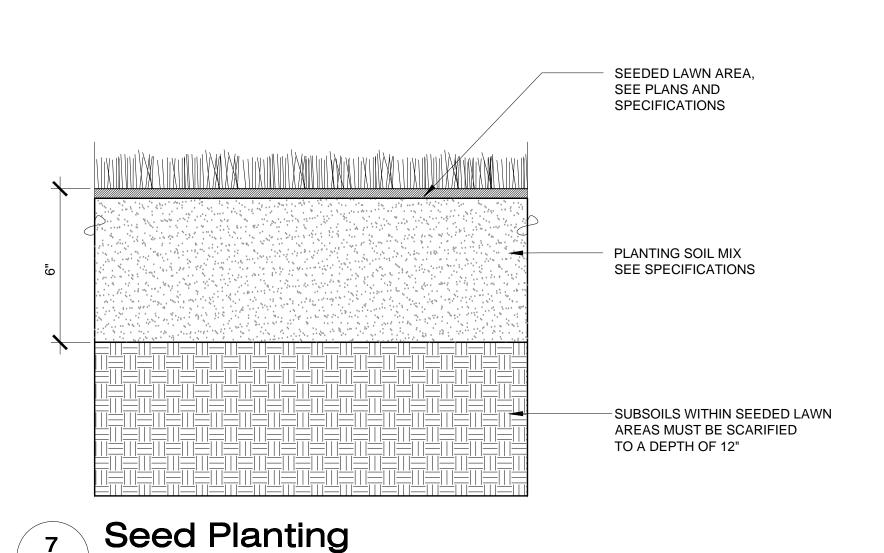

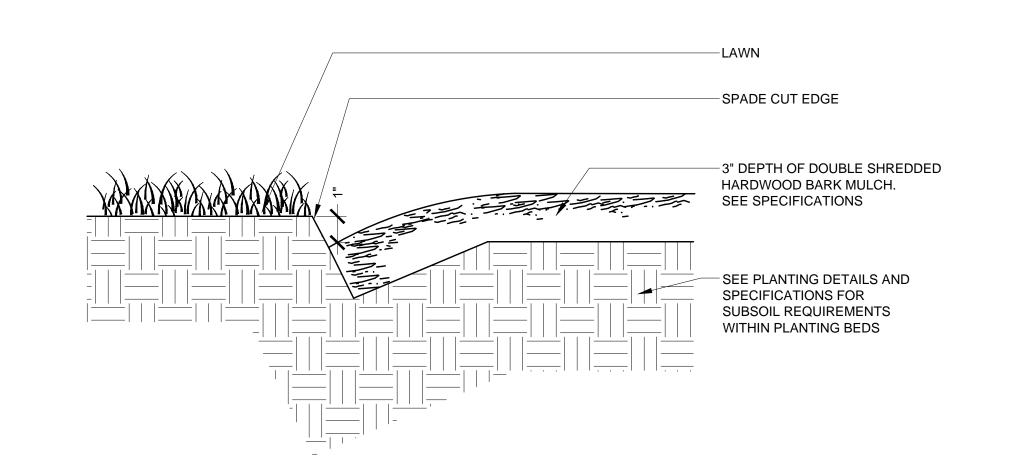



Shrub Planting

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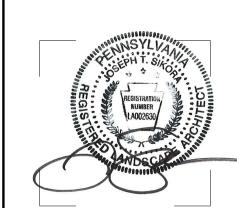
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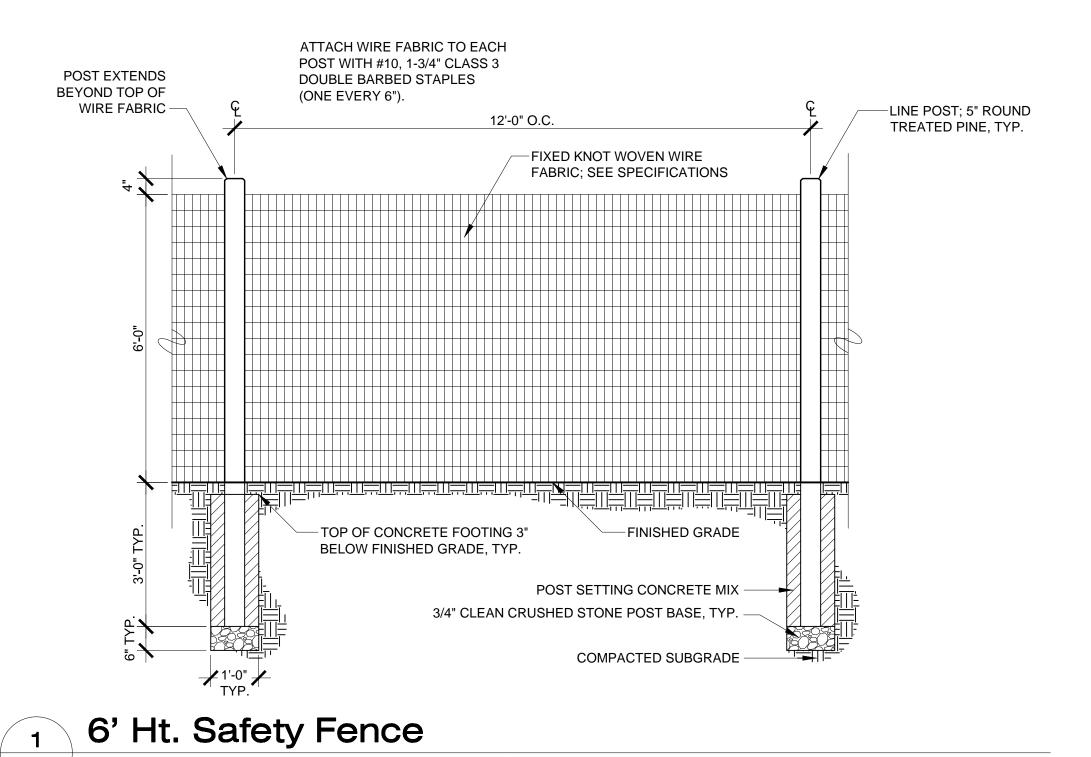
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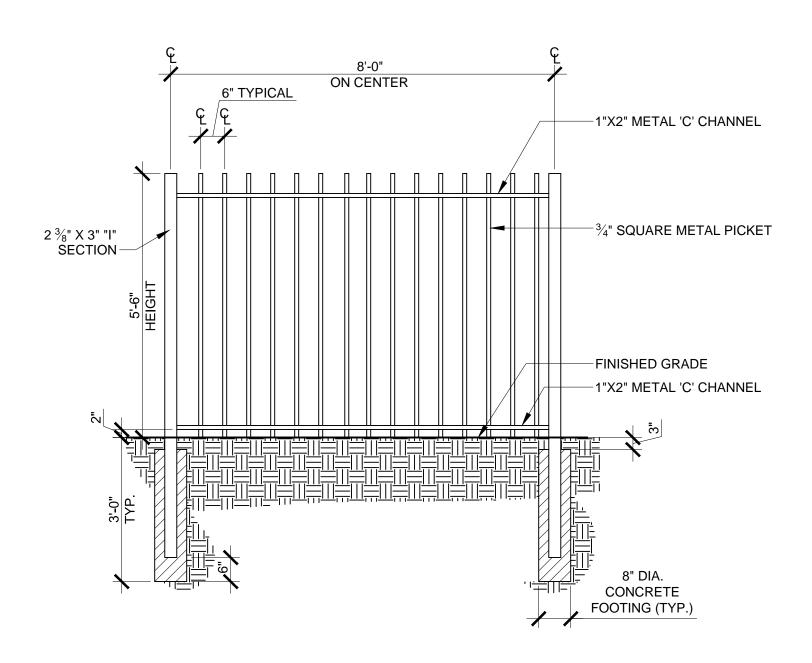
Revision Date

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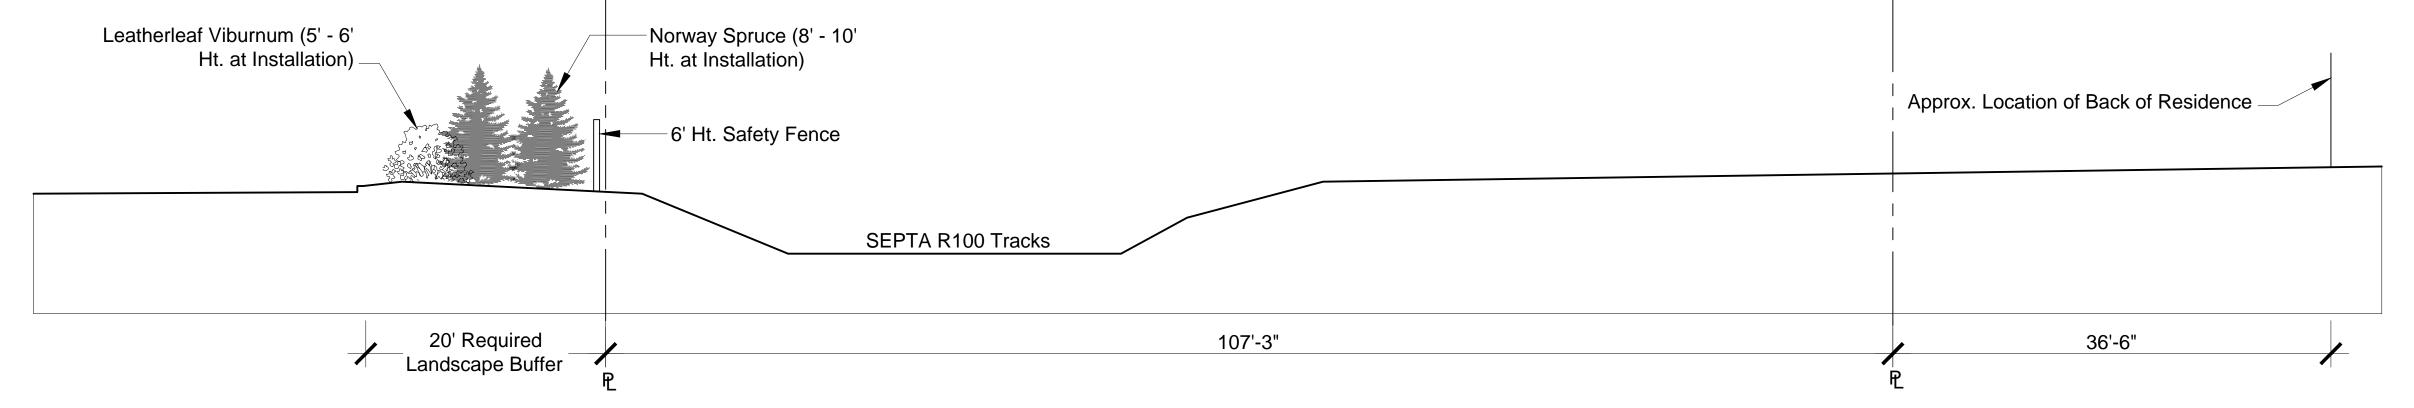
Scale As Indicated Drawn By DF

19 of 20 Sheet No.









Section 01

16' Scale: 1/8"=1'-0"

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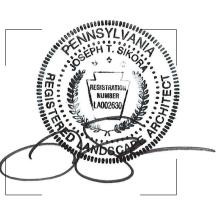
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PRELIM. LAND DEVELOPMENT SUBMISSION

Revision Date March 13, 2015 Title Landscape Details

Scale As Indicated Drawn By RM

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