# PRELIMINARY LAND DEVELOPMENT SUBMISSION FOR LANCASTER AVENUE HOUSING




# Villanova University

## SITUATED IN RADNOR TOWNSHIP, DELAWARE COUNTY, PENNSYLVANIA

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REVISION DATE

4.1			
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28 OF 30	L1.1	PLANTING PLAN	DECEMBER 5, 2014
29 OF 30	1.2.0	PLANTING SCHEDULE, TABULATIONS, AND DETAILS	DECEMBER 5, 2014
30 OF 30	1.2.1	PLANTING DETAILS	DECEMBER 5, 2014

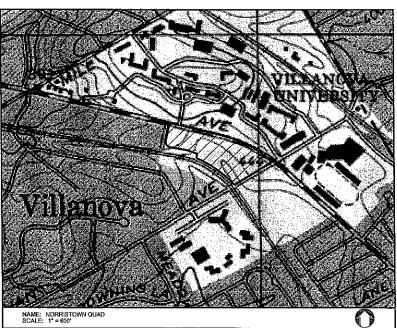

CERTIFICATE OF OWNERSH AND ACKNOWLEDGEMEN

WHO BEING DULY SWORN ACCORDING TO LAW, DEPOSES AND SAYS THAT HEISHE IS THE ON ANDIOR EQUITABLE OWNER OF THE PROPERTY SHOWN ON THIS PLAN, AND THAT HEISHE

WITNESS MY HAND AND SEAL THE DAY AND DATE ABOVE WRITTEN,

MY COMMISSION EXPIRES

OWNER / APPLICANT
VILLANOVA UNIVERSITY
800 E LANCASTER AVE
VILLANOVA, PA 19085

(NOTARY PUBLIC OR OTHER OFFICER)

Villanova University

Lancaster Avenue Housing Lancaster and Ithan Avenues Villanova PA 19085

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Jiac 215-245-1796

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Bala Cyrwyd, PA 19004
phons: 610-667-015



PRELIM, LAND DEVELOPMENT


Revision

Date December


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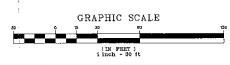
## RADNOR TOWNSHIP UTILITY LIST:

A LET LETCAL SERVICES	IO CONTON I CONTONIN
ADDRESS; 2315 SALEM RD F11	ADDRESS: 301 IVEN AVENUE
CONYERS, GA. 33013	WAYNE PA 19087
CONTACT: NANCY SPENCE	CONTACT: WILLIAM R. HAGEN
EMAIL; rspence@env.oli.com	EMAIL: whagen@radnor.org
AGUA PENNSYLVANIA	FIBER TECHNOLOGIES NETWORK
ADDRESS: 762 LANCASTER AVENUE	ADDRESS: 300 MERIDAN CENTRE
BRYN MAWR, PA. 19010	ROCHESTER, NY 14618
CONTACT: STEVE PIZZI	CONTACT: ROBERT FREED
COMCAST CABLE COMMUNICATIONS	PECO ENERGY
ADDRESS: 110 SPRINGBROOKE BLVD	ADDRÉSS; C/O STS LLC
ASTON, PA 19014	1004 W. BIH AVE
CONTACT: PAUL DABALDO	KING OF PRUSSIA, PA. 19406
EMAIL: paul_dabatdo@cable.comcast.com	CONTACT: WAYNE VINCENT
	EMAIL: wvinicent@stsus.net
ABOVENET COMMUNICATIONS INC	LEVEL 3 COMMUNICATIONS
ADDRESS: 337 CIRCLE OF PROGRESS DR	ADDRESS; 1025 ELDORADO BLVD BLDG
POTISIOWN, PA. 19464	SROOMFELD, CO 80021
CONTACT: CHRIS RICCIUTI	CONTACT: LEVEL 3 OPERATOR
EMAIL: chris.ricciuti@above.net	EMAIL: level3nety/orkrelocations@level3.car
VERIZON PENINSYLVANIA INC	SOUTHEAST PA TRANSPORTATION AUTHORITY
ADDRESS; 900 RACE STREET, 6TH FLOOR	ADDRESS: 123 MARKET ST, 12TH FLOOR
PHILADELPHIA, PA. 19107	PHILADELPHIA, PA., 19107
CONTACT: SUZETTE WALKER	CONTACT: DAVID MONTYPAS
EMAIL; suzette.e.wolker@verizon.com	EWAIL: dmontyydas@septa.org

#### SOILS DATA

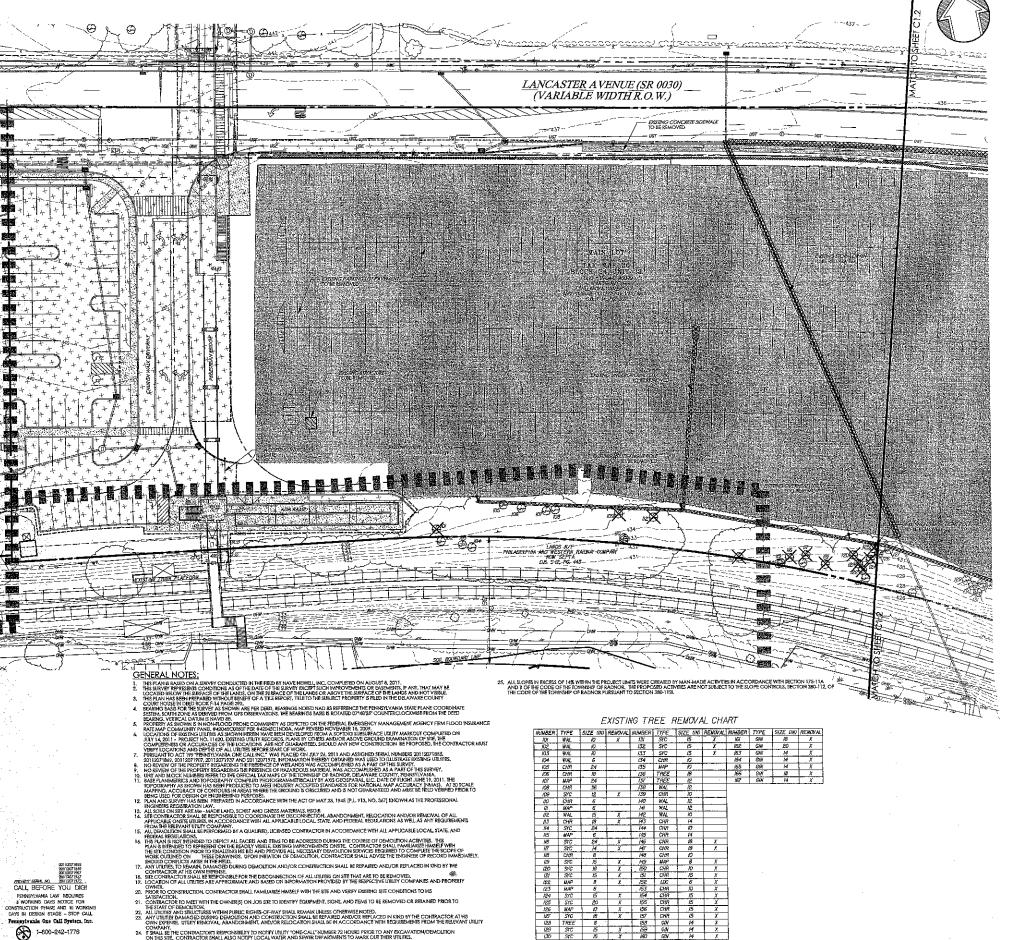SOILS INFORMATION OBTAINED FROM THE USDA-NRCS WEB SOIL SURVI VERSION 6, WITH A DATE OF SURVEY AREA DATA OF FEBRUARY 24, 200 THE FOLLOWING SITE SPECIFIC SOIL CLASSIFICATIONS ARE NOT LISTED A HYDRIC SOILS.

MB\* MADE LAND, SCHIST AND GNESS MATER
\*WHOLE SITE UES WITHIN THIS SOLLS CLASSIFICATION

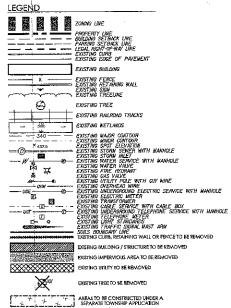

# Villanova University Lancaster Avenue Housing Lancaster and Ithan Avenues Villanova PA 19086

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fac 610-667-0215

Bregging C. Newell



PRELIM. LAND DEVELOPMENT SUBMISSION

Revision Date

 Date
 December 5, 2014

 Title
 Existing Features f

 Demolition Plan


 Scale
 1" = 30"

Drawn By DWN

C1.1

20f30

Contractor to verify all dimensions in field and inform Architect of any discrepancies before starting work.

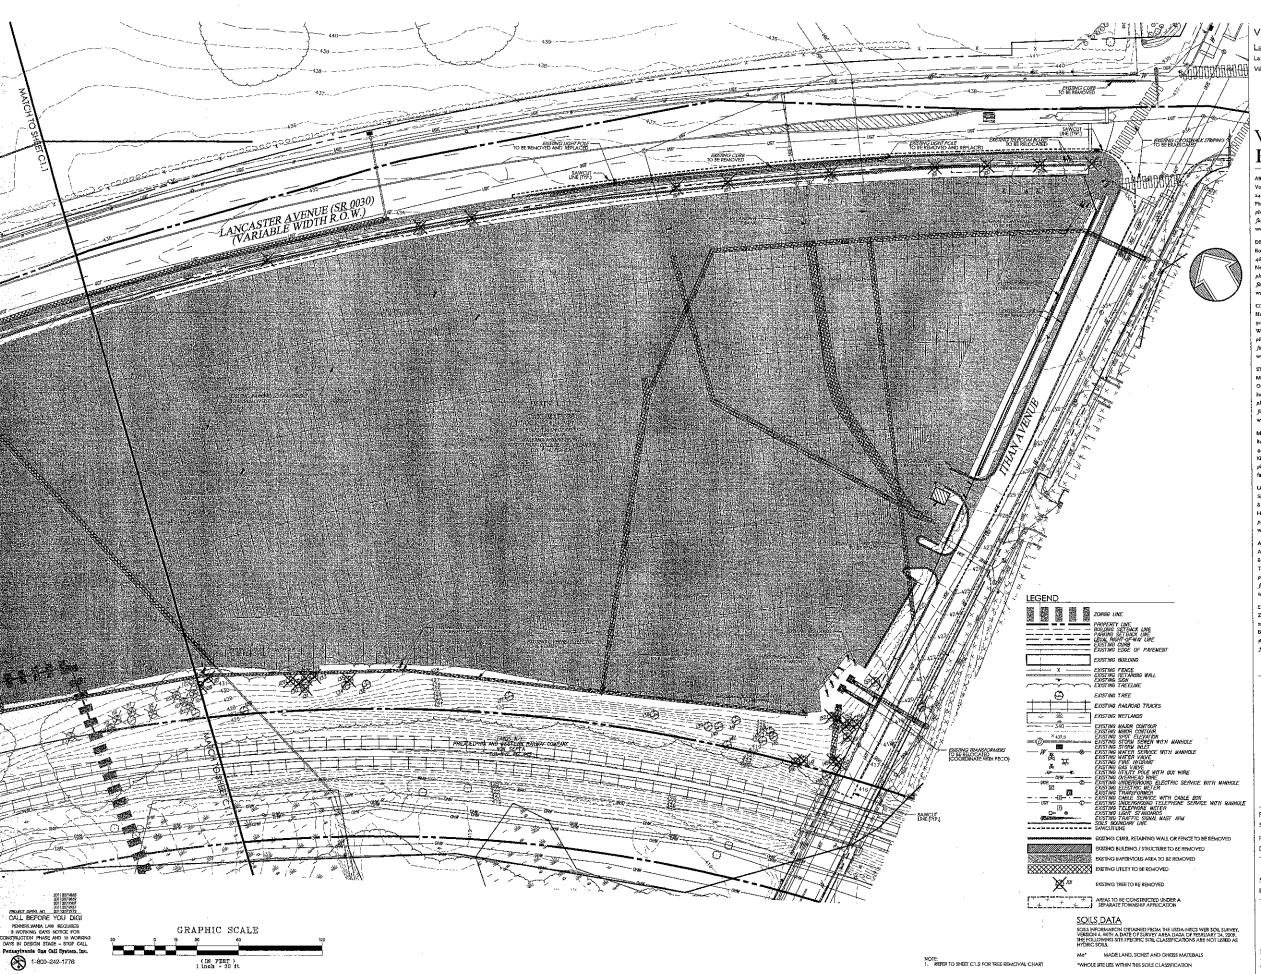

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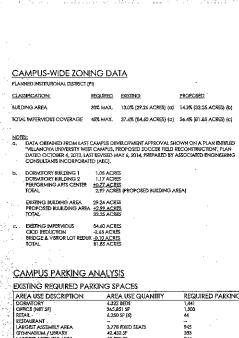
PRELIM, LAND DEVELOPMENT SUBMISSION

December 5, 2014 Existing Features / Demolition Plan

C1.2

3 of 30 Contractor to verify all dimensions in field and inform.

Architect of any discrepancies before starting work,



## REQUIRED PARKING ANICA USE DESCRIPTI DORAMITORY OFFICE (NET SF) RETAIL RESTAURANT LARGEST ASSEMBLY AREA GYMNASILMA / LIBRARY LARGEST ASSEMBLY AREA UNSPECIMED AREA 3,776 FIXED SEATS 42,432 SF 13,722 SF 30,929 SF CES 4,464 SPACE VALLABILITY 5,130 SPACE PROPOSED REQUIRED PARKING SPACES AREA USE DESCRIPTION REQUIRED PARKING

20	DORMITORY.	5,460 BEDS (1)		1,820
j.,	OFFICE (NET SF)	368,091 SF (2)		1.311
- 3	RETAIL	12,371 SF (3)		76
	RESTAURANT	85 SEATS (4)		39
	LARGEST ASSEMBLY AREA	4,178 FIXED SEA	IS (S)	1,045
٠.	GYMNASIUM / LIBRARY	42,432 SF		283
40	LARGEST ASSEMBLY AREA	13,722 SF		344
	UNSPECIFIED AREA	37.179 SF [6]		124
			LSPACES	5.042 SP.
<u>.</u>		PARK	NG AVAILABILITY	5,130 SP
	A second of the first of the second of the s	5URP!	US	88 SPAC
( ).	PROPOSED PARKING TAI	BULATION		_
÷.,	AREA USE DESCRIPTION	EXISTING	PROPOSED	)
Ġ.	MAIN LOT	1,126	62	
Ů.	PIKE LOT	577	1.287	
1,1	VISITOR LOT	aD D	42	
50	W. LANCASTER LOT	79	246	1
	Per a Li Construcción como premo			

TOTAL 5,130 SPACES 5,130 SPACES

11.1138.EES PROPOSES WITHIN DOMNTOWES 1.42C
2.228.ST OFFICE ROPOSES WHICH HE PERF. ARTS CENTER
39.349.95 IN GOOSTORE 2.287.95 CONVENIENCE STORE, 125.55 RETAIL WITHIN
THE PERFORMOR ARTS CENTER. 2.27 JUNIO 125.55
14 SE SERTE 8.20 EMPLOYEES WITHIN PROPOSED BUSTOO
3, 400 SEAT THEASTER WITHIN THE SEAT. ARTS CENTER.

UNAFFECTED CAMPUS SPACES

	ZONING DATA		المستعدد الأرا
	COMPREHENSIVE INTEGRATED COLLEGE DEVELOPMENT DISTRICT (CICD)		
	CLASSIFICATION:	REQUIRED	PROPOSED
	MINIMUM CAMPUS AREA	75 ACRES	225 ACRES [PIZONING DISTRIC
			15 ACRES (CO ZONING DISTRIC 240 ACRES (TOTAL CAMPUS)
	MINIMUM/MAXIMUM CICD AREA	>10 / <15 ACRES	13,81 GROSS ACRES 11,71 NET ACRES
	MAXIMUM BUILDING LENGTH - MINIMUM BUILDING SEPARATION	180	171'
	BETWEEN BUILDING AND BUILDING	45'	45
	BETWEEN BUILDING AND PARKING STRUCTUREMAXIMUM BUILDING HEIGHT	30'	30'
٠,	ACADEMIC AND PERFORMANCE FACILITIES	50'	<5Y
ŀ	FLY LOFT	65 <sup>1</sup>	<65"
	HOUSING AND SOCIAL FACILITIES	45'	<45'
	PARKING STRUCTURE	38'	<36'
۱	MAXIMUM BUILDING COVERAGE - TOTAL (INCLUIDES PARKING STRUCTURE) MAXIMUM BUILDING COVERAGE - INDIVIDUAL	30%	35.5%*
	RESIDENCE HALL 2	10%	7.6%
	RESIDENCE HALL 1	10%	B,5%
	PERFORMING ARTS CENTER	10%	5.6%
	MINIMUM FACILITY SETBACK FROM SINGLE FAMILY RESIDENTIAL USE	100*	227.8
	MINIMUM ELEVATORISTAIR TOWER ON PARKING STRUCTURE SETBACK	10'	16
	MAXIMUM LENGTH OF ELEVATOR/STAIR TOWER PROJECTION	50'	41.4'
	. MINIMUM LOADING AREA SETBACK	5"	5'
,	RIPARIAN BUFFER SETBACK	50'	82,5
	MAXIMUM IMPERVIOUS AREA	82%**	69%


TRIBLAND, LUVERAGE EXCEEDING 30% SHALL REQUIRE TWO SQUARE FEET OF OPEN SPACE DEDICATION FEE ONE SQUARE SQUARE SECRETARY SOME SOME SALLDING COVERAGE REQUIRES 66,212 SF OPEN SPACE DEDICATION. (87,120 SF PROVIDED) [REFER TO THE SHEET FOR LOCATION OF PRESERVATION AREA]

PROPOSED IMPERVIOUS CONDITIONS MUST BE A MINIMUM TOX REDUCTION FROM EXISTING IMPERVIOUS AREA 92% EXISTING IMPERVIOUS COVERAGE - 10% = 82%

4.7 to 1								
SETBACK CHART	ARTERIAL STREETS		1	MINOR COLLECTORS		RAILROAD RIGHTS-OF-WAY		
	REQUIRED	PROPOSED	1	REQUIRED	PROPOSED	١ſ	REQUIRED	PROPOSED
PERFORMANCE AND SOCIAL FACILITIES	35'	38.2	Г	30`	65'	П	50"	332'
HOUSING FACILITIES	35	39*	Γ	30"	30'	П	50'	61.6
PARKING STRUCTURES	120'	169.5	Г	20"	211	Т	30'	30"
SURFACE PARKING LOTS	4D,	237.7	ī	60.	103"	Ţ	5'	12'
RETAIL SUBORDINATE USES	35	39'	Г	30	30 <sup>i</sup>	Т	50'	234.4"

201207185 201207189 201207189 201207189 201207187 201207187 CALL BEFORE YOU DIG! PENNSYLVANIA LAW REGUIRES 3 WORKING DAYS NOTICE FOR ONSTRUCTION PHASE AND 10 WORKING DAYS IN DESIGN STAGE - STOP CALL PENNAYLYANIA ONE CAIL System, Inc. 1-800-242-1776



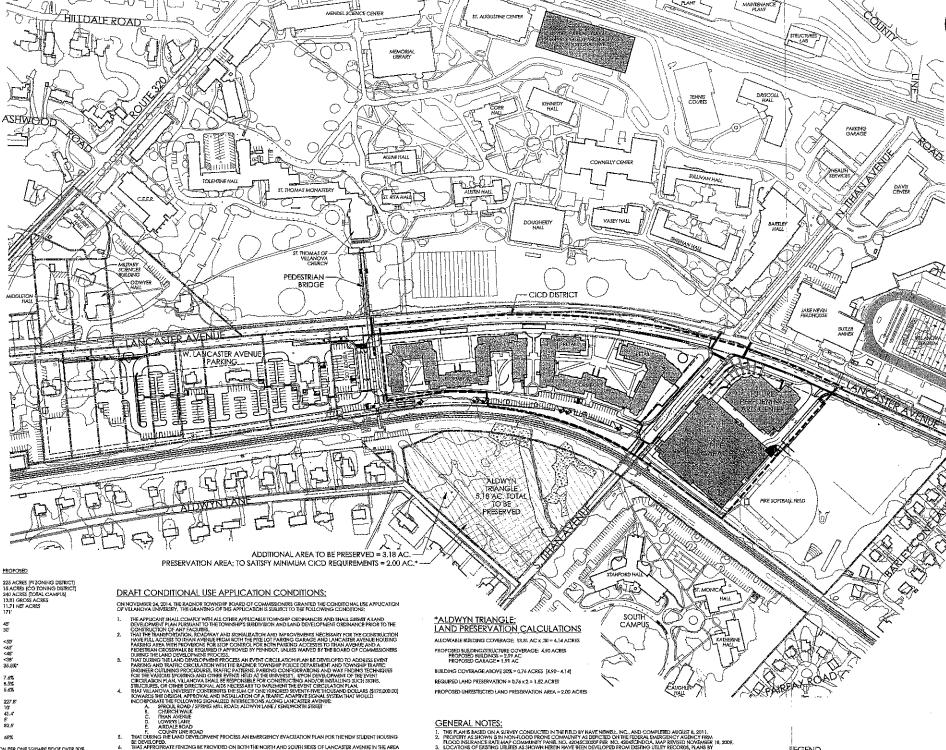

THAT DISEASE WHEN THE CARD.

THAT STEERAGE THE RECORD FROM THE PROCESS AN EMERGENCY EVACUATION PLAN FOR THE NEW STUDENT HOUSING BE DEVELOPED.

THAT APPROPRIATE FRACTIONS BE PROVIDED ON BOTH THE NORTH AND SOUTH SIDES OF LANCASTER AVENUE IN THE AREA OF THE CHIERCY WHAT PEDESTRUEN BEDGE HAS MERGENT TO RESTRICT HE DESTRUENT HOUSE FROM ACCESSING FROM ACCESSING FROM ACCESSING FROM ACCESSING FROM ACCESSING FROM THE PROPRIATE HAS THE CHIEF FROM ACCESSING FROM ACCESSING FROM ACCESSING FROM ACCESSING FROM THE ATTEMPT HE PROPRIATE PROTECTION OF THE AREA NECESSARY TO PROVIDE HANDICAP ACCESSING THE MERGENT HAS DEPOSITED FROM THE ACCESSING FROM THE AREA NECESSARY TO PROVIDE HANDICAP ACCESSING THE MERGENT HAS DEPOSITED FROM THE ACCESSING FR

CENERAL NOTES:

1. THIS PLANS & SACED ON A SURVEY CONDUCTED IN THE RIELD BY NAVENEWELL INC., AND COMPLETED AUGUST 8, 2011.

2. PROPERTY AS SHOWN B IS NON-FLOOD PRONE COMMUNITY AS DEPICIED ON THE FEDERAL EMERCIPICY AGENCY FIRM FLOOD NATIONAL PLANS AS HOND FROM COMMUNITY PARENT BY A SHARP PROPOSED THE FEDERAL EMERCIPICY AGENCY FIRM FLOOD NATIONAL PLANS AND PROPOSED THE CONTRACTOR MULTI VERY BY AND PROPOSED THE CONTRACTOR MULTI VERY LOCATIONS AND DEPICE OF THE PROPOSED THE CONTRACTOR MULTI VERY LOCATIONS AND DEPICE OF AUGUST FROM THE PROPOSED THE CONTRACTOR MULTI VERY LOCATIONS AND DEPICE OF AUGUST FROM THE PROPOSED THE PROPOSED THE CONTRACTOR MULTI VERY LOCATIONS AND DEPICE OF AUGUST FROM THE PROPOSED THE PROPOSE

DETERMINE POSITION OF THE STREET OF THE STRE

ELLIUM SUBJECT FO OBTAINING APTROVED ENGINE AND SECRETARIEM CONTROL FOR THE ACTIVITY.

THE CONSERVATION DISTRICT, PRIOR TO CLEARING OR EARTH MOVING ACTIVITY.

URVED SECTIONS OF CURBING SHALL HAVE A FIVE FOOT RADIUS (R=5!), UNLESS NOTED OTHERWISE AS SHOWN ON

THIS FLAM.

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LEGAL RIGHT-OF-WAY LINE
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EXISTING CURB
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#### Villanova University

Lancaster Avenue Housing ncaster and Ithan Avenue

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Bregory C. Newself



PRELIM, LAND DEVELOPMENT SUBMISSION


Revision

Date December 5, 2014 Title Composite Site Plan

Scale 1" = 150" Drawn By MMB


C2.0

Sheet No.

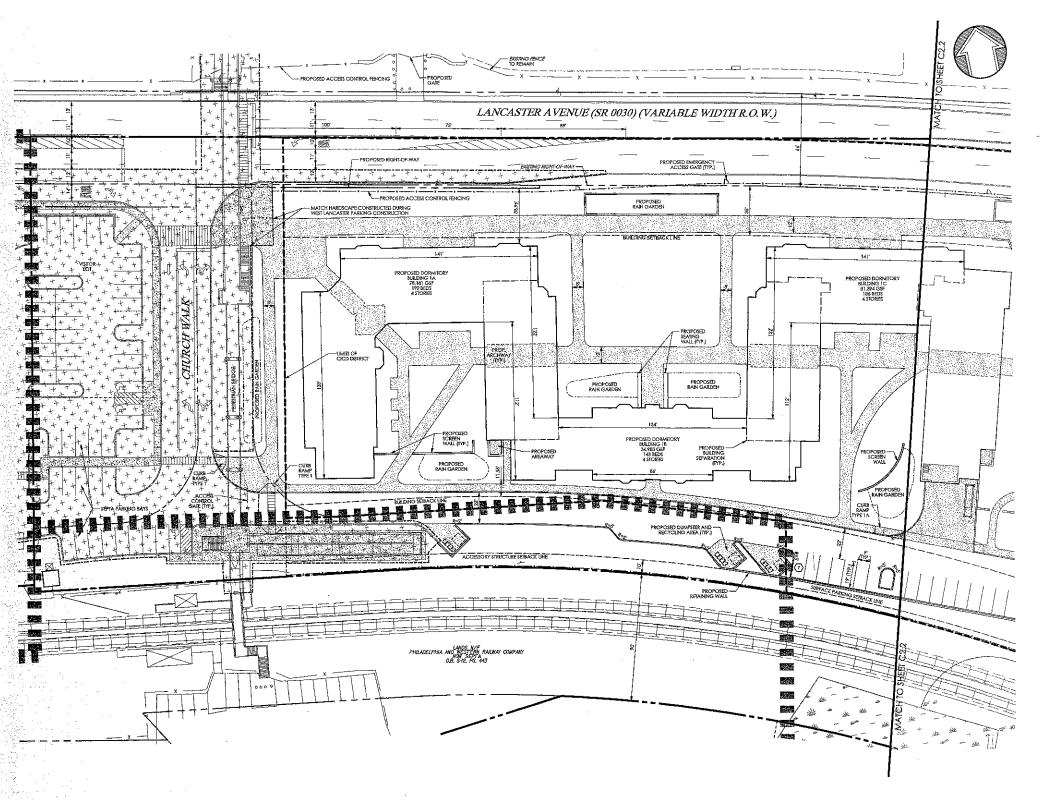

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SILIZO



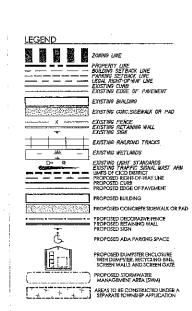

GRAPHIC SCALE

(IN FEET ) 1 inch - 30 ft



REFER TO SHEET C2.0 FOR NOTES. Contractor to verify all dimensions in field and inform

Villanova University

Lancaster Avenue Housing

Lancaster and Ithan Avenues

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## Bragary C. Newell



PRELIM. LAND DEVELOPMENT SUBMISSION

Revision


Date Decem Title Site Pla

1"=30"

Drawn By MMB

heet No.

No. 5 of :

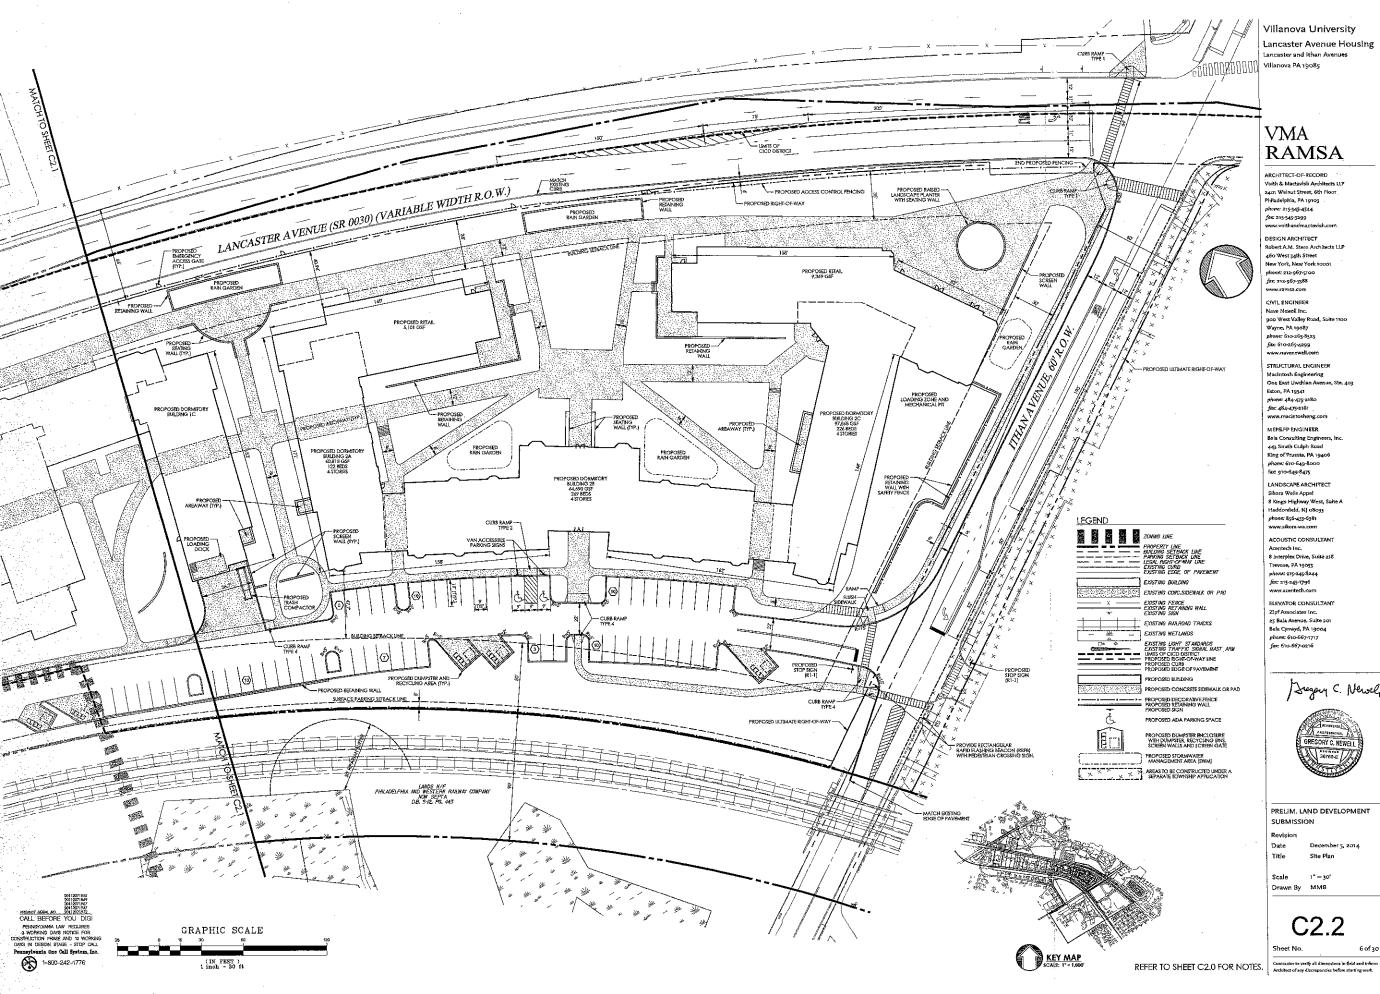

Lancaster Avenue Housing Lancaster and Ithan Avenues Villanova PA 19085

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PRELIM. LAND DEVELOPMENT SUBMISSION

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Scale Drawn By MMS

C2.2

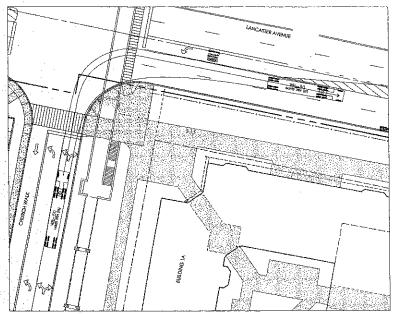


EXHIBIT 1: CHURCH WALK TO LANCASTER AVENUE - RIGHT TURN (WB-50)

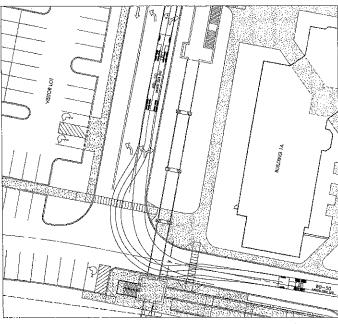


EXHIBIT 3: SITE TO CHURCH WALK: RIGHT TURN (WB-50)

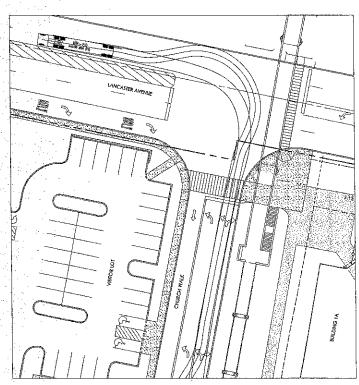
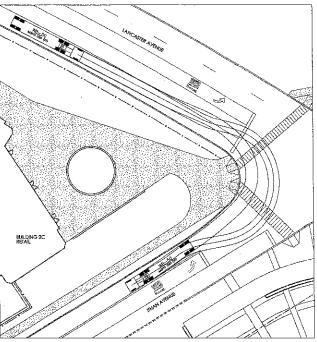
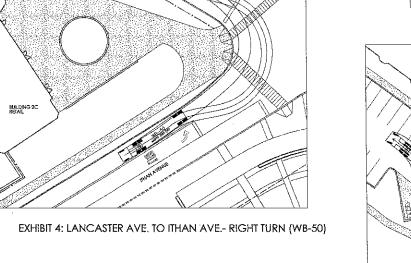


EXHIBIT 2: CHURCH WALK TO LANCASTER AVENUE - LEFT TURN (WB-50)







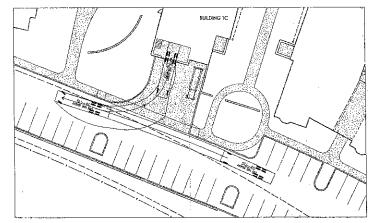


EXHIBIT 5: BUILDING 1C LOADING DOCK (BOX TRUCK)

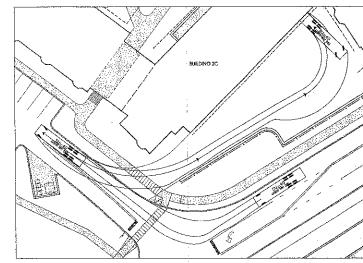


EXHIBIT 6: BUILDING 2C CENTRAL UTILITY PLANT ACCESS (BOX TRUCK)

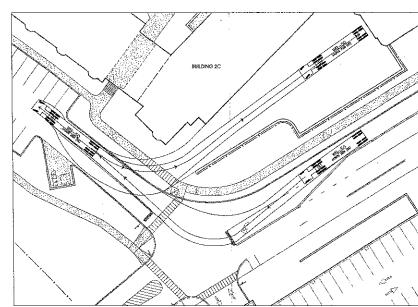


EXHIBIT 7: BUILDING 2C LOADING DOCK ACCESS (WB-50)

Lancaster Avenue Housing Lancaster and Ithan Avenues Villanova PA 19085

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STRUCTURAL ENGINEER Macintosh Engineering One East Uwchlan Avenue, Ste. 403 phone: 484-475-2180 fex: 484-475-2181 www.macintosheng.com

MEP&FP ENGINEER Bala Consulting Engineers, Inc. 443 South Gulph Road King of Prussia, PA 19406 phone: 610-649-8000

LANDSCAPE ARCHITECT Sikora Wells Appel

8 Kings Highway West, Suite A
Haddonfield, NJ 08033 phone: 856-433-6381

ACOUSTIC CONSULTANT Acentech Inc. 8 Interplex Drive, Suite 218 Trevose, PA 19053 phone: 215-245-8244 fux: 215-245-1796


Zipf Associates Inc. 25 Bala Avenue, Suite 201 Bala Cynwyd, PA 19004 phone: 610-667-1717 fax: 610-667-0216



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Drawn By OGY


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GRAPHIC SCALE

(IN FEET ) 1 inoh - 30 ft

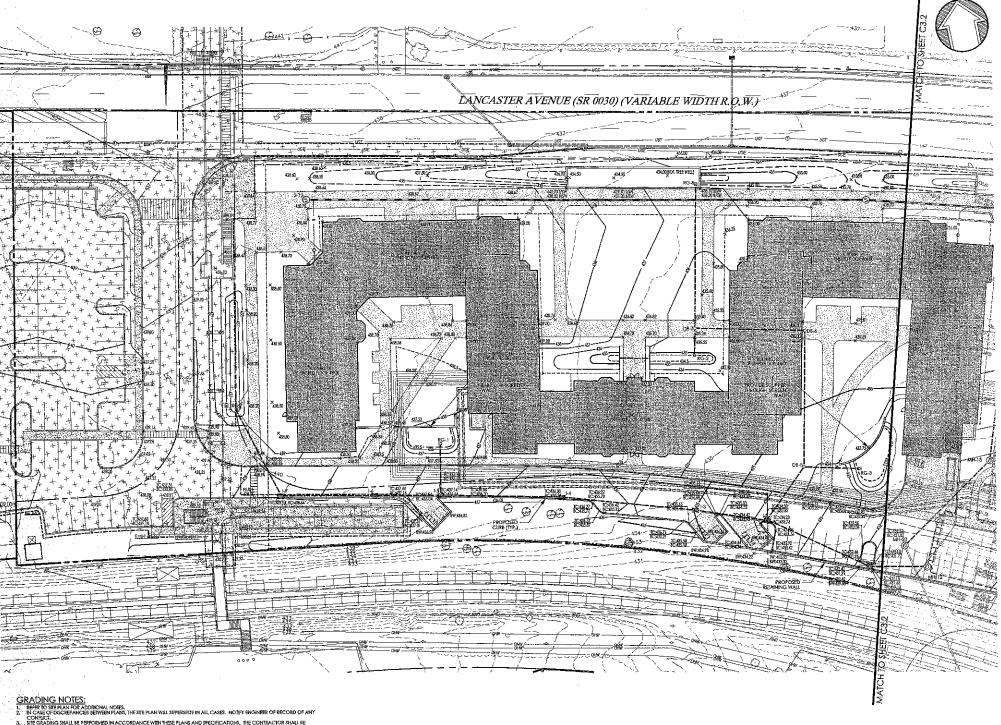Villanova University

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## VMA. **RAMSA**

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December 5, 2014 Title Grading Plan

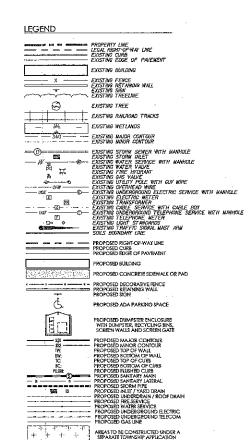
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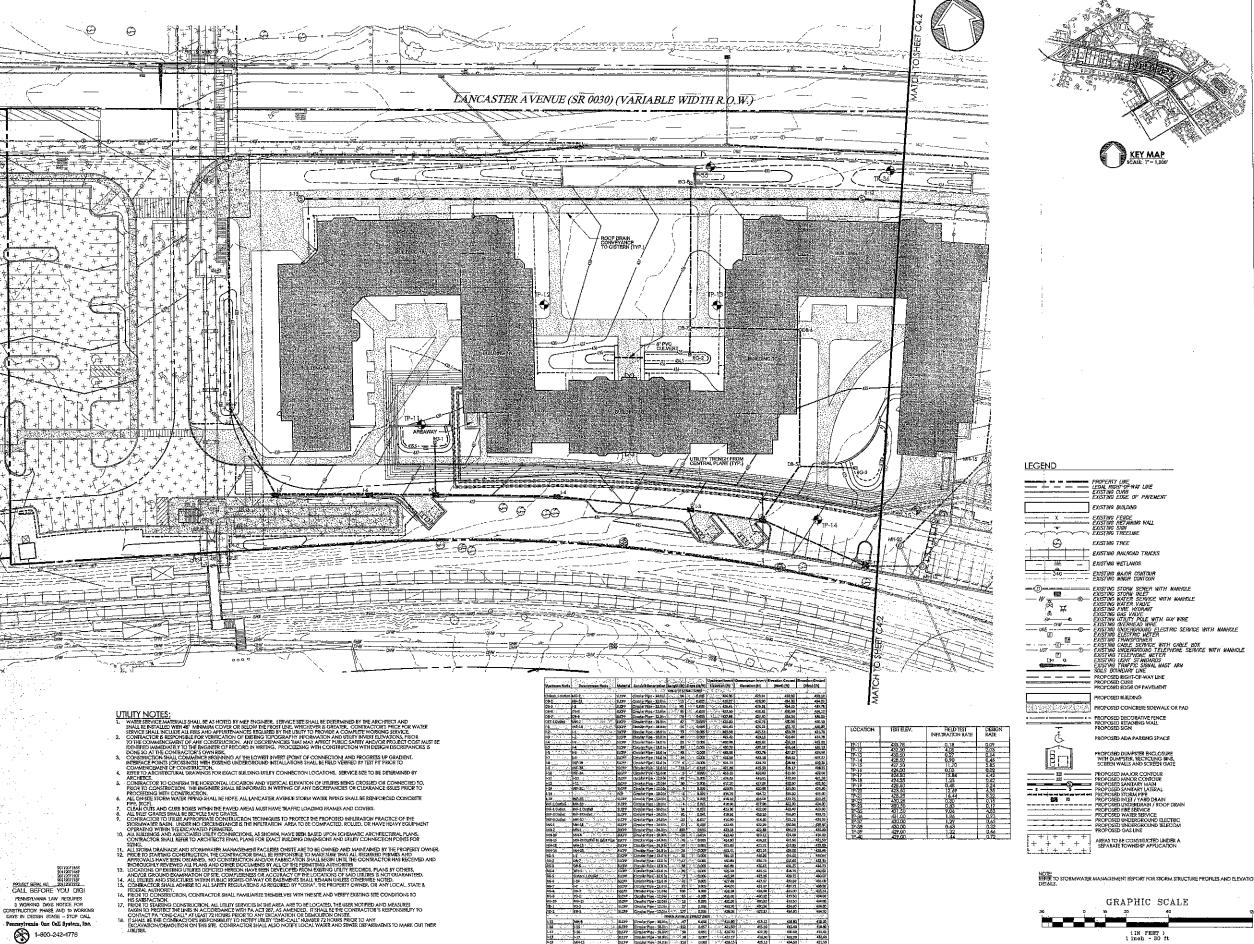
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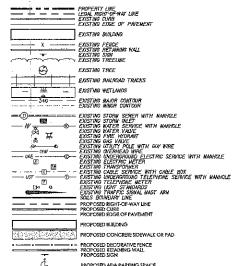
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8 of 30







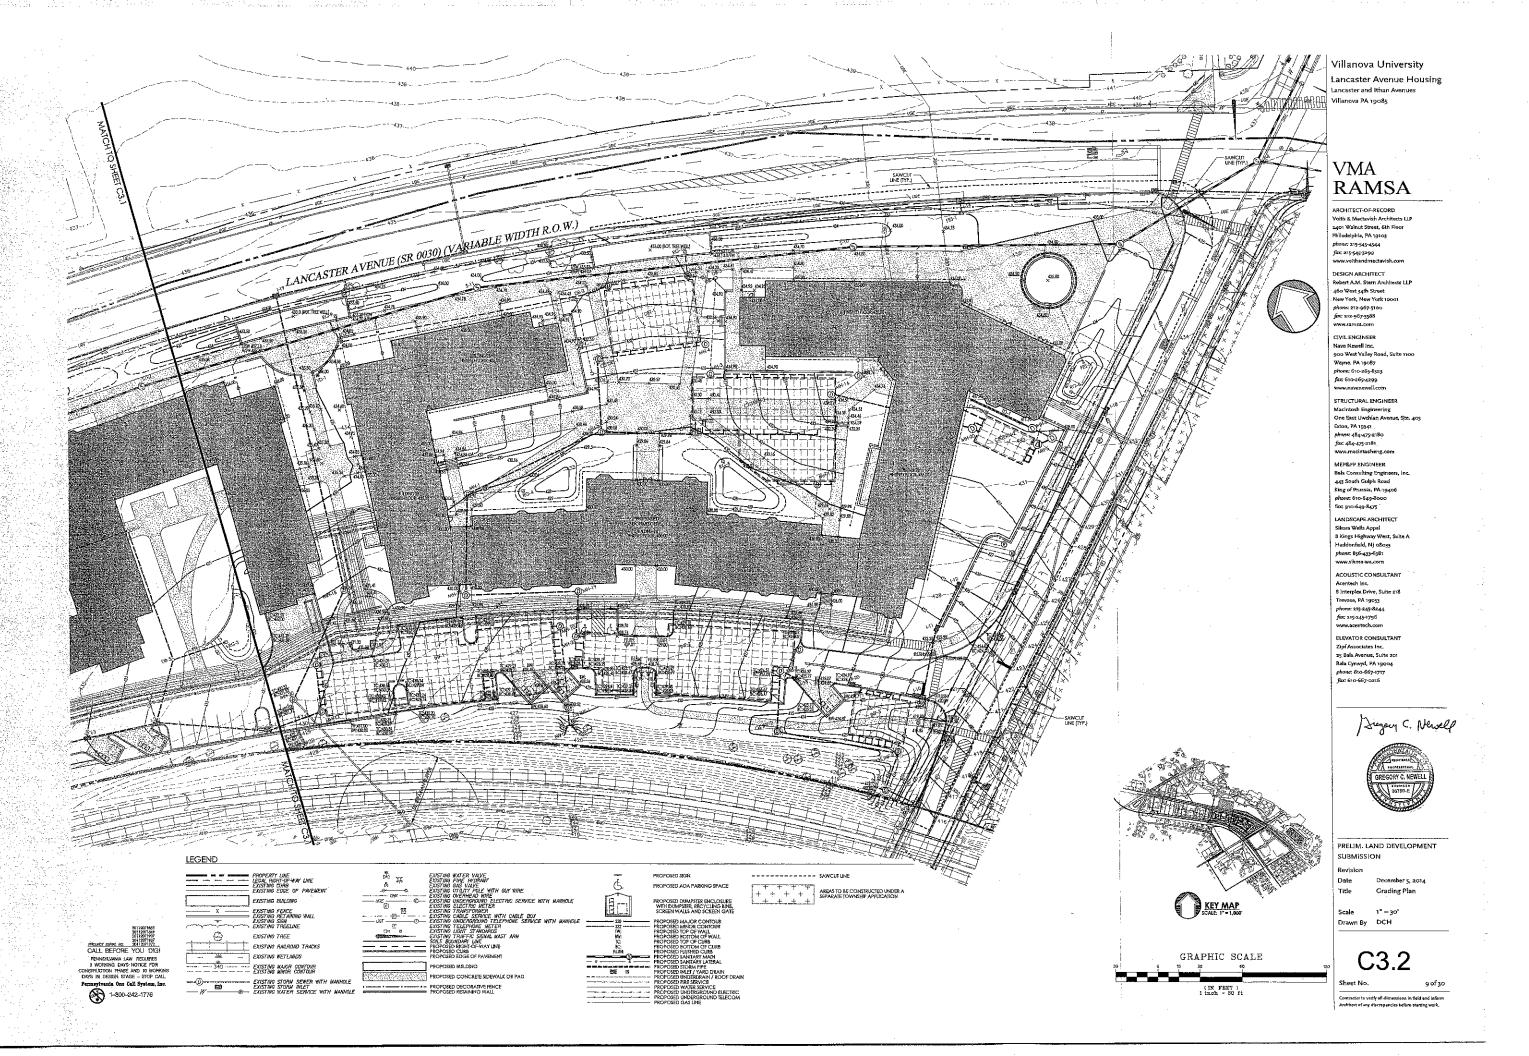

GRAPHIC SCALE

(IN FEET ) 1 inch - 30 ft

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Buggy C. Newell

PRELIM. LAND DEVELOPMENT SUBMISSION

Villanova University Lancaster Avenue Housing Lancaster and Ithan Avenue Villanova PA 19085

VMA **RAMSA** ARCHITECT-OF-RECORD Voith & Mactavish Architects LL 2401 Walnut Street, 6th Floor Philadelphia, PA 19103

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Bala Cynwyd, PA 19004 phone: 610-667-1717 fax: 610-667-0216

Zipf Associates Inc. 25 Bala Avenue, Suite 201

fix: 215-245-1796


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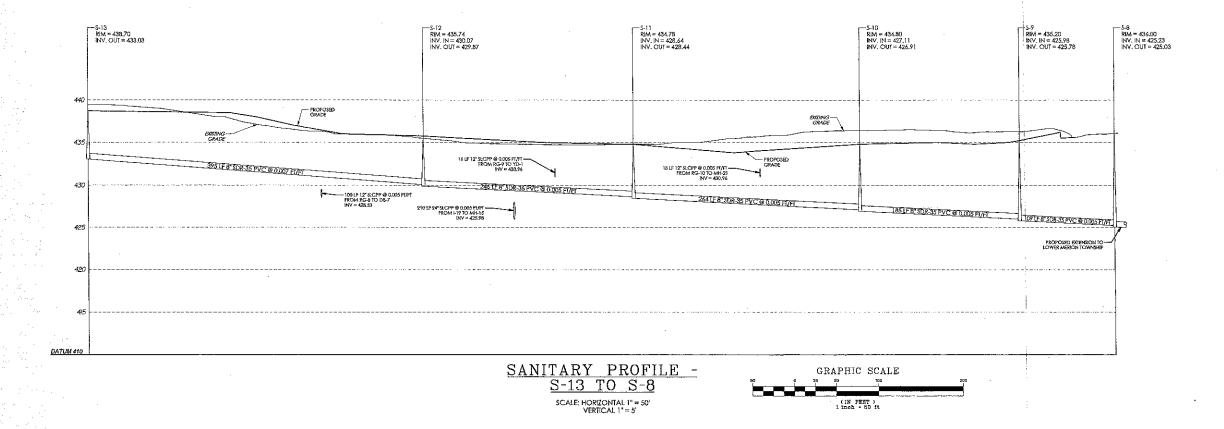
MacIntosh Engineering One East Uwchlan Avenue, Ste. 403 Exton, PA 19341 fax: 484-475-2181 MEP&FP ENGINEER Bala Consulting Engineers 443 South Gulph Road King of Prussia, PA 19406 phone: 610-649-8000 fax: 910-649-8475 LANDSCAPE ARCHITECT

December 5, 2014 Btle Utility Plan

Scale 1" = 30" Drawn By DCH

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Villanova University

Lancaster Avenue Housing Lancaster and Ithan Avenues Villanova PA 19085
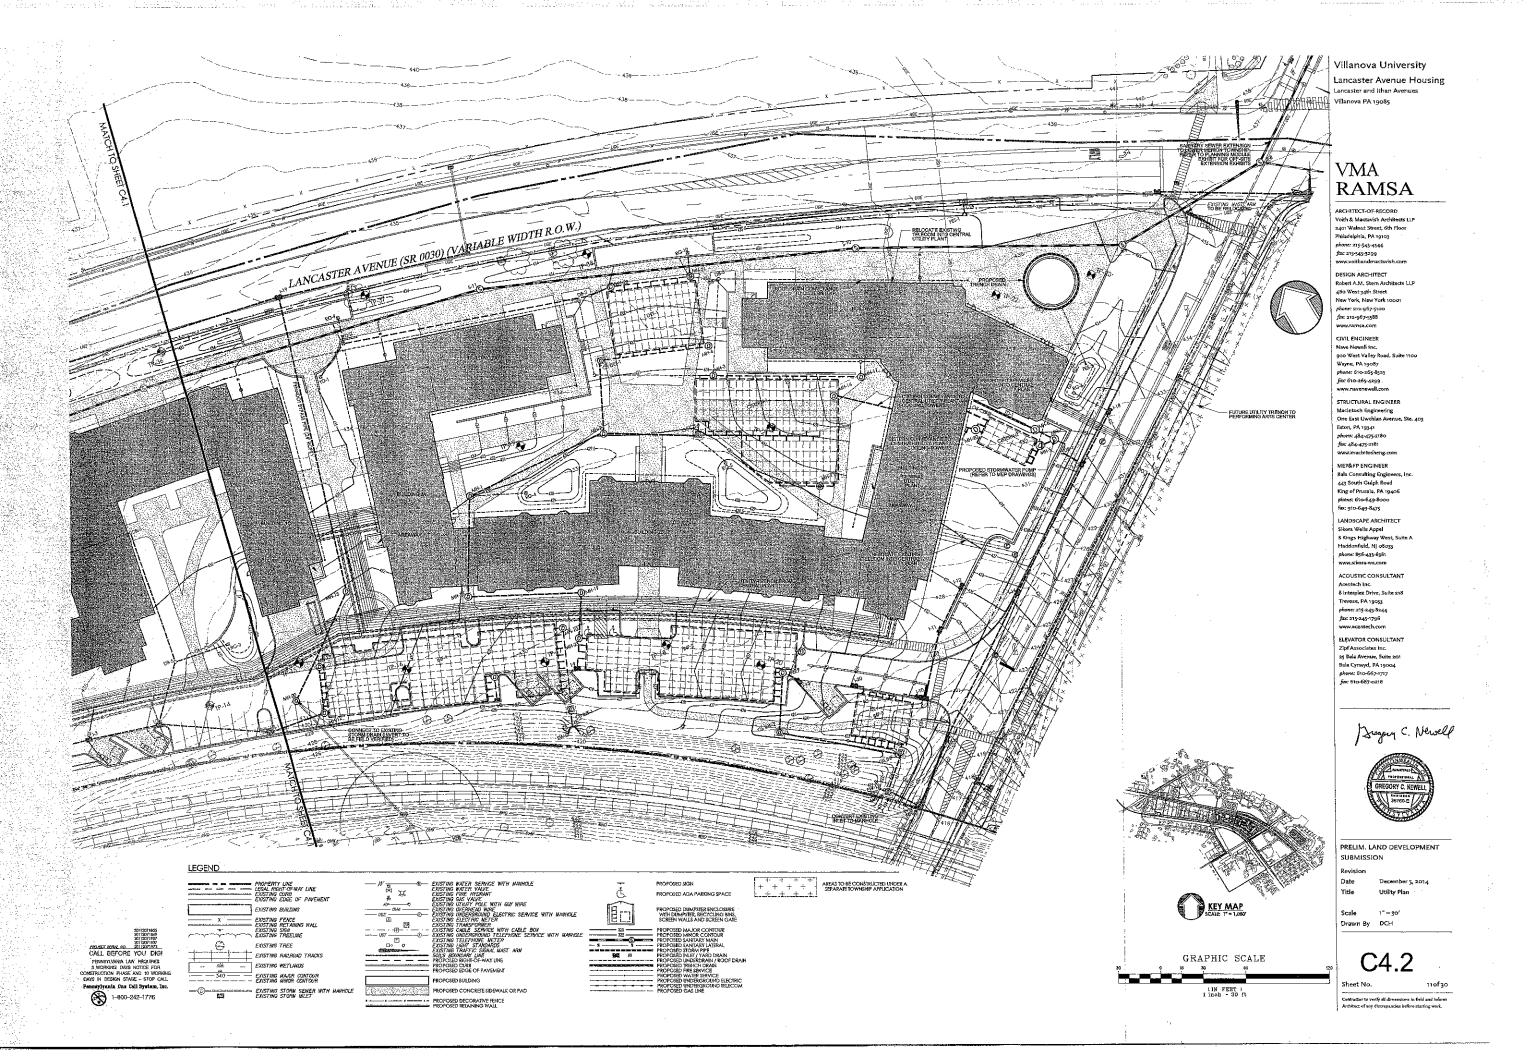
## VMA RAMSA

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WWW.Acentech.com
ELEVATOR CONSULTANT
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Bala Cyrmyd, PA 19004
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face 610-667-0216

Hugary C. Newell



PRELIM. LAND DEVELOPMENT SUBMISSION

Revision


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Architect of any discrepancies before starting work,



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LEGAL RIGHT-OF-WAY LINE

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GRAPHIC SCALE

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## Villanova University

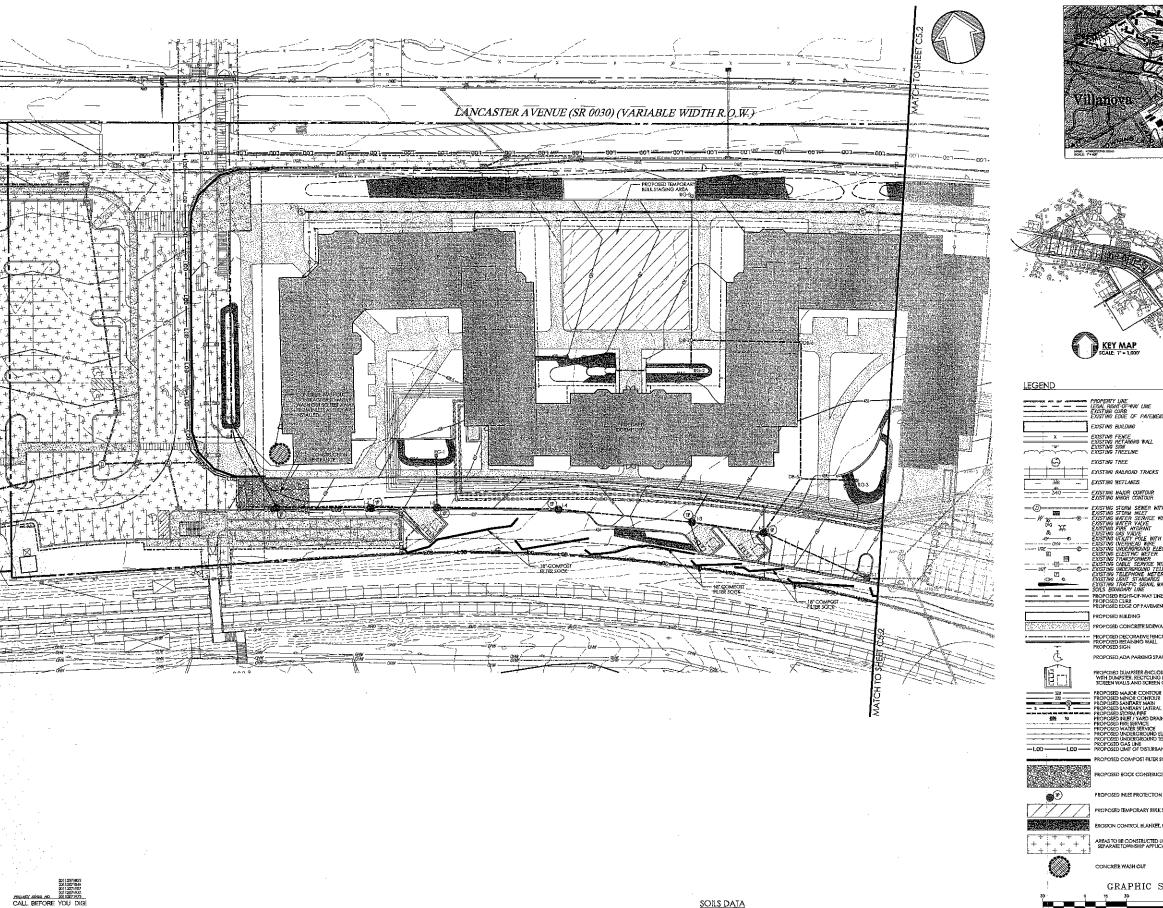Lancaster Avenue Housing ancaster and Ithan Avenues Villanova PA 19085

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fac 215-245-1796

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Baggy C. Newell



PRELIM, LAND DEVELOPMENT SUBMISSION

December 5, 2014 Title Erosion & Sedim Control Plan


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\*WHOLE STIELLIES WITHIN THIS SOILS CLASSIFICATION

THIS PLAN FOR EROSION AND SEDIMENTATION CONTROL PURPOSES ONLY. Contractor to verify all dimensions in field and inform Antibited of any discrepandes before starting work.



#### GENERAL CONSERVATION NOTES AND SPECIFICATIONS

SUPPACES AND AND ADDRESS OF THE ADDRESS OF SUPPACES, SUPPACES, AND ADDRESS OF THE ADDRESS OF THE
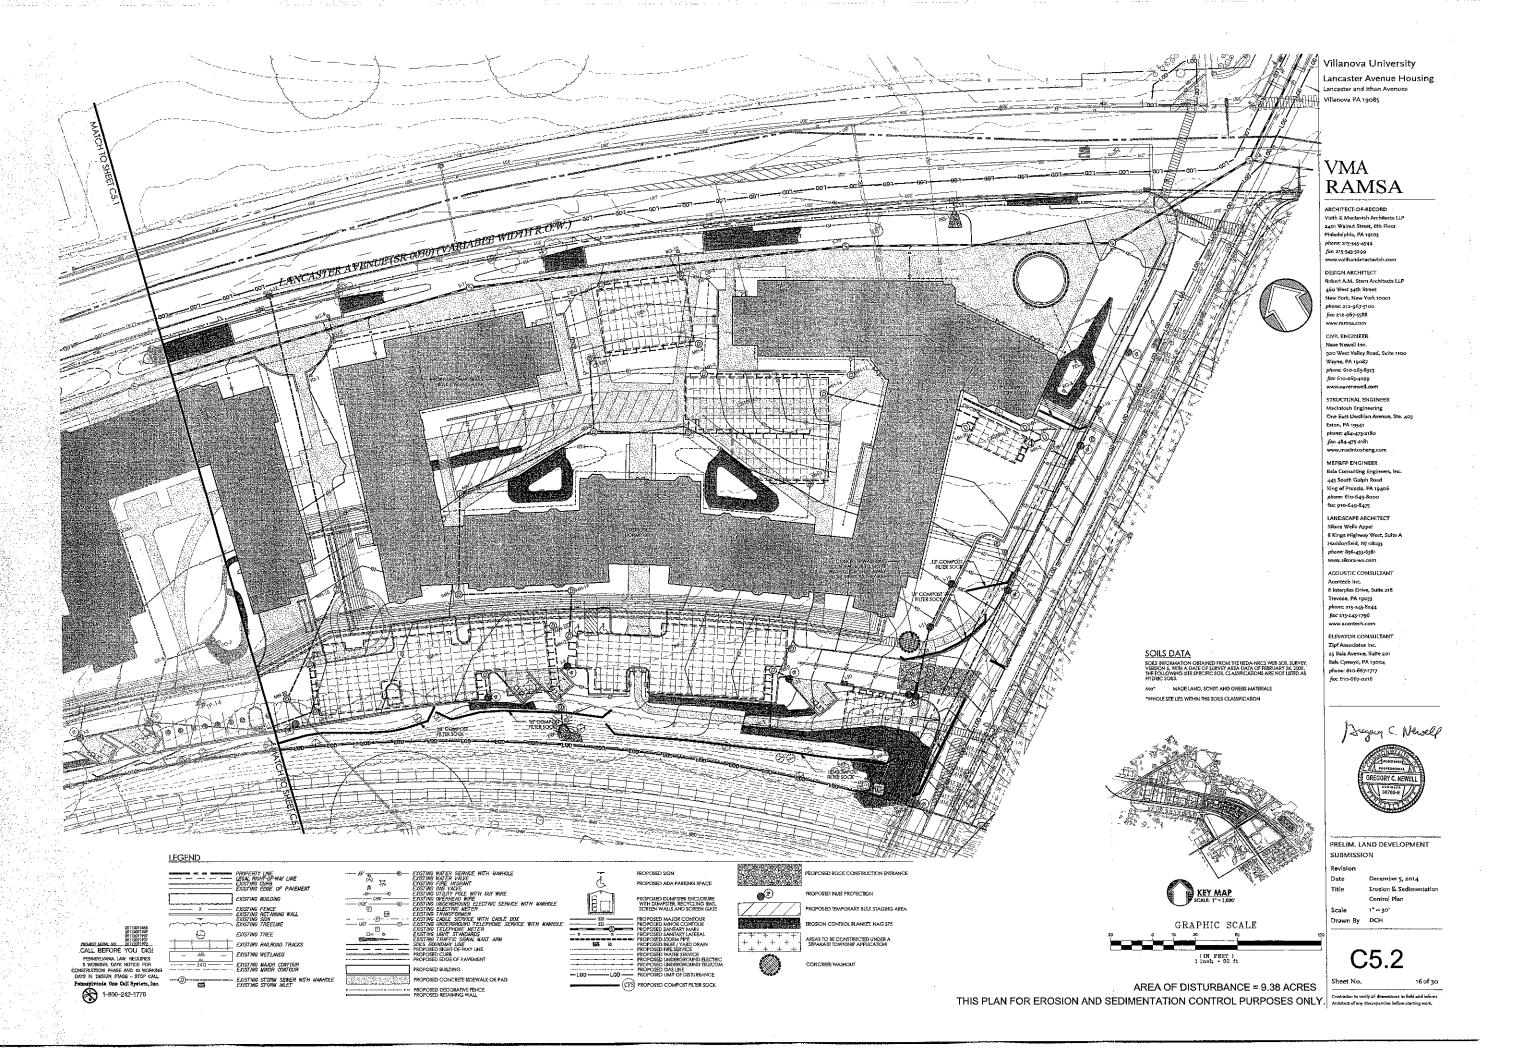
### SEEDING & MULCHING SPECIFICATIONS TIVE SEED PERCENTAGE SHALL BE 85% OR GREATER

TEMPORARY: SEEDING SHALL BE COMMON BYE GRASS APPLIED AT 45 LBS.
PER ACRE. LIMING TO BE APPLIED AT 1 TOM/ACRE.
50-50-50 FERTILIZER TO BE APPLIED AT 3 TOM/ACRE.
HAY OR STRAW MULCOLT OB BE APPLIED AT 3 TOM/ACRE.

SEEDING SHALL BE 15% KENTUCKY BURGERASS, 35% KENTUCKY 31 ESCUE, 2055 CHENNIKOS FECUE, 15% FORENMAL KITE GENES 14 MINOR TO BE PRIED AT 3 TONS/ACRE. INDOOR DERBILIZE TO BE APPLIED AT 1001.85/ACRE. HAY OR STRAW MUTCH TO BE APPLIED AT 3 TONS/ACRE.

THE NON-GERMINATING PERIODS ARE BETWEEN 47 IS THROUGH 9/15 AND 9/50 THROUGH 47/15. AREA SIGUREED DURING THEST PERIODS USING THE SUBJECT AND 9/50 THROUGH 47/15. AREA SIGUREED DURING THEST PERIODS. TOPICAL TAKEN FROM CONSTRUCTION AREA SHALL BESTEDS WITH VICCITATIVE COVER AND STOCKPILES FOR REJUSE IN MINISH GRADING. THERE IS TO BE NO EARTH DISTURBANCE OF WESTGLATIVE CLEARING IN AREA CONTINUED OF

MAINTENANCE PROGRAM FOR TEMPORARY SEDIMENTATION CONTROLS STRUCTURES MAINTENANCE OF ALL TEMPORARY SEDIMENTATION CONTROL STRUCTURES SHALL BE THE RESPONSIBILITY OF THE DEVELOPER AND AS STATED BELOW:

- BETHE REPONSIBILITY OF THE DEVILOPER AND AS TAILED BELOW:

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  EPICTUM HIGH OF CONNOCIT FILTS FOLKS.

  1. SEDIMENT MILIT BE REMOYED WHEN ACCUMULATIONS REACH ONE-HALF THE
  EPICTUM HIGH OF CONNOCIT FILTS FOLKS.

  3. NUETHEORY OF THE REMOYED THE STATES THAT THE STATES AND THE STATES THAT THE

#### \_ MAINTENANCE OF TEMPORARY SEDIMENTATION CONTROL STRUCTURES

MARTENANCE OF ALL TEMPORARY SEDIMENTATION CONTROL STRUCTURES SHALL BEIN ACCORDANCE WITH THESE PLANS AND THE "RECISION AND CONTROL HARRATIVE," INSPECTION AND MARTENANCE OF ALL FACILITIES SHALL BEINADE AFTER EACH RAIN STORM RYEN AND ON A WEEKLY BASIS.

#### SEDIMENTOISPOSAL:

SILT REMOVED FROM TEMPORARY, SEDIMENT CONTROL STRUCTURES SHALL BE DEFOSED FOR HIS FIR IN LANDSCAPED AREA LOCATED HAS BEEN AND SEDIMENT OF THE SEDIMENT CAN SEDIMENT DEFOSAL SHALL BE CONSIDERED CYA. SILT AND SEDIMENT CATECORIZED AS CONTAMENATED SHALL DISPOSED OF THE THE SOLD MANAGEMENT NOTES.

#### DUST CONTROL:

DUST AND OTHER PARTICULATES SHALL BE KEPT WITHIN TOLERABLE LIMITS BY USING WATER. APPLICATION SHALL BE AS NEEDED OR AS DIRECTED BY THE TOWNSHIP ENGINEER OR THE CONSERVATION DIST

#### CRITICAL VEGETATION AREAS (C.V.A.);

CRITICAL VEGETATION AREAS ARE TO BE GRADED, HYDROSEFDED AND MULCHED WITHIN 10 DAYS OF THE BEGINNING OF EXCAVATION, IN GENERAL CRITICAL VEGETATION AREAS ARE DEFINED AS CUT SLOPES SIEEPER THAN 31, ALI FILM SLOPES SIEEPER THAN 31, ALI FILM SLOPES SIEEPER THAN 31, ALI FILM SLOPES SIEEPER THAN 31, AND IN ALI ERAINAGE SWALES.

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2. THE DATE, TIME, NAME AND SIGNATURE OF THE PERSON CONDUCTING THE
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#### NONCOMPLIANCE REPORTING

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#### TERMINATION OF COVERAGE

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ACTIVITY MEL RETURN TO COMPLIANCE.

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ALL SEDIMENT REMOVED FROM BAYS SHALL BE DEPOSED OF IN THE MANNER CESCRIBED ON THE FLAN 
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#### GENERAL NOTES FOR UTILITY CONSTRUCTION

SERAL NOTE FOR UNITY CAUSINGUESION

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THE DAILY EXTENT OF TRENCHING SHOULD NOT EXCEED WHAT CAN BE SACKFILLED AND STABILIZED IN ONE
WORKING DAY.

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LIMIT BUYANCED CLEARING AND BURBING OPERATIONS TO A DISTANCE EQUAL TO TWO TIMES THE LENGTH OF
COMPLETED IN ONE PARK

WORK CERNS AND EQUIPMENT FROM CLEARING AND GRUBBING AND SITE RESTORATION AND STABILIZATION OPERATIONS.

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WAS ALLENDED AND COLOR FROM CLEARING AND GRUBBING AND THE TRENCH SHALL BE PULWED THROUGH A

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BY ALL STATEMENT AND SHARL BY A FALLED

ANTICIPATED ELS BMP RELATED CONSTRUCTION WASTES AND DISPOSAL PROCEDURES

TRASH AND LITTER SHALL BE REMOVED FROM EROSION AND SEDIMENTATION CONTROL BMPS AND DISPOSED OF IN APPROPRIATE TRASH RECEPTACLE. CONCRETE WASHWATER CONCRETE WASHWATER SHALL BE DISPOSED OF IN THE LOCATION SHOWN ONSITE. ONCE WASHWATER SOLIDIFIES THE HARDENED CONCRETE SHALL BID DISPOSED OF OFF-SITE IN AN APPROVED MANNER.

NOTE: ANY APPLICABLE MATERIAL SHALL BE RECYCLED IN ACCORDANCE TO THE APPROPRIATE REGULATIONS.

#### SEQUENCE OF CONSTRUCTION,


TRASH & LITTER

SEQUENCE OF CONSTRUCTIONS

1. AT LEAST DAYS BEFORE ANY EARTH DISTURBANCE ACTIVITIES, THE OPERATOR SHALL INVITE ALL
CONTRACTIONS INVOLVED BY HOSE ACTIVITIES, THE LARDOWNER, ALL APPROPRIATE AMBRIDGEAL OFFICIALS, THE
BOSION AND SERVING COMMENT. AND THE SHARP AND THE DELAWAGE COUNTRY CONSERVATION DISTIRCTTO AN
CONTRACTOR SHALL CALL HE FA ONE CALL LYSTEM FOR BRIDE DUTH'S LOCALIDED, MAY CALL
CONTRACTOR SHALL CALL HE FA ONE CALL LYSTEM FOR BRIDE DUTH'S LOCALIDED, MAY CALL
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CONTRACTION SHALL CALL HE FA ONE CALL LYSTEM FOR SHARP SHAPE SHALL SHALL SHAP SHAPE S


24. AFRE SITS STABULZATION AND BUILDING CONSTRUCTION SITE TRAFFIC S COMPLETE. APPLY WHARRING COURSE ASPLAY WAS COUNTY COURSE ASPLAY WAS COUNTY COURSE ASPLAY WAS COUNTY CO

\*DÉNOTES A CRITICAL STAGE WHEN A LICENSED PROFESSIONAL IS TO BE PRESENT ON-SITÉ

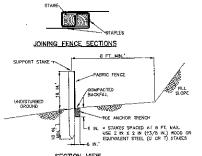


FABRIC SIYALL YAVE THE MINIMUM PROPERTIES AS SHOWN IN TABLE 4.3 OF THE PA DEP EROSION CONTROL MANUAL. FABRIC WIDTH SHALL BE 30 IN, MINIMUM, STAKES SHALL BE HARDWOOD OR FOUNTALENT STEEL (U. OR T.) STAKES. SILT FENCE SHALL BE PLACED AT LEVEL EXISTING GRADE, BOTH ENDS OF THE FENCE SHALL BE EXTENDED AT LEAST 8 FEET UP SLOPE AT 45 DEGREES TO THE MAIN FENCE AUGMARN). SEDIMENT SHALL BE REMOVED WHEN ACCUMULATIONS REACH HALF THE ABOVE GROUND HEIGHT OF THE FENCE. ANY SECTION OF SAT FENCE WHICH HAS BEEN UNDERMINED OR TOPPED SHALL BE IMMEDIATELY REPLACED WITH A ROCK FETER DUTLET (STANDARD CONSTRUCTION DETAIL # 4-6).

FENCE SHALL BE REMOVED AND PROPERLY DISPOSED OF WINEN BRIBLIARY AREA IS PERMANENTLY STABBLIZED. STANDARD CONSTRUCTION DETAIL #4-7 STANDARD SILT FENCE (18" HIGH)

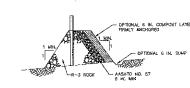


### OUTLET, CROSS-SECTION

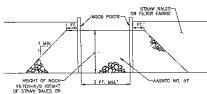

#### UP-SLOPE FACE

SEDIMENT SHALL SE REMOVED WHEN ACCUMULATIONS REACH 1/3 THE HEIGHT OF THE OUTLET. STANDARD CONSTRUCTION DETAIL #4-6
ROCK FILTER OUTLET NOT TO SCALE

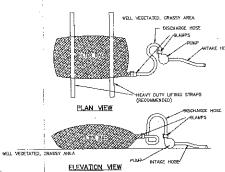

LOW VOLUME PILITE HAOS SHALL BE MADE ITROM HON-MOVEN GEOTEXTILE MATERIAL'S SEAN WITH HERS STRENGEN, DOUBLE STITCHED "I" TOPE SEAKS, THIT SHALL BE CAPABLE OF TRAMPRIO PARTISES LAGGE POLLUMNOS STANDARDS." HALLE FILITE RANG SHALL BE MADE FROM WORTH GEOTETICES THAT MEET THE FOLLUMNOS STANDARDS."

FOLLOWING STANDARDS:

PROFERTY TEST METHOD MANAGEM STANDARD

AVS. WIDE WIDTH STREEDTH ASTN D-4894. 60 LE/NI

GRAIN TENRISE ASTN D-4832. 205 LB

PUNCTURE ASTN D-4832. 105 LB

RUKLIN SURRYT. ASTN D-4835.

UV RESISTANCE ASTN D-4355.

ASTN D-4355.

VOR. STANDARD ASTN D-4355.

OS. SECTION D-4355.

ASTN D-4751.


ASTN D-4751.

SO SECTION D-4751.

BAGS SHALL BE LOCATED IN WELL-MEGETATED (GRASSY) AREA, AND DISCHARGE ONTO STABLE, EROSKIN BE RESISTANT AREAS, WHERE THIS IS NOT POSSBUE, A GEOTETRIC UNDERLAMBLYT AND FLOW FATH SHALL OF PROVIDED, AREA GLAVE STALLED ON TITLER STIME TO MERCASE DECLAMBLY AND FLOW FATH SHALL MOT A PLACED ON SLOPES GREATER THAN 5% FOR SLOPES EXCEEDING 5% CLEAR GROCY ON OTHER MOTHER CONTROL AND NON-OULDING MITTAIN LAWS THE PLACED UNDER THE 38 OF TO FEDURE SLOPE STEPPINGS.

NO DOWNSLOPE SEDIMENT BARRIER IS REQUIRED FOR MOST INSTALLATIONS. COMPOST SERM OR COMPOST TILTER SOCK SHALL BE INSTALLED BELOW BASS LOCATED IN HO OR ZV WATERSHOS, WITHIN 50 FEET OF ANY RECEINING SURFACE WATER OR WHERE CRASSY AREA IS NOT AVAILABLE. THE PUMP DISCHARGE HOSE SHALL BE INSERTED INTO THE BAGS IN THE MANNER SPECIFIED BY THE MANNER AND SECURELY CLAMPED. A PIECE OF PVC PIPE IS RECOMMENDED FOR THIS PURPOSE. THE PUMPING RATE SHALL BE NO DREATER THAN 750 GPM OR 1/2 THE MAXMUM SPECIFIED BY THE MAXMERACTURER, WHICHEVER IS LESS, PUMP INTAKES SHALL BE FLOATING AND SCREENED.

FILTER BAGS SHALL BE INSPECTED DAILY, IF ANY PROBLEM IS DEYECTED, PUMPING SHALL GEASE IMMEDIASELY AND NOT RESUME UNTIL THE PROBLEM IS CORRECTED. STANDARD CONSTRUCTION DETAIL #3-16
PUMPED WATER FILTER BAG NOT TO SCALE

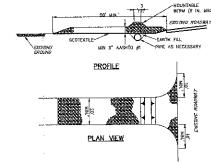

. MOUNTABLE SERM USED TO PROVIDE PROPER COVER FOR PIPE NOTES:

REMOVE TOPSOIL PRIOR TO INSTALLATION OF ROCK CONSTRUCTION ENTRANCE. EXTEND ROCK OVER FULL WIDTH OF ENTRANCE. RUNDER SHALL BE DIVERTED FROM ROADWAY TO A SUITABLE SECRMENT REMOVAL BIAP PRIOR TO ENTERING ROCK CONSTRUCTION ENTRANCE.

MANTEHANCE: ROCK CONSTRUCTION ENTRANCE THICKNESS SHALL BE CONSTANTLY MAINTAINED TO THE SPECIFIED DIMENSIONS BY ADDING ROCK, A STOCKHE SHALL BE MAINTAINED ON SITE FOR THE PROPERTY OF THE SHALL BE MAINTAINED ON SITE FOR THE PROPERTY OF THE SHALL BE MAINTAINED AND SITE FOR THE SHALL BE MAINTAINED AND SHALL BE MAINTAINED ON THE PROPERTY OF THE PROPERTY

STANDARD CONSTRUCTION DETAIL #3-1
ROCK CONSTRUCTION ENTRANCE

#### Villanova University

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phone: 212-967-5100 fax: 212-967-5588

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MEPRIFP ENGINEER Bala Consulting Engineers 443 South Gulph Road phone: 610-649-8000 fax; 910-649-8475

LANDSCAPE ARCHITECT Sikora Wells Appel 8 Kings Highway West, Sulte A Haddonfield, NI p8033 phone: 856-433-6381

ACOUSTIC CONSULTAN Acentech Inc. 8 Interplex Drive, Suite 218 Trevose, PA 19053 phone: 215-245-8244

fac: 215-245-1796

LEVATOR CONSULTANT Zipf Associates Inc. Bala Cynwyd, PA 19004 nhone: 610-667-1717




PRELIM. LAND DEVELOPMENT SUBMISSION


December 5, 2014 Title Fracian & Sedimentation Control Detail Sheet


Scale N.T.S. Drawn By DCH

C5.3

THIS PLAN FOR EROSION AND SEDIMENTATION CONTROL PURPOSES ONLY. Contractor to verify all dimensions in field and inform Analysis of any discrepancies before starting work.

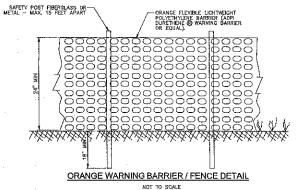

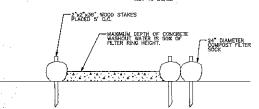


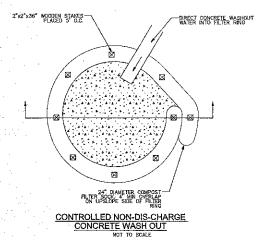

ALL CONCRETE WASHOUT FACILITIES SHOULD BE INSPECTED DAILY.


DAMAGED OR LEAKING WASHOUTS SHOULD BE DEACTIVATED AND

BEPARED OR PEPILAPET MAJEOUS TO BE DEACTIVATED AND

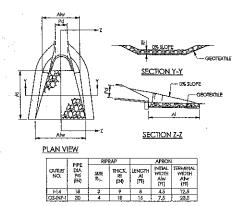

ALL APRONS SHALL BE CONSTRUCTED TO THE DIMENSIONS SHOWN, TERMINAL WIDTHS SHALL BE ADJUSTED AS NECESSARY TO MATCH RECEIVING CHANNELS. ALL APRONS SHALL BE INSPECTED AT LEAST WEEKLY AND AFTER EACH RUNOFF EVENT. DISPLACED RUPRAP WITHIN THE APRON SHALL BE REPLACED IMMEDIATELY.

STANDARD CONSTRUCTION DETAIL #9-1 RIPRAP APRON AT PIPE OUTLET WITH FLARED END SECTION OR ENDWALL

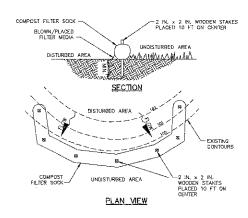

NOTISE

SOCK FABRIC SHALL MEET STANDARDS OF TABLE 4.1 OF THE PA DEP EROSION CONTROL

MANUAL. COMPOST SHALL MEET THE STANDARDS OF TABLE 4.2 OF THE PA DEP EROSION

ANNUAL. COMPOST SHALL MEET THE STANDARDS OF TABLE 4.2 OF THE PA DEP EROSION

COMPOST FILTER SOCK SHALL BE PLACED AT EXISTING LEVEL GRADE. BOTH KINDS OF THE

SARRIER SHALL BE EXTENDED AT LEAST IS REET UP SLOPE AT 4.3 DEGREES TO THE MAN

BARRIER ALICONLEAT. MADMIMM SLOPE LONGTH ABOVE ANY BARRIER SHALL NOT EXCELD THAT

SPECIFIED FOR THE SIZE OF THE SOCK AND THE SLOPE OF ITS TREDITARY AREA.

TRAFTIC SHALL NOTI BE PREMITTED TO POOSS COMPOST FILTER SOCKS.

REPLACED WITHOUT SHARE AND OPPOSED IN THE MANNER OSCINEDE LISEWHERE IN THE PLAN.

COMPOST FILTER SOCKS SHALL BE REPLACED OF THE MADMINE ASSENTED LISEWINGE IN THE PLAN.

COMPOST FILTER SOCKS SHALL BE REPLACED OF THE MADMINE ASSENTED THE SECRETARY OF THE PLAN.

COMPOST FILTER SOCKS SHALL BE REPLACED AFTER 6 MONTHS.

PHOTOCEGRADABLE SOCKS SHALL STANDARD TO THE SACK SHALL BE REPLACED.

HOUSEGRADABLE COMPOST FILTER SOCKS SHALL BE REPLACED AFTER 6 MONTHS.

HOUSEGRADABLE SOCKS SHALL STANDARD TO THE SOCK SHALL BE REVOYED.

THE SOCK MAY BE LET IN PLACE AND VECETIATED OR REMOVED. IN HE LATTER CASE, THE

MEEST SHALL BE COUT POOR MON THE THE SOCK SHOUL SET ON THE THE TABLE.

THE SOCK MAY BE LET IN PLACE AND VECETIATED OR REMOVED. IN HE LATTER CASE, THE

MEEST SHALL BE COUT POOR MON THE MUNICE SPECAL OR SOLL SUPPLEMENT.


ING SOCK MAI SC LETT IN FEACE AND VEGETATED ON REMOVED. IN THE LATTER CASE,
MESH SHALL BE GUT OPEN AND THE MULCH SPREAD AS A SOIL SUPPLEMENT.
WHERE SOCKS ARE PLACED ON PAVED SURFACES, CONCRETE BLOCKS
SHOULD BE USED IMMEDIATELY DOWNSLOPE OF THE SOCKS ( AT THE SAME INTERVALS
RECOMMENDED FOR THE STAKES) TO HELP HOLD THE SOCK IN PLACE.
·
TABLE 4.2 FROM PA E&S MANUAL, MARCH 2012
IABLE 4.2 FROM FA Each MANUAL, MARCH 2012

MOISTURE CONTENT

ORGANIC MATTER CONTENT 25%-100% (DRY WEIGHT BASIS)
ORGANIC PORTION FIBROUS AND ELDNGATED

			MANUAL, MARCH MINIMUM SPECIFICA				
MATERIAL TYPE	3 MJL HDPE	5 MIL HOPE	5 MIL HOPE	MULT1-FILAMENT	HEAVY DUTY		
		1		POLYPROPYLENE	POLYPROPYLEN		
		<u> </u>	J	(MEPP1	LHOMEPP)		
MATERIAL	PHDTO-	PHOTO-	PHOTO-	РИДТО-	PH91'0-		
CHARACTERISTICS :	DEGRADABLE	DEGRADABLE	DEGRADABLE	DEGRADABLE	DEGRADABLE		
1		12	12"	12	12"		
SOCK	12″	18"	1B"	18"	16"		
DIAMETERS	18"	24"	24"	24" 32"	24"		
LICANI ADENTAIA	3/8"	32"	32" 3/8"	3/8"	32"		
MESH OPENING TENSILE	378"	378"	1 3/8	3/8"	1/8"		
STRENGTH		26 PSI	26 PS1	44 PS1	202 PS1		
IN TRAVIOLET		20 731	20 F31	44 F31			
STABILITY %							
OR1G1NAL	23% AT	23% AT		100% AT	100% AT		
STRENGTH	1000 MR	1000 HB		1000 HR	1000 HB		
(ASTM G-155)		1					
MINIMUM							
FUNCTIONAL	6 MONTHS	9 MONTHS	6 MONTHS	1 YEAR	2 YEARS		
LONGEVITY			1		<u> </u>		
		TWO-PL	SYSTEMS				
				HOPE BIAXIAL			
TIME OF	STATINGENT NETS	rica		CONT INDOUSLY			
INNER CU	NIAINMENT NETT	ING	* // *	FUSION-WELDED JUNCTURES 3/4" X 3/4" MAX, APERTURE SIZE			
				OSITE POLYPROPY			
				LAYER AND NON-			
OUTER 6	ELL TRATION MES	F		CALLY FUSED VIA			
OUTER .				16" MAX. APERAT			
SHOK FARRICS OF	Measen de Bur	AP MAY BE DISEL		ASTING & MONTHS			

STANDARD CONSTRUCTION DETAIL #4-1 COMPOST FILTER SOCK NOT TO SCALE

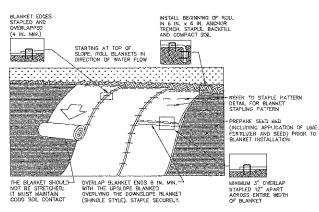


NOTES:


SEED AND SOIL AMENDMENTS SHALL BE APPLIED ACCORDING TO THE RATES IN THE PLAN DRAWINGS PRIOR TO INSTALLING THE FLANKET.

PROVIDE ANCHOR TRENCH AT TOE OF SLOPE IN SIMILAR FASHION AS AT 'TOP OF SLOPE SLOPE SURFACE SHALL, BE FREE OF ROCKS, CLODS, STICKS, AND GRASS.

STANDARD CONSTRUCTION DETAIL #11-1 EROSION CONTROL BLANKET INSTALLATION NOT TO SCALE

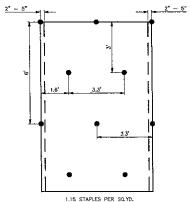


EROSION CONTROL BLANKET STAPLE PATTERN NOT TO SCALE

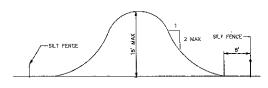

## TYPICAL SOIL STOCKPILE CROSS SECTION NOT TO SCALE

NOTES: SILT FENCE MUST COMPLETELY ENGIRCLE STOCKPILE

TOPSOL SHALL NOT SE REMOVED FROM THE DEVOLUPRENT SITE OR USER AS FILE TOPSON SHALL BE REMOVED FROM THE AREAS FOR STANDARD TO MINIMIZE RESIDENCE OF THE AREAS FOR STANDARD TO MINIMIZE RESIDENCE TO THE STANDARD TO MINIMIZE RESIDENCE TO THE STORE OF THE STANDARD TO THE STANDARD TO THE STANDARD TO THE STANDARD THE STANDA

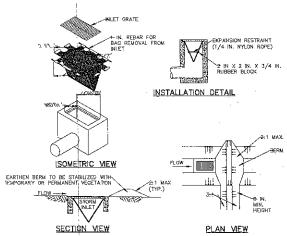

MAXIMUM DRAINAGE AREA = 1/2 ACRE.

INLET PROTECTION SHALL NOT BE REQUIRED FOR INLET TRIBUTARY TO SEDIMENT BASIN OR TRAP. BERMS SHALL BE REQUIRED FOR ALL INSTALLATIONS.

ROLLED EARTHEN 35KM IN ROADWAY SHALL BE MAINTAINED UNTIL ROADWAY IS STONED. ROAD SUBBASE BERM ON ROADWAY SHALL BE MAINTAINED UNTIL ROADWAY IS PAVED. EARTHEN BERN IN CHANNEL SHALL BE MAINTAINED UNTIL PERMANENT STABILIZATION IS COMPLETED OR REMAIN PERMANENTLY.


AT A MINIMUM, THE FABRIC SHALL HAVE A MINIMUM GRAB TENSILE STRENGTH OF 120 LBS, A MINIMUM BURST STRENGTH OF 200 PS, AND A MINIMUM TRAPEZODAL TEAR STRENGTH OF 50 LBS. FUTER BAGS SHALL BE CAPABLE OF TRAPPING ALL PARTICLES NOT PASSING A NO. 40 SIEVE.

INLET PRIER BAGS SHALL BE INSPECTED ON A WEEKLY BASIS AND AFTER EACH RUNGIFF EVENT BAGS SHALL BE EMPIRED AND RINSED OR REPLACED WHEN HALF FULL OR WHEN FLOW CAPACITY HAS BEEN REDUCED SO AS TO CAUSE FLOODING OR BYPASSHOO OF THE INLET ONALAGED OR CLOGGED BAGS SHALL BE REPLACED. A SUPPLY SHALL BE MAINTAINED ON SITE FOR REPLACEMENT OF BAGS, ALL NEEDE REPARDS SHALL BE INITIATED MINISTERM WINDIGHTLY AFTER THE INSPECTION, DISPOSE ACCUMULATED SEDMENT AS WELL AS ALL USED BAGS ACCORDING TO THE FLAN MOTES,

DO NOT USE ON MAJOR PAVED ROADWAYS WHERE PONDING MAY CAUSE TRAFFIC HAZARDS.

## STANDARD CONSTRUCTION DETAIL #4-16 FILTER BAG INLET PROTECTION - TYPE M INLET

NOT TO SCALE

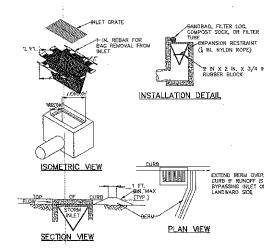

MAXIMUM DRAINAGE AREA = 1/2 ACRE.

INLET PROTECTION SHALL NOT BE REQUIRED FOR INLET TRIBUTARY TO SEDIMENT BASIN OR TRAP, BERMS SHALL BE REQUIRED FOR ALL INSTALLATIONS.

ROLLED EARTHEN BERN SHALL BE MAINTAINED UNTIL ROADWAY IS STONED. ROAD SUBBLASE BERN SHALL BE MAINTAINED UNTIL ROADWAY IS STONED. ROAD SUBBLASE BERN SHALL BE MAINTAINED UNTIL ROADWAY IS PAYED. SXX INCH MINIMAUM REGOT ASPHALT BEEN SHALL BE MAINTAINED UNTIL ROADWAY SUBPLASE RESPONSE TIMEL OF A STANDARD AT A MAINMAIN BURST STRENGTH OF 120 LBS, A MINIMAIN BURST STRENGTH OF 200 PSI, AND A MINIMAIN BARAFEZOURAL TEAR STRENGTH OF DLES, FILTER GAGS SHALL BE DAPRIES OF TRAPPING ALL PARTICLES NOT PASSING A NO. 40 SIEVE.

ACCUMULATED SEDIMENT SHALL BE REMOVED WHEN IT REACHES 1/2 THE ABOVE GROUND HEIGHT OF THE BARRIER AND GISPOSED IN THE MANNER DESCRIBED LISEWHERE IN THE PLAN. COMPOST FILTER SOCKS SHALL BE INSPECTED WEEKLY AND AFTER EACH ROMOFF EVENT. DAMAGED SOCKS SHALL BE REFAIRED ACCORDING TO MANUFACTURERYS SPECIFICATIONS OR ROPLACED WITHIN 24 HOURS OF INSPECTIONS.

DO NOT USE ON MAJOR PAVED ROADWAYS WHERE PONDING MAY CAUSE TRAFFIC HAZARDS.

STANDARD CONSTRUCTION DETAIL #4-15
FILTER BAG INLET PROTECTION - TYPE C INLET

#### Villanova University

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fax: 510-265-4299 STRUCTURAL ENGINEER scintush Engineering One East Uwchian Avenue, Ste. 40:

phone: 484-475-2180 fac: 484-475-2181 www.macintosheng.com

> Bala Consulting Engineers, Inc 443 South Gulph Road phone: 610-649-8000 fax: 910-649-8475 LANDSCAPE ARCHITECT

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Zipf Associates Inc. 5 Bala Avenue, Suite 201 Bala Cynwyd, PA 19004 phone: 610-667-1717 fac 610-667-0216




PRELIM. LAND DEVELOPMENT SUBMISSION

Title Erosion & Sedimentation Control Detail Sheet N.T.S.

Drawn By DCH


C5.4

THIS PLAN FOR EROSION AND SEDIMENTATION CONTROL PURPOSES ONLY. Contractor to weify all dismensions in field and inform Architect of Arity discrepancies before starting work.

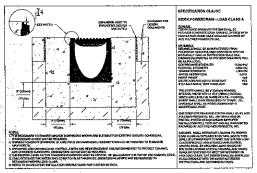


## TRENCH DRAIN WITH GRATED COVER

N.T.S. DRAIN SHALL HAVE A TRASH BASKET AND CATCH BASIN MISTALLED DISCHARGING INTO STORM PRIE NETWORK TRASH BASKET AND CATCH

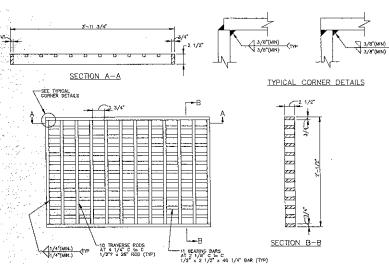



BICYCLE SAFE GRATE




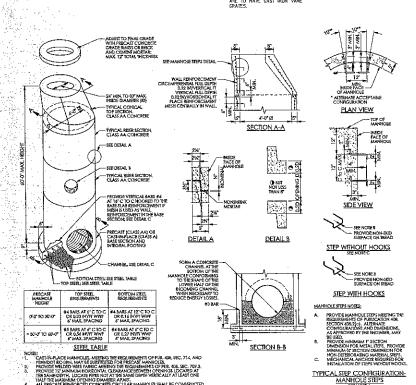

STANDARD PRECAST MANHOLE

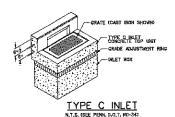

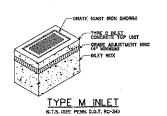


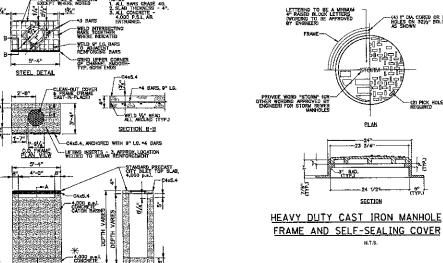

NOTE: STEEL REINFORCEMENT OF THE BASE AND RISER SECTIONS FOR THE CITY INLET SHALL BE BASED ON THE REGULTEMENTS OF FOR A PADOT STANDARD INLET BOX — REINFORCEMENT BAR SCHEDULES AS SHOWN IN RC-46M OF PADOT PUBLICATION 72M AS LAST REVISED. \*\*CONCRETE COMPRESSIVE STRENGTH TO CONFORM WITH MATERIAL NOTES AS SHOWN ON SHEET 1 OF RC-45M OF PADOT PUBLICATION 72M AS LAST REVISED.


(4') CITY INLET DETAIL

FRONT VIEW

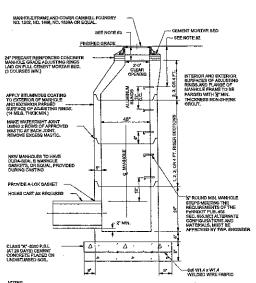


.C., DE PAVED SURFACE SHALL BE FEATHERED-OUT A MINIMUM OF 5 FEET EDGE OF THE STEEL MANHOLE AD AUSTMENT RING.

SANITARY MANHOLE DETAIL

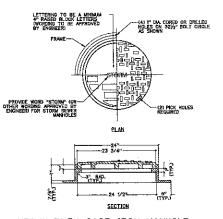


FRAME AND SELF-SEALING COVER

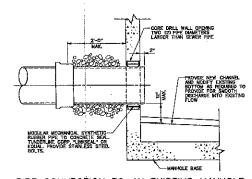


MPE UTILITY TRENCH

PIPE CONNECTION TO AN EXISTING MANHOLE

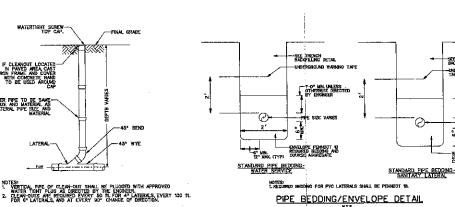

CLEAN-OUT DETAIL

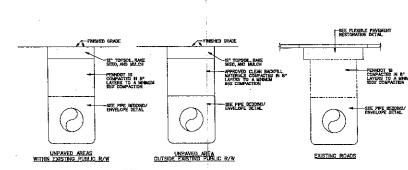

1. TRENCH COMPACTION TO BE TESTED, AT THE CONTRACTOR'S EXPENSE, N ACCORDANCE WITH PERMOOT PUB 408.

2. CLEAN FILL MUST BE APPROVED BY THE CITY'S ENGINEER PRIOR TO PLACEMENT IN THE TRENCH.

 AREAS AROUND MARHOLES AND OTHER APPURTMANCES SHALL BE HAND COMPACTED AS DIRECTED BY THE CITY'S ENGINEER. TRENCH BACKFILL

Villanova University

Lancaster Avenue Housing Lancaster and Ithan Avenues Villanova PA 1908s

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fax; 910-649-8475 LANDSCAPE ARCHITECT Sikora Wells Appel & Kings Highway West, Suite phone: 856-433-6381

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OTHERWISE DIRECT

-REQUIRED BEDOING AND ENVELOPE PA DOT 18 COURSE AGGREGATE

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fax: 215-245-1796


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PRELIM, LAND DEVELOPMENT SUBMISSION

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> 19 of 30 Contractor to verify all dimensions in field and informs Archibect of any discrepancies before starting work.

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DESIGN ENGINEER RESPONSIBLE FOR ENSURING THE REQUIRED BEARING CAPACITY OF SUBGRADE SOILS

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GRAPHIC SCALE

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Revision
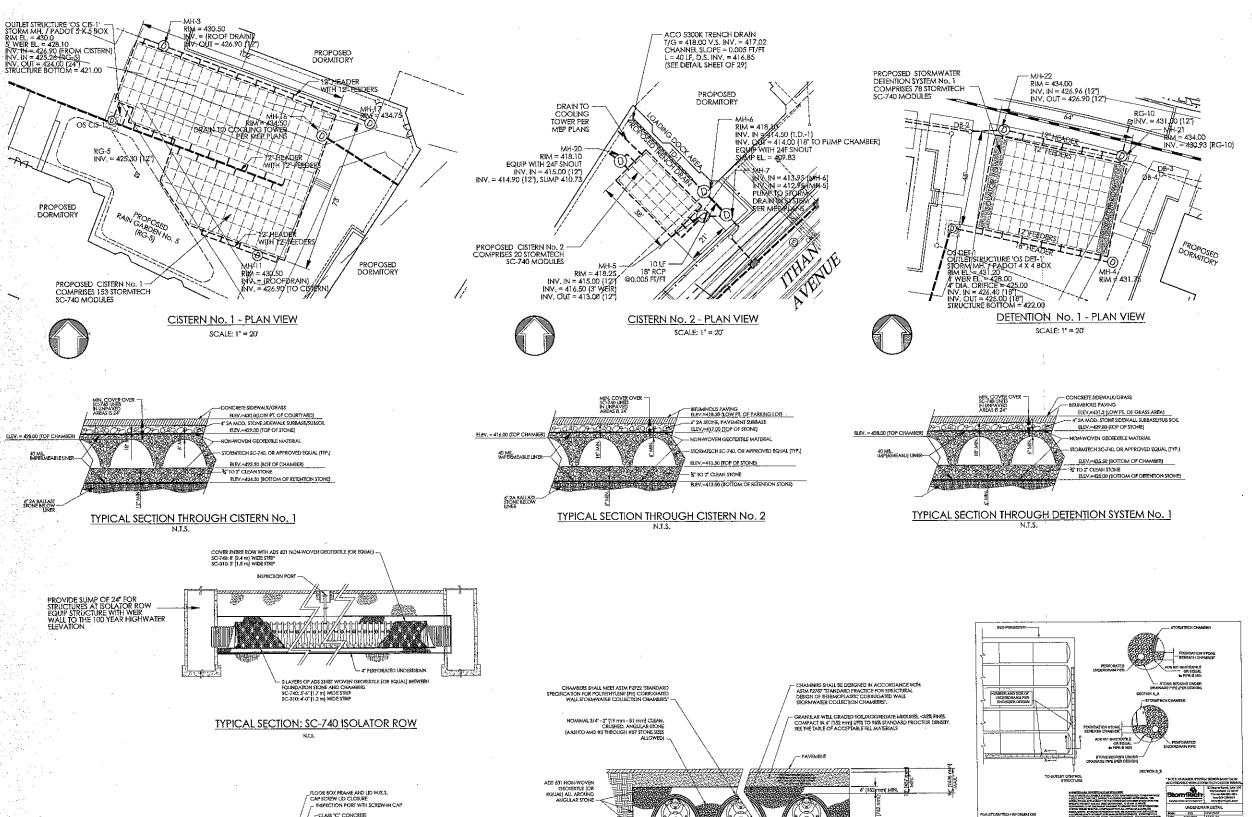
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Sheet No. 20 of 30


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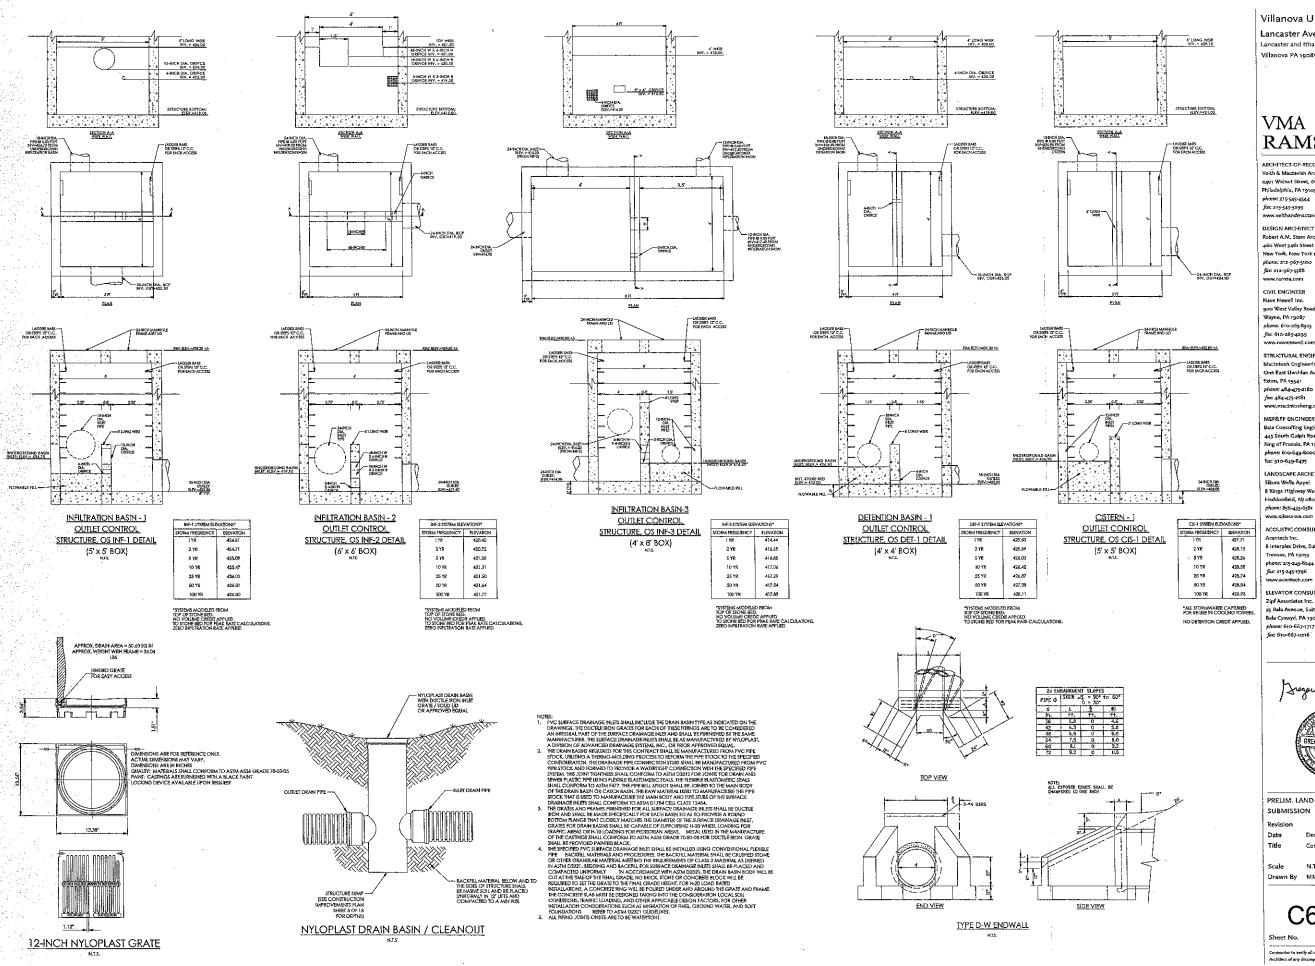
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fax: 215-245-1796 ELEVATOR CONSULTANT

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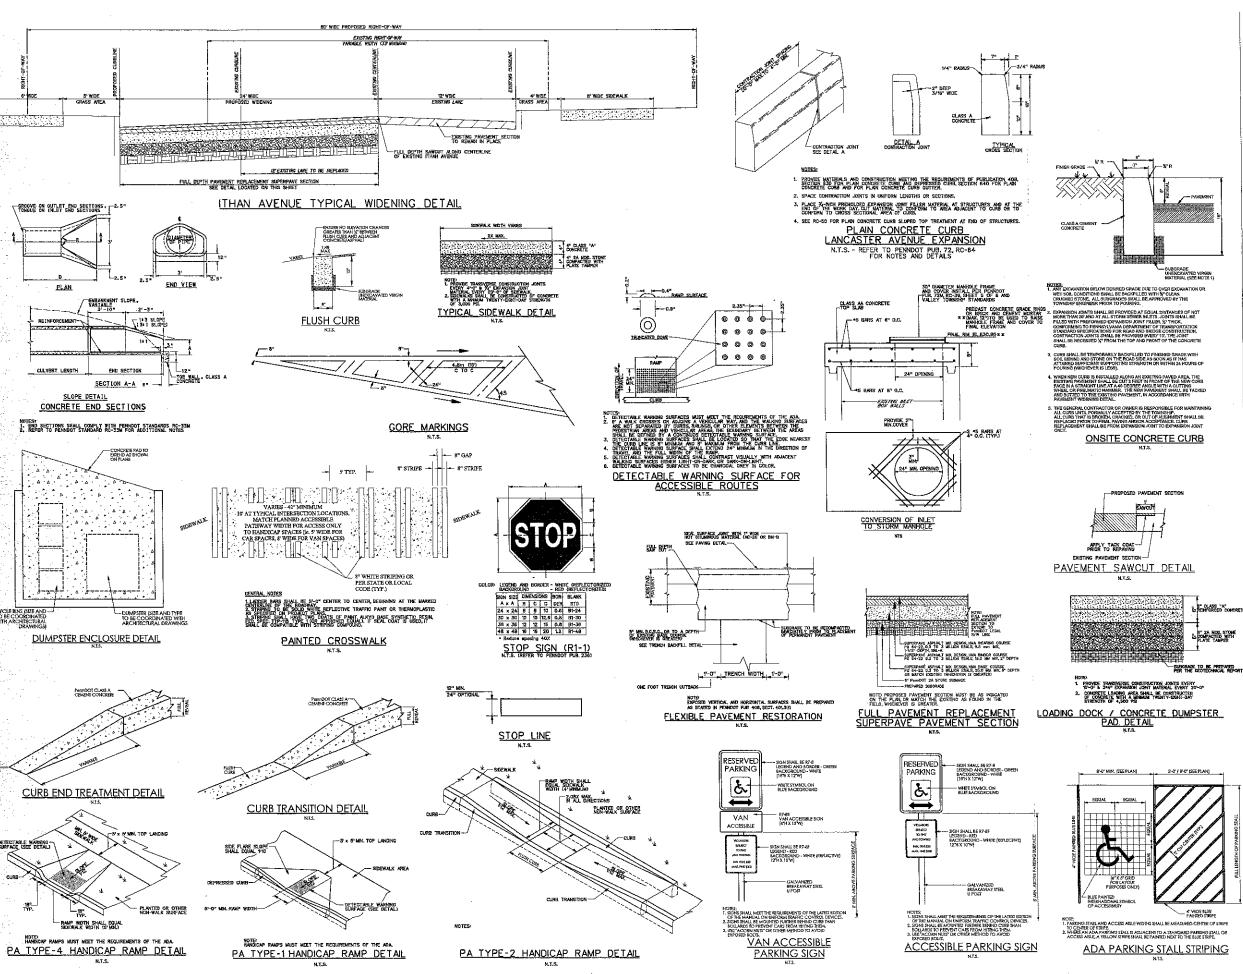
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Acentech Inc.

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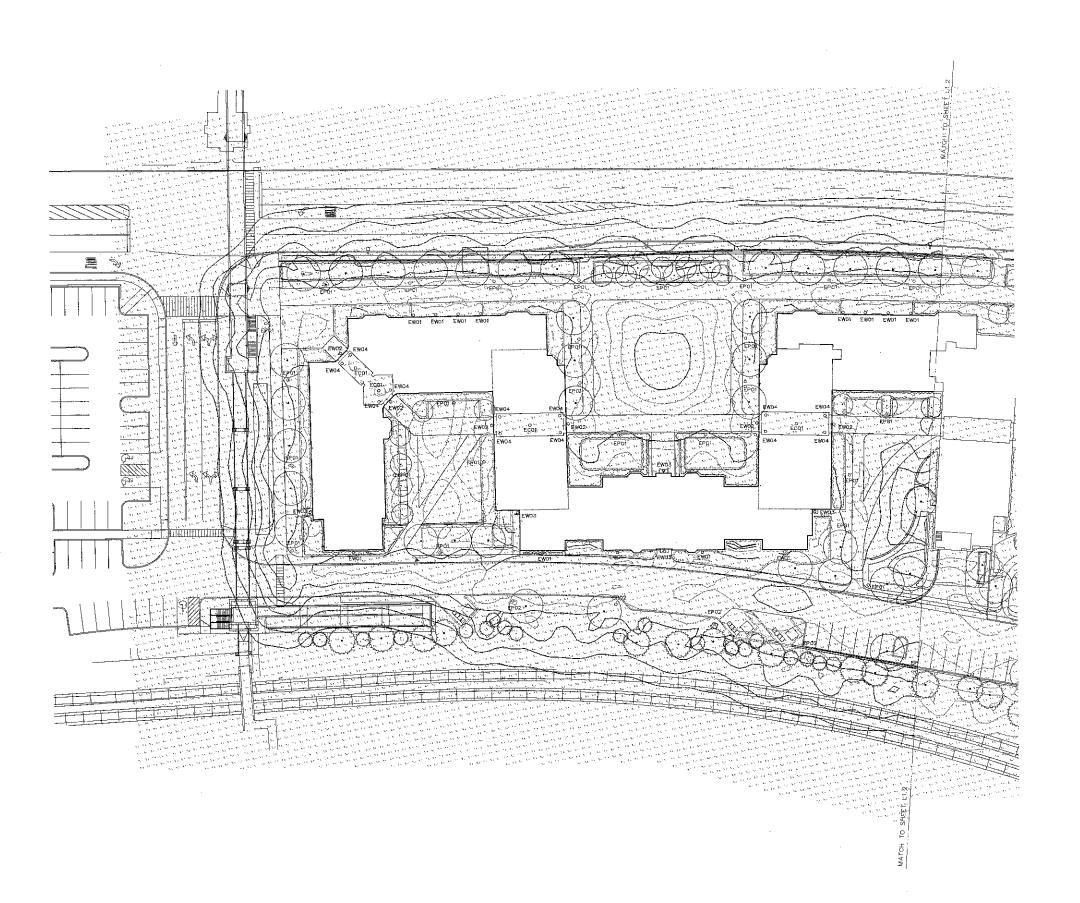
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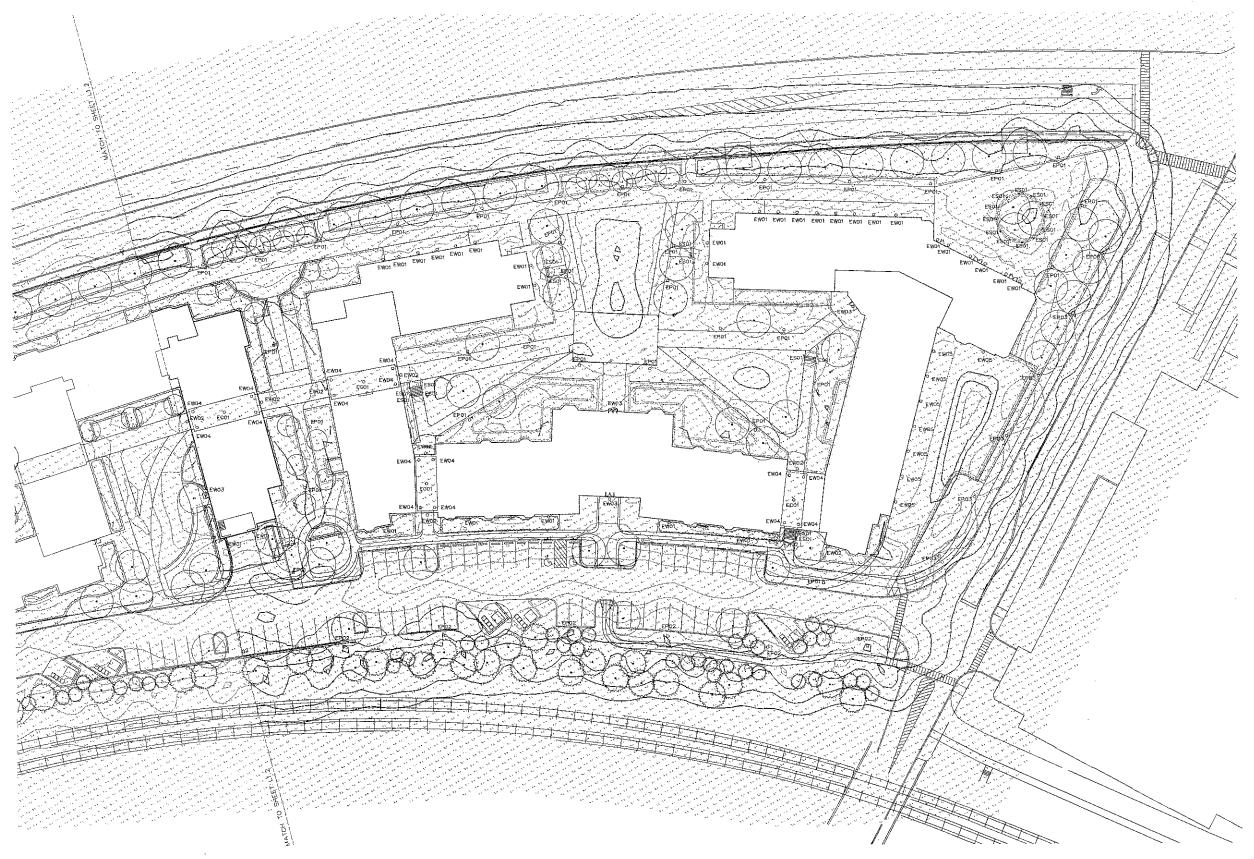
Site Lighting Plan

Scale Drawn By JL

Sheet No.
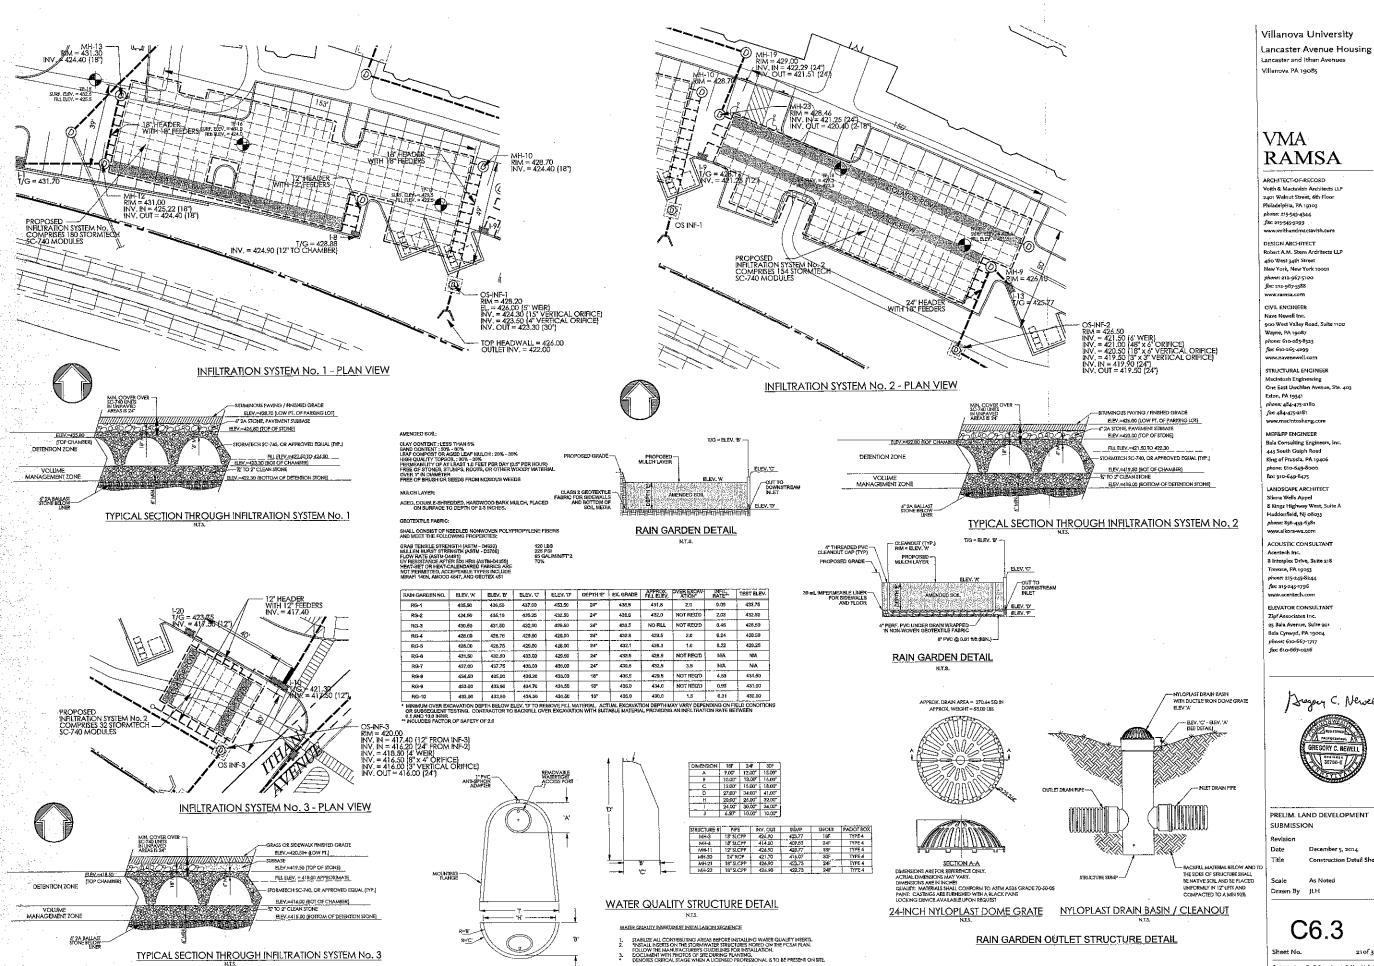
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Date December 5, 2014
Title Site Lighting Plan

Scale 1" = 30'-0"


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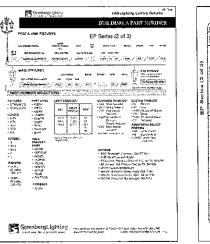
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Fixture Type EC01



Fixture Types EP01, EP02 & EP03



D342 LED LUMINAIRE
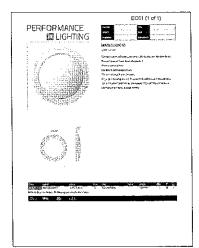
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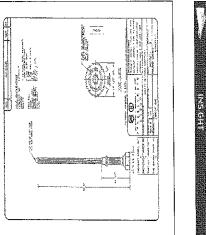
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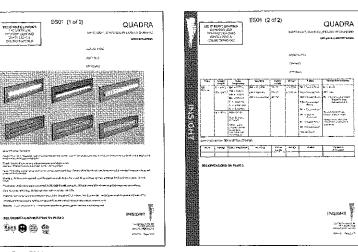
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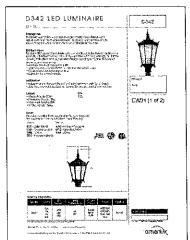
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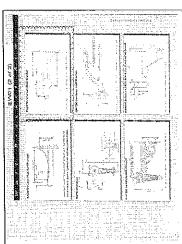



Fixture Type ES01





Fixture Type EW01



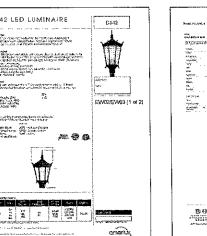


Fixture Types EW02 & EW03


GM116 EW04.Alt.(1 of 1)

WALL FIXTURE


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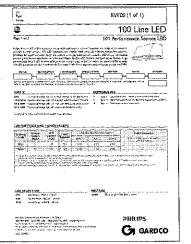
EW02/EW03 (2 of 2)

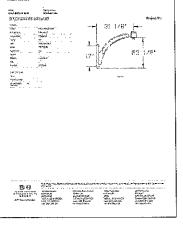

Fixture Type EW04

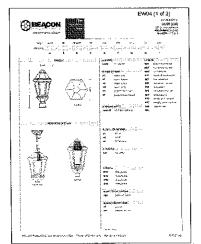

Fixture Type EW04 Alt.

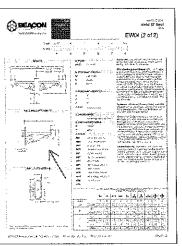

Fixture Type EW05

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		. – .							
YPE;		AMBIFACTURES	CATALIGE # 1	YAL MEE	LAMP TYPE	JAA 115	VOLTS	APENTURE	DEPTH
	DECORATIVE FLUORESCENT FIXTURE				1.	1			
	WITH (2) INTEGRAL ELECTRONIC BALLASTS, (2) LAMPS, DIE CAST ALUM.					1	1		
	HOUSING, HEAVY DUTY PRESSED				22W TS CIRCLE	i	í		Ē
- 1	GLASS DIFFUSER AND TEXTURED	Prisma			± 40k√ 15				3.24"
		LIGHTING	074990	PHILIPS	CIRCLE 1	62	120	20.23" Diam.	Ext.
	MOUNTED LANTERN FIXTURE WITH								1
	CAST ALLIM, HOUSING, CLEAR ACRYLIC		i		1	Ì		İ	
	LENSES, INTEGRAL DIMMING DRIVER, BRODE MOUNTED OUT OFF OPTIC WATH								
- 3		STERNBERG	MSE05ALED/3/OTHER/44J			Ì		1	
P01		LIGHTING	R-45-T3/MDL/CA/BK(*	INCLUDED	<u> </u>	57	120	15'W	26°h
	MOUNTED LANTERN FIXTURE WITH	,,,,,,		,,,,,,,,,,,,,,,,,,,,,,,,,,,,,,,,,,,,,,,				1	
	CAST ALUM, HOUSING, CLEAR ACRYLIC				1				ł
	LENSES, INTEGRAL DIMMING DRIVER.					-	1		ĺ
	RUDE MOUNTED OUT OFF OPTIC WITH	STERNBERG	MSE05ALED/3/OTHER/441		1		ş	İ	į
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	MOUNTED LANTERN FIXTURE WITH								1
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	LENSES, INTEGRAL DIMMING ORIVER, ROOF MOUNTED OUT OFF OPTIC WITH								
	TYPE II DISTRIBUTION ON 12-0"	STERNBERG	M\$8054LE073/0THER/44J			1		·	1
P03		LIGHTING		INCLUDED		57	120	15°W	26"h
	LED STEP LIGHT WITH CAST				-		-		
	ALUMINUM HOUSING, CLEAR ACRYLIC							1	
	LENS, INTEGRAL DIMMABLE DRIVER,					1	1	ĺ	
	NEUTRAL WHITE OUTPUT AND EXTERNAL VISOR FOR FULL OUT OFF.	INSIGHT						11 5/8°X1	1
500	COLOR TO BE SELECTED BY	LIGHTING	QD-1240-XX-15-2-XX-VS	INCLUDED		12	277	1/4"	37/8"
	DECORATIVE LED FIXTUREWITH CAST		T	***************************************	1			1	
	ALUM. HOUSING, CLEAR ACRYLICLENS,					ĺ	į	ì	
	INTEGRAL DIMMABLE DRIVER.	AMERLUX				ł	1		1
	NEUTRAL WHITE LIGHT ROOF TOP DUTPUT FOR TYPE IN DISTRIBUTION	Lighting King	D342-CA-AVI-A3-3H- T8K/Fedute)			-		1	1
FWM	:WITH CUT OFF AND BLACK TEXTURED	LUMINAIRE	KARSW-BK (Bracket arm)	INCLUDED		57	120	15W	26"H
	DECORATIVE LED FIXTURE WITH CAST				1				1
	ALUM, HOUSING, CLEAR ACRYLICLENS,						}		l.
	INTEGRAL DIMINABLE DRIVER.	AMERILUX				1		1	
	NEUTRAL WHITE LIGHT ROOF TOP	Lighting King	D342-CA-AM-AS-3H-TBK [Fixture]						1
FWII2	OUTPUT FOR TYPE III DISTRIBUTION WITH OUT OFF AND BLACK TEXTURED	LUMINAIRE	KA57-S-I-BK (Bracket arm)	INCLUDED		57	120	15°W	25°H
- 402	DECORATIVE LED FIXTUREWITH CAST	i Lomis-Mil		1					
	ALUM, HOUSING, CLEAR ACRYLICLENS,	1	1 .	1			1		ĺ
	INTEGRAL DIMMABLE DRIVER,	AMERLUX	İ			1	į		
	NEUTRAL WHITE LIGHT ROOF TOP	LIGHTING	D342-C4-AVI-AS-3H-TBK			1	1		
Flump	OUTPUT FOR TYPE III DISTRIBUTION AVETHICUT OFF AND BLACK TOXTURED	LUMINAIRE	(Fixture) KASZ-SI-BK (Bracket arm)	INCLUDED	)	57	120	15'W	26'H
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En./ns	TEXTURED FINISH ON ALL ITEMS. *LOCATED IN PASSAGEWAYS.	LIGHTING	DIR3-BBT	INCLUDED	s)	27	1:20	10.3/4°W	H
L W 04	DECORATIVE LED FIXTURE WITH	Catalan and the state of the st	per control to the state of the		i				1
	NEUTRAL WHITE OUTPUT, CLEAR			1			-	1	
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H1 - 201 4	DIFF DISTRIBUTION AND BLACK	DABMAR	GM116 LED20 TEXT USED	1		į	ì		18
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~!L	TRAPAZOIDAL WEDGE LED	- CHARLING		114000000000000000000000000000000000000	· <del> </del>				7
	DOWNLIGHT SCONCE WITH INTEGRAL	-		1			-		
	DRIVER, TYPE III OPTICS, NEUTRAL			1		ļ			ļ
	WHITE LIGHT OUTPUT AND RAL PAINT		and mine live in 1999	1	1	1	1	16 1/4°W×	İ
	COLOR FINISH TO BE SELECTED BY	1	101L TYPE II 55 NW UNIV-	10		1		16 1/4 W 8	

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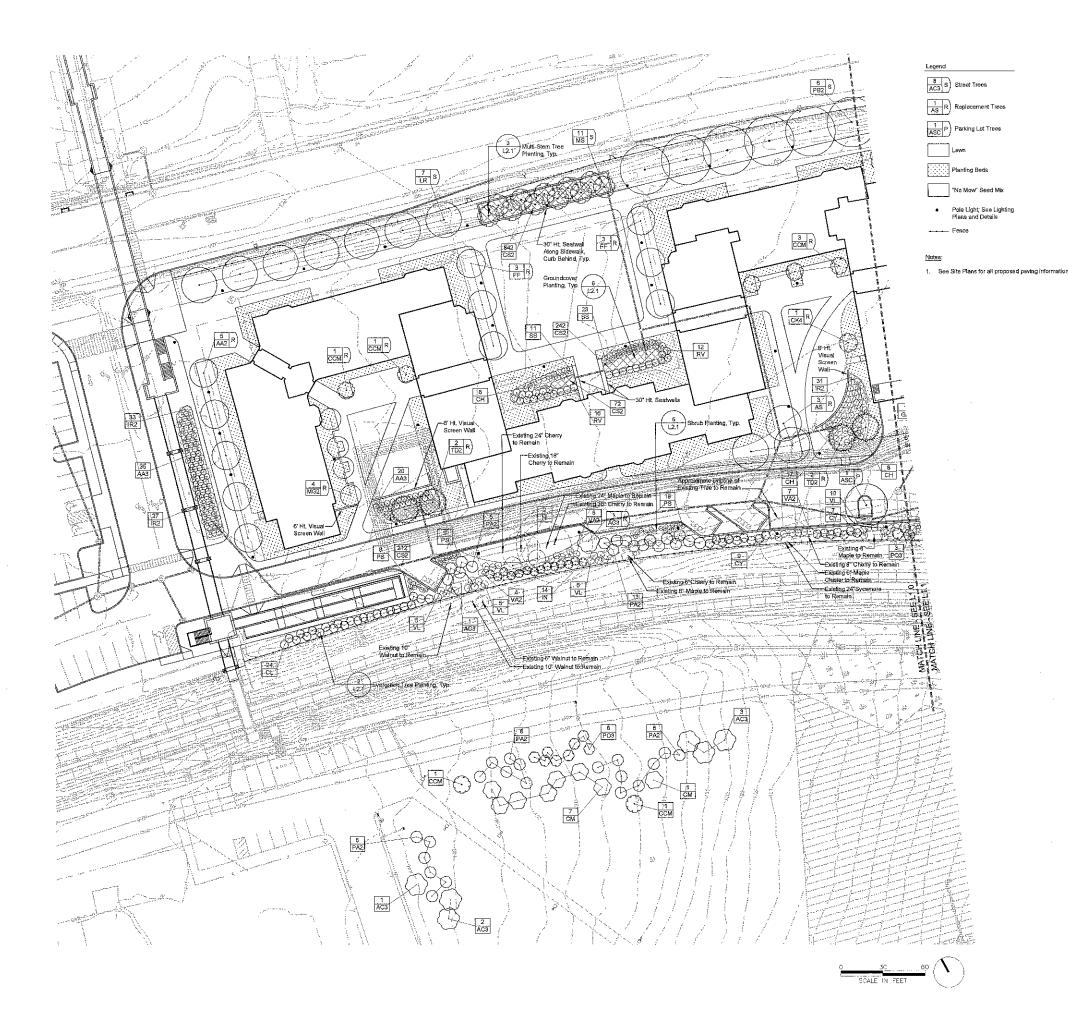
Date Site Lighting Schedule

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Sheet No. 26 of 30 Contractor to verify all dimensions in field and Inform



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PRELIM, LAND DEVELOPMENT

Revision

Date December 5, 2
Title Planting Plan


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Scale 1" = 30'-0"
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Jesepit Sikora

PRELIM, LAND DEVELOPMENT SUBMISSION

Revision

Date December 5, 2
Title Planting Plan

Scale 1"=30'-0"
Drawn By RM

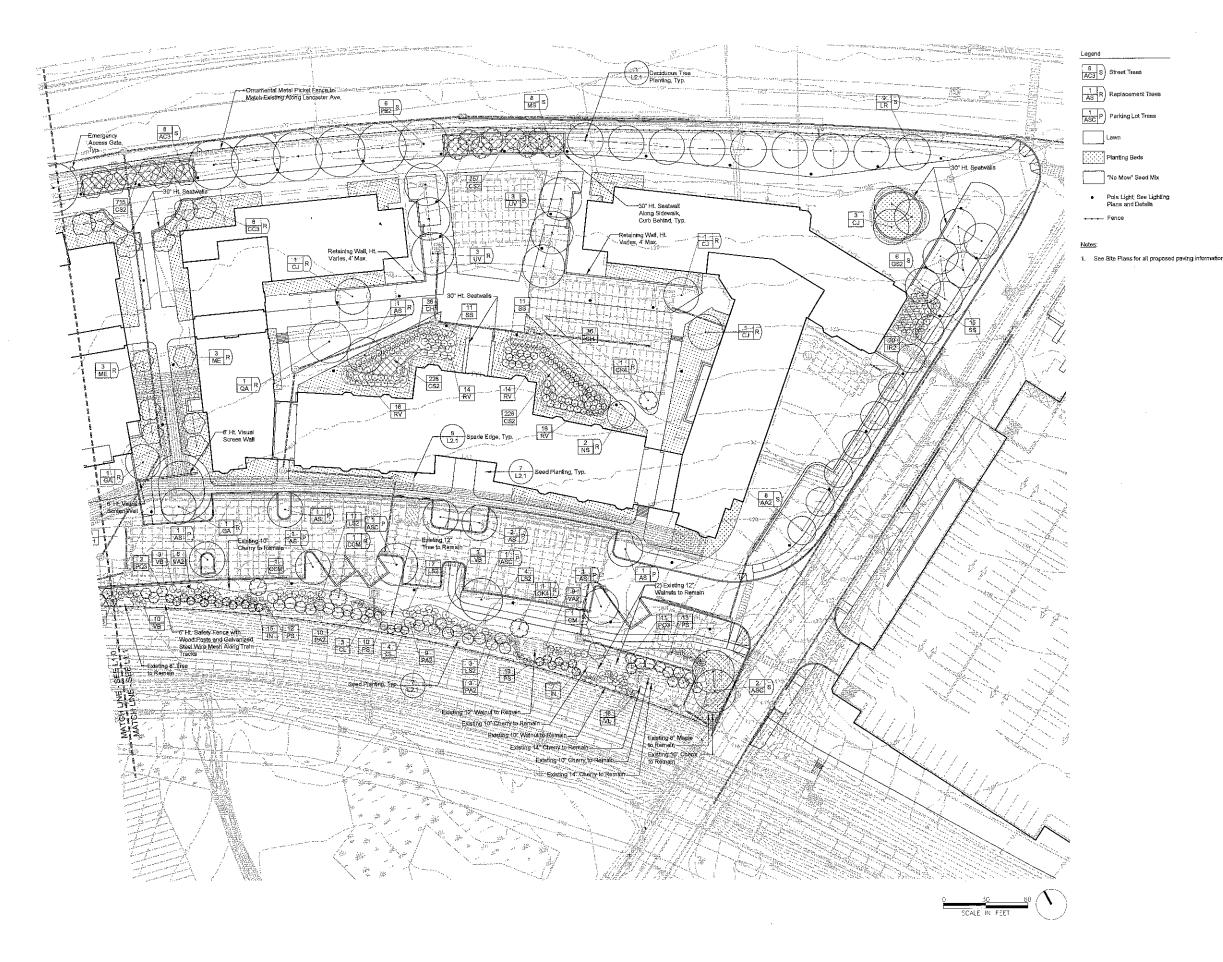L1.1

eet No. 28

Contractor to verify all dimensions in field and inform Architect of any discrepancies before starting work.

TREE REQUIREMENT TABLE		
A AND AND AND A STATE OF THE ST	REQUIRED	PROPOSED
STREET TREES		
LANCASTER AVENUE = 1,220 FT. SECTION 255-36.B INTERVALS OF NOT MORE THAN 30 FEET	1,220'/30' = 41 TREES	55 TREES
SOUTH ITHAN AVENUE = 486 FT. SECTION 255-38.B INTERVALS OF NOT MORE THAN 3D FEET	466'/30' = 16 TREES	16 TREES
BUFFER SCREENS		
SOUTHERN PROPERTY LINE ADJACENT TO R-100 TRAIN RIGHT OF WAY SECTION 255-42 CLASS OF BUFFER SCREEN OPTION SELECTED: (1) EVERGREEN PER 15 FEET (INFORMALLY ARRANGED) PLUS; (1) EVERGREEN SHRUB PER 8 FEET (INFORMALLY ARRANGED)	927715 = 62 ÉVERGREEN TREES 92778 = 116 EVERGREEN SHRIJBS	140 EVERGREEN TREES 2 UNDERSTORY DECIDUOUS TREES* 124 EVERGREEN SHRUBS 75 DECIDUOUS SHRUBS* SEE NOTE #1
ALDWYN TRIANGLE	NOT APPLICABLE	28 EVERGREEN TREES 16 UNDERSTORY DECIDUOUS TREES
REPLACEMENT TREES		
HOUSING PROJECT SITE 8 TO 18 INCH DBH REMOVED = (1) REPLACEMENT TREE 15 TO 28 INCH DBH REMOVED = (3) REPLACEMENT TREES** 30 INCH DBH OR GREATER REMOVED = (8) REPLACEMENT TREES**	(39) REMOVALS @ 6 TO 16 INCH = 39 REPLACEMENTS (3) REMOVALS @ 16 TO 29 INCH = (3)X3= 9 REPLACEMENTS TOTAL REPLACEMENT TREES REQUIRED = 48 TREES	LARGE CANOPY TREES = 33 TREES ORNAMENTAL TREES = 29 TREES*
PARKING LOT		
SECTION 255-28.B (1) ONE TREE FOR EVERY FIVE PARKING SPACES IN SINGLE BAYS AND ONE TREE FOR EVERY YEN PARKING SPACES IN DOUBLE BAYS	62 SPACES/10 = 6,2	10
PROPOSED BUFFER PLANTING INCLUDES UNDERSTORY DECIDIOUS TREES, PLANTS OFFER VISUAL SCREENING QUALITIES AND FOUR SEASON INTEREST 1 TWO BEING LARGE CANOPY TREES THOUR BEING LARGE CANOPY TREES		TING, MATURE TREES ARE TO REMAIN. THES

PLANT SCHE	QTY	BOTANICAL NAME	COMMON NAME	CONT	CAL	SIZE
AA2	13	ACER RUBRUM 'ARMSTRONG'	ARMSTRONG RED MAPLE	B&B	2 1/2" - 3"	
AS AS	11	ACER RUBRUM 'SOMERSET'	SOMERSET RED MAPLE		2" - 2 1/2"	
ASC	5	ACER SACCHARUM COMMEMORATION	COMMEMORATION SUGAR MAPLE		2" - 2 1/2"	
CJ	6	CERCIDIPHYLLUM JAPONICUM	KATSURA TREE	B&B	2" - 2 1/2"	
FF	6	FAGUS SYLVATICA 'FASTIGIATA'	EUROPEAN BEECH	B & B	2"-2-1/2"	
GA	2	GINKGO BILOBA 'AUTUMN GOLD' TM	MAIDENHAIR TREE	B & B	2" - 2 1/2"	
GS2	6	GLEDITSIA TRIACANTHOS 'SKYLINE'	SKYLINE HONEY LOCUST	B&8	2 1/2" - 3"	
LR	16	LIQUIDAMBAR STYRACIFLUA 'ROTUNDILOBA' TM	ROUND-LOBED SWEET GUM	B & B	2 1/2" - 3"	
NS	2	NYSSA SYLVATICA	SOUR GUM	BAB	21 - 2 1/2"	ļ
PB2	12	PLATANUS X ACERIFOLIA 'BLOODGOOD'	LONDON PLANE TREE	B&B	2 1/2" - 3"	
QA QA	14	QUERCUS ALBA	WHITE OAK	B & B	2" - 2 1/2"	-
TD2	4	TAXODIUM DISTICHUM	BALD CYPRESS	8&8	2 -2 112	8'-10' HT.
ÜV	6	ULMUS AMERICANA "VALLEY FORGE"	AMERICAN ELM	B&B	2" - 2 1/2"	u - 10 7117
UV	ь	DEMOS AMERICANA VALLEY FORGE	AMERICAN ELM	1000	2 -2 1/2	L
EVERGREEN TREES	QTY	BOTANICAL NAME	COMMON NAME	CONT	CAL	SIZE
CY	16	CRYPTOMERIA JAPONICA 'YOSHINO'	YOSHINO CRYPTOMERIA	B&B		B'-10' HT.
IN	36	ILEX X 'NELLIE R STEVENS'	NELLIE STEVENS HOLLY	888		81-101 HT.
PA2	60	PICEA ABIES	NORWAY SPRUCE	B & B		8°-10° HT
P03	25	PICEA OMORIKA	SERBIAN SPRUCE	B & B		8°-10" HT
CL	31	X CUPRESSOCYPARIS LEYLANDII	LEYLANDI CYPRESS	B & B		8'-10' HT
ORNAMENTAL TREES	QTY	BOTANICAL NAME	COMMON NAME	CONT	CAL	SIZE
AC3	16	AMELANCHIER CANADENSIS	SHADBLOW SERVICEBERRY MULTI-TRUNK	B&B		B'-10' HT
CCM	9	CERCIS CANADENSIS	EASTERN REDBUD MULTI-TRUNK	B & B	1	8'-10' HT
CC3	8	CORNUS FLORIDA "CHEROKEE CHIEF"	CHEROKEE CHIEF DOGWOOD	B & B	2" - 2 1/2"	
CK4	3	CORNUS KOUSA	KOUSA DOGWOOD	B & B	2 2 1/2	8'-10' HT
CM CM	9	CORNUS MAS	CORNELIAN CHERRY DOGWOOD	B&B		8'-10' HT
ME	6	MAGNOLIA GRANDIFLORA 'EDITH BOGUE'	EDITH BOGUE SOUTHERN MAGNOLIA	B&B	<del> </del>	B10. HI
Ms	19	MAGNOLIA VIRGINIANA	SWEET BAY MULTI-TRUNK	888		8°-10° HT
MG2	4	MAGNOLIA Y 'GALAXY'	GALAXY MAGNOLIA	B & B	2" - 2 1/2"	u - ju 111
MGZ	4	MAGNOLIA X GALAXI	GALACT WAGNOUN	I B G D	2 -2 112	
SHRUBS	QTY	BOTANICAL NAME	COMMON NAME	CONT	SIZE	
AA3	55	ARONIA ARBUTIFOLIA 'BRILLIANTISSIMA'	BRILLIANT RED CHOKEBERRY/RED CHOKEBERRY	3 GAL	24"-30" HT.	
CH	105	CLETHRA ALNIFOLIA 'HUMMINGBIRD'	SUMMERSWEET	3 GAL	18"-24" SPREAD	
HI	2	HAMAMELIS X INTERMEDIA 'ARNOLD PROMISE'	ARNOLD PROMISE HYBRID WITCH HAZEL	B&B	4'-5' HT.	1
1R2	121	ILEX VERTICILLATA 'RED SPRITE'	RED SPRITE WINTERBERRY	3 GAL	24"-30" HT	1
l.\$2	25	LINDERA GLAUCA SALICIFOLIA	SPICEBUSH	8&8	4'-5' HT.	1
PS	83	PRUNUS LAUROCERASUS 'SCHIPKAENSIS'	SCHIPKA LAUREL	B&B	3' -4' HT.	
RV	88	RHODODENDRON VISCOSUM	SWAMP AZALEA	3 GAL	18"-24" HT.	
99	71	SPIRAEA JAPONICA 'LITTLE PRINCESS'	LITTLE PRINCESS JAPANESE SPIREA	3 GAL	18"-24" SPREAD	
VA2	32	VIBURNUM DENTATUM	VIBURNUM	B&B	5'-6' HT.	1
VL	42	VIBURNUM RHYTIDOPHYLLUM	LEATHERLEAF VIBURNUM	B & B	5'-6' HT.	T
VB	16	VIBURNUM X BURKWOODII	BURKWOOD VIBURNUM	B & B	4'-5' HT.	
			Logialous	loour		
GROUND COVERS	QTY	BOTANICAL NAME	COMMON NAME	CONT	<del></del>	+
CS2	3,296	CAREX SPP. @ 15" O.C.		FLAT		

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#### PRELIM. LAND DEVELOPMENT SUBMISSION


Title Planting Schedule and Tabulations

Scale As Indicated
Drawn By DF

L2.0

NOTES:


1. QUANTITY, AND ARRANGEMENT OF PLANT MATERIAL WITHIN BUFFER SCREEN WILL PRODUCE A VISUAL SCREEN NOT TO BE SEEN THROUGH
AND PROVIDE IMMEDIATE VISUAL SCREENING TO THE ABUTTING PROPERTY OR DISTRICT AS PER SECTION 280-71.A, OF THE TOWNSHIP
ZONNO GRDINANCE.

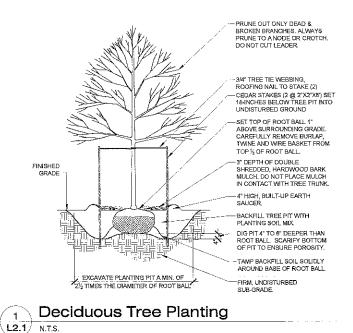

NOTE:

1. ALL TREE PITS SHALL
PERCOLATE SUFFICIENTLY FOR
PROPER TREE GROWTH, TEST
EACH PIT. REINFORCED RUBBER HOSE #12 GALV WIRE (3) SET TOP OF ROOT BALL 1" ABOVE SURROUNDING GRADE. CAREFULLY REMOVE BURLAP, TWINE AND WIRE BASKET FROM TOP 1/4 OF ROOT BALL, 3" DEPTH OF DOUBLE SHREDDED, HARDWOOD BARK MULCH, DO NOT PLACE MULCH IN CONTACT WITH TREE TRUNK CEDAR STAKES (2"X2"X2") SET BELOW TREE PIT IN UNDISTURBED 4" HIGH, BUILT-UP EARTH SAUCER. FILE PLANTING PIT WITH PLANTING SOIL MIX. DIG PIT 4" TO 6" DEEPER THAN ROOT BALL SCARIFY BOTTOM OF PIT TO ENSURE POROSITY. TAMP BACKFILL SOIL SOLIDLY AROUND BASE OF ROOT BALL EXCAVATE PLANTING PIT A MIN. OF FIRM, UNDISTURBED

Evergreen Tree Planting

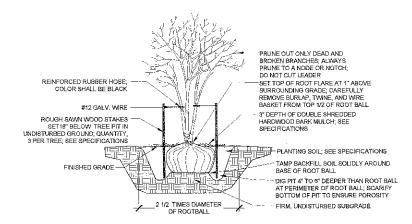

#### Multi-Stem Tree Planting L2.1 Scale: 0 1' 2' 4' Scale: 1/2"=1'-0"

## PROPOSED 6' HIGH CHAIN LINK FENCING DRIPLINE -EXISTING TREE 2" MESH #9 GAUGE EXISTING GRADE Tree Protection Detail

\_8' Scale; 1/4"=1'-0"

NO STORAGE OF MATERIALS OR OPERATION OF EQUIPMENT SHALL BE PERMITTED WITHIN TREE PROTECTION FENCING. PRO IECTION FENCING.

2. A 4"LAYER OF COARSE MULCH OR WOODCHIPS IS TO BE PLACED BENEATH THE DRIPLINE OF THE PROTECTED TREES. MULCH IS TO BE KEPT 12" FROM THE TRUNK.

L2.1/

N.T.S.


PHOTECHED TREES, MULCH IS TO BE REFT 12" FROM THE TRUNK.

A PROTECTIVE BARRIER OF 6" CHAIN LINK FENCING SHALL BE INSTALLED AROUND THE DRIPLINE OF THE PROTECTED TREES(S). THE FENCING CAN BE MOVED WITHIN THE ORIPLINE IS AUTHROIZED BY THE CONSULTING ARBORIST BUT NOT CLOSER THAN 2" FROM THE TRUNK OF ANY TREE, FENCE POSTS SHALL NOT BE ZO" IN DIAMETER AND ARE TO BE DRIVEN 2" INTO THE GROUND. THE DISTANCE BETWEEN POSTS SHALL NOT BE MORE THAN 10", THIS ENCLOSED AREA IS THE TREE PROTECTION ZONE (TPVZ), FENCING SHALL BE MAINTAINED THROUGHOUT THE DURATION OF THE WORK AT THE SITE OR UNTIL REMOVAL IS APPROVED BY OWNERS REPRESENTATIVE.

ADDITIONAL WARNING SIGNS SHOULD ALSO BE PLACED OF THE FERCING AND IN THE FURCHING AND IN APPROPRIATE

PLACED ON THE FENCING AND IN APPROPRIATE AREAS NEAR THE WORK ZONE AREAS NEAR THE WORK ZONE
TREE PROTECTION FENCE SHALL BE INSPECTED AND
MAINTAINED BY THE CONTRACTOR AT THE END OF
EVERY DAY FOR THE DURATION OF THE PROJECT.

EVERY DAY FOR THE DURATION OF THE PROJECT. THE FENCE SHALL BE REPAIRED WHERE NECESSARY. WHERE FENCE MUST BE LOCATED WITHIN FIVE(5) FEET OF EXISTING TREE TRUNK, THE TRUNK PROTECTION DETAIL SHALL ALSO BE USED. TREE PROTECTION MEASURES SHALL COMPLY WITH ALL TOWNSHIP REGULATIONS AND ORDINANCES.

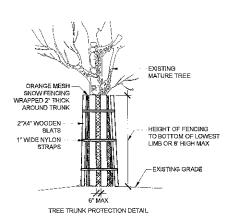



SEE PLANS AND PLANT SCHEDULE FOR SPACING - 3" DEPTH OF DOUBLE SHREDDED HARDWOOD BARK MULCH; DO NOT PLACE MULCH IN CONTACT WITH TRUNK OF SHRUB; SEE SPECIFICATIONS 12" MINIMUM DEPTH OF PLANTING SOIL SEE SPECIFICATIONS

TILL APPROXIMATELY 1/2 OF PLANTING SOIL WITH TOP 6" OF EXISTING SUBSOIL SEE SPECIFICATIONS.

## Shrub Planting 4' Scale: 1/2"=1'-0"

## A O,C, SPACING O.C. SPACING 7" 7 3/4" 8 5/8" 10 1/2" 13" 15 1/2" 21" NOTES: PRIOR TO BACKFILLING CUT POT-BOUND ROOTS. AFTER PLANTING, THE ENTIRE BED SHALL BE EDGED AND THOROUGHLY WATERED. 2. SEE SPECIFICATIONS FOR LANDSCAPE BED DOUBLE SHREDDED HARDWOOD BARK MULCH; AT A 2" DEPTH; SEE SPECIFICATIONS PLANTING SOIL B" DEPTH (SEE SPECIFICATIONS) SUBGRADE

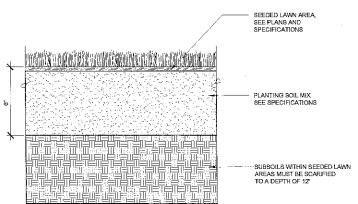

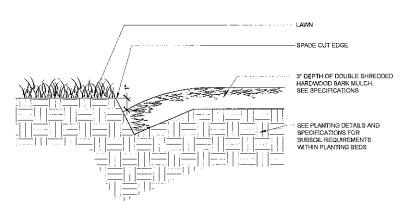



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PRELIM. LAND DEVELOPMENT

SUBMISSION

December 5, 2014

Title Planting Details

L2.1

30 of 30 ntractor to verify all dimensions in field and inform thitect of any discrepancies before starting work.

Groundcover Planting L2.1 N.T.S.

SECTION VIEW

L2.1

L2.1/ N.T.S.

Seed Planting