
1 INCH = 40 FT.

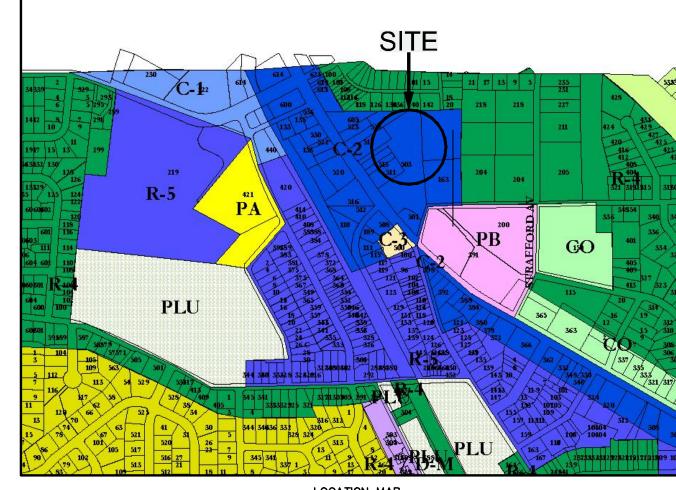

LOCATION MAP SCALE: 1" = 600

ZONING DISTRICT C-2: (GENERAL COMMERCIAL DISTRICT)
LOT SIZE 20,000 SF MIN
WIDTH AT BUILDING LINE 100' MIN

BUILDING AREA 30% MAX
FRONT YARD 15' MIN
SIDE YARD 20' MIN.

30' ABUTTING A RESIDENTIAL DISTRICT
REAR YARD GREATER OF 35' OR 30% OF LOT DEPTH
BUILDING HEIGHT 35' MAX

BUILDING COVERAGE 30% MAX IMPERVIOUS COVERAGE 70% MAX

FOR MORE DETAILED INFORMATION YOUR ATTENTION IS CALLED TO THE ZONING CODE OF RADNOR TOWNSHIP, LATEST EDITION.

GENERAL NOTES

1. OWNER/APPLICANT:
VILLAGE ASSOCIATES
503 WEST LANCASTER AVENUE
SUITE 240
WAYNE, PA 19087

2. BOUNDARY SURVEY AND EXISTING CONDITION INFORMATION TAKEN FROM A PLAN ENTITLED, "FINAL LAND DEVELOPMENT PLANS PREPARED FOR EAGLE VILLAGE SHOPS, 503 WEST LANCASTER AVENUE" PREPARED BY YERKES ASSOCIATES INC. DATED OCTOBER 1, 2010, LAST REVISED 01/14/11 (PLAN #D-36-11-316).

3. ADDITIONAL SITE FEATURES INCLUDING BUILDINGS AND OTHER FEATURES DEPICTED ON THE VICINITY PLAN WERE NOT PHYSICALLY SURVEYED. LOCATIONS OF THESE FEATURES WERE TAKEN FROM AVAILABLE PLANS, AERIAL PHOTOGRAPHS AND OTHER SOURCES AND REPRESENT AN ESTIMATE OF THE EXTENT OF THESE FFATURES.

4. VERTICAL DATUM: APPROXIMATE U.S.G.S.

5. IN ACCORDANCE WITH FEMA PANEL NUMBER 42045C0017F EFFECTIVE DATE NOVEMBER 18, 2009, PREMISES IS LOCATED IN ZONE X, AREAS DETERMINED TO BE OUTSIDE THE 0.2% ANNUAL CHANCE FLOOD PLAIN

6. SOIL INFORMATION TAKEN FROM THE SOIL SURVEY FOR CHESTER AND DELAWARE COUNTIES PREPARED BY THE UNITED STATES DEPARTMENT OF AGRICULTURE.

7. THE PROPOSED DEVELOPMENT WILL INCLUDE THE REMOVAL OF EXISTING WALKWAYS AND THE CONSTRUCTION OF A NEW GREENHOUSE CONNECTING THE TWO EXISTING BUILDINGS ON EITHER END OF THE GREENHOUSE. THE REMAINING AREA BETWEEN THE TWO EXISTING STRUCTURES WILL BE CONVERTED TO AN OUTDOOR SALES DISPLAY AREA. THE AREA WILL CONSIST OF A PAVED COURTYARD WITH SURROUNDING SYNTHETIC TURF AREAS. THERE WILL ALSO BE SOME MINOR REALIGNMENT OF CURBING AND SIDEWALKS. THE CHANGES RESULT IN A NET REDUCTION IN IMPERVIOUS SURFACE.

8. AS THE RESULT OF THE REPLACEMENT IMPERVIOUS COVER, GROUNDWATER RECHARGE IS REQUIRED. A RECHARGE FACILITY TO BE CONSTRUCTED BENEATH A PORTION OF THE EXISTING PARKING LOT WILL PROVIDE THE REQUIRED RECHARGE.

9. THIS SITE IS CURRENTLY SERVED BY PUBLIC DOMESTIC WATER SERVICE PROVIDED BY AQUA PENNSYLVANIA. PUBLIC WATER SERVICE IS TO BE MAINTAINED.

10. THIS SITE IS CURRENTLY SERVED BY PUBLIC SEWER SERVICE. EXISTING SEWER SERVICE IS TO BE MAINTAINED.

11. MAINTENANCE FOR THE SITE TO BE THE RESPONSIBILITY OF THE SHOPPING CENTER.

12. THE STORMWATER MANAGEMENT RECHARGE AND COLLECTION SYSTEM AND INLETS ARE TO BE OWNED AND MAINTAINED BY THE SHOPPING CENTER. ROOF DRAINS ARE TO BE TIED INTO THE STORMWATER MANAGEMENT DETENTION SYSTEMS AS NOTED ON THE PLANS.

13. A GENERAL EASEMENT IS HEREBY CREATED OVER THE STORMWATER MANAGEMENT SYSTEMS THAT PERMITS INGRESS AND EGRESS BY RADNOR TOWNSHIP.

14. NO PERSON SHALL MODIFY, REMOVE, FILL, LANDSCAPE, OR ALTER ANY EXISTING STORMWATER CONTROL OR BMP, UNLESS IT IS PART OF AN APPROVED MAINTENANCE PROGRAM, WITHOUT THE WRITTEN APPROVAL OF THE MUNICIPALITY.

15. NO PERSON SHALL PLACE ANY STRUCTURE, FILL, LANDSCAPING, OR VEGETATION INTO A STORMWATER CONTROL OR BMP OR WITHIN A DRAINAGE EASEMENT WHICH WOULD LIMIT OR ALTER THE FUNCTIONING OF THE STORMWATER CONTROL OR BMP WITHOUT THE WRITTEN APPROVAL OF THE MUNICIPALITY.

16. BENCHMARK IS EXISTING TYPE M INLET - ELEV. 96.20.

PROJECT NARRATIV

IT IS PROPOSED TO CONSOLIDATE ALL OF THE EXISTING INDIVIDUAL PARCELS THAT COMPRISE THE OVERALL CENTER INTO ONE PARCEL. THE MINOR DEVELOPMENT PROJECT INVOLVES PROVIDING A SMALL, ENCLOSED CONNECTING LINK (589 S.F. GROSS AREA) BETWEEN THE VALLEY FORGE FLOWERS BARN BUILDING AND THE ADJOINING BUILDING 3 LAST OCCUPIED BY AREA RUG AND THE VILLAGE SALON. BUILDING 3 WILL IN TURN BE RENOVATED TO BECOME PART OF THE VALLEY FORGE FLOWERS BARN GARDEN CENTER SPACE. THE VILLAGE SALON WILL RELOCATE TO A SMALLER SPACE IN BUILDING 11 ON PARCEL C/E. THE 589 S.F. (GROSS) CONNECTOR GENERATES A PARKING REQUIREMENT OF 3 PARKING SPACES WHICH WILL BE SATISFIED BY PAVING A PORTION OF THE EXISTING GRAVEL AREA TO CREATE THE REQUIRED SPACES.

STATE OF PENNSYLVANIA COUNTY OF DELAWARE SS

ON THIS _____ DAY OF _____, 20__, BEFORE ME A NOTARY PUBLIC IN AND FOR THE COMMONWEALTH OF PENNSYLVANIA, THE UNDERSIGNED OFFICER, PERSONALLY APPEARED _____, AUTHORIZED SIGNOR FOR VILLAGE ASSOCIATES. (A PENNSYLVANIA LIMITED PARTNERSHIP). WHO BEING DULY SWORN ACCORDING TO LAW DESPOSES AND SAYS THAT SAID VILLAGE ASSOCIATES OWNS THE PROPERTY SHOWN ON THIS PLAN, THAT THE LAND DEVELOPMENT SHOWN ON THIS PLAN WAS MADE AT HIS/HER DIRECTION AND WITH HIS/HER CONSENT AND THAT IT IS DESIRED THAT SAID PLAN BE RECORDED IN ACCORDANCE WITH LAW.


OWNER, VILLAGE ASSOCIATES, (A PENNSYLVANIA LIMITED PARTNERSHIP)

NOTARY PUBLIC OR OTHER OFFICER


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MY COMMISSION EXPIRES:____

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ALL BEFORE YOU DIG!
ENNSYLVANIA LAW REQUIRES
WORKING DAYS NOTICE FOR ONSTRUCTION PHASE AND 10 WORKING AYS IN DESIGN STAGE-STOP CALL FENDSYVANIA ONE CAIL System, Inc.
1—800—242—1776

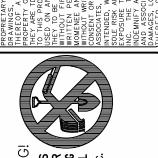

OMENEE & ASSOCIATES, INC.

VIL ENGINEERS AND LAND SURVEYORS

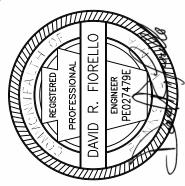924 COUNTY LINE ROAD, BRYN MAWR, PA 19010

PHONE: (610) 527-3030 FAX. (610) 527-9008

63 EAGLE ROAD

> * DELAWARE COUNTY * PENNSYLVANIA

OWNER/APPLICANT

VILLAGE ASSOCIATES

VILLAGE ASSOCIATES


WAYNE, PA 19087

ONE—CALL:

DRAWN BY:

CHECKED BY:

DR

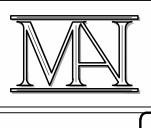


DATE: PER TWP REVIEW
REV. DATE COMMENTS


SHEET NO.

OF 7

SCALE: 1" = 40'

FILE NO.: 13-345

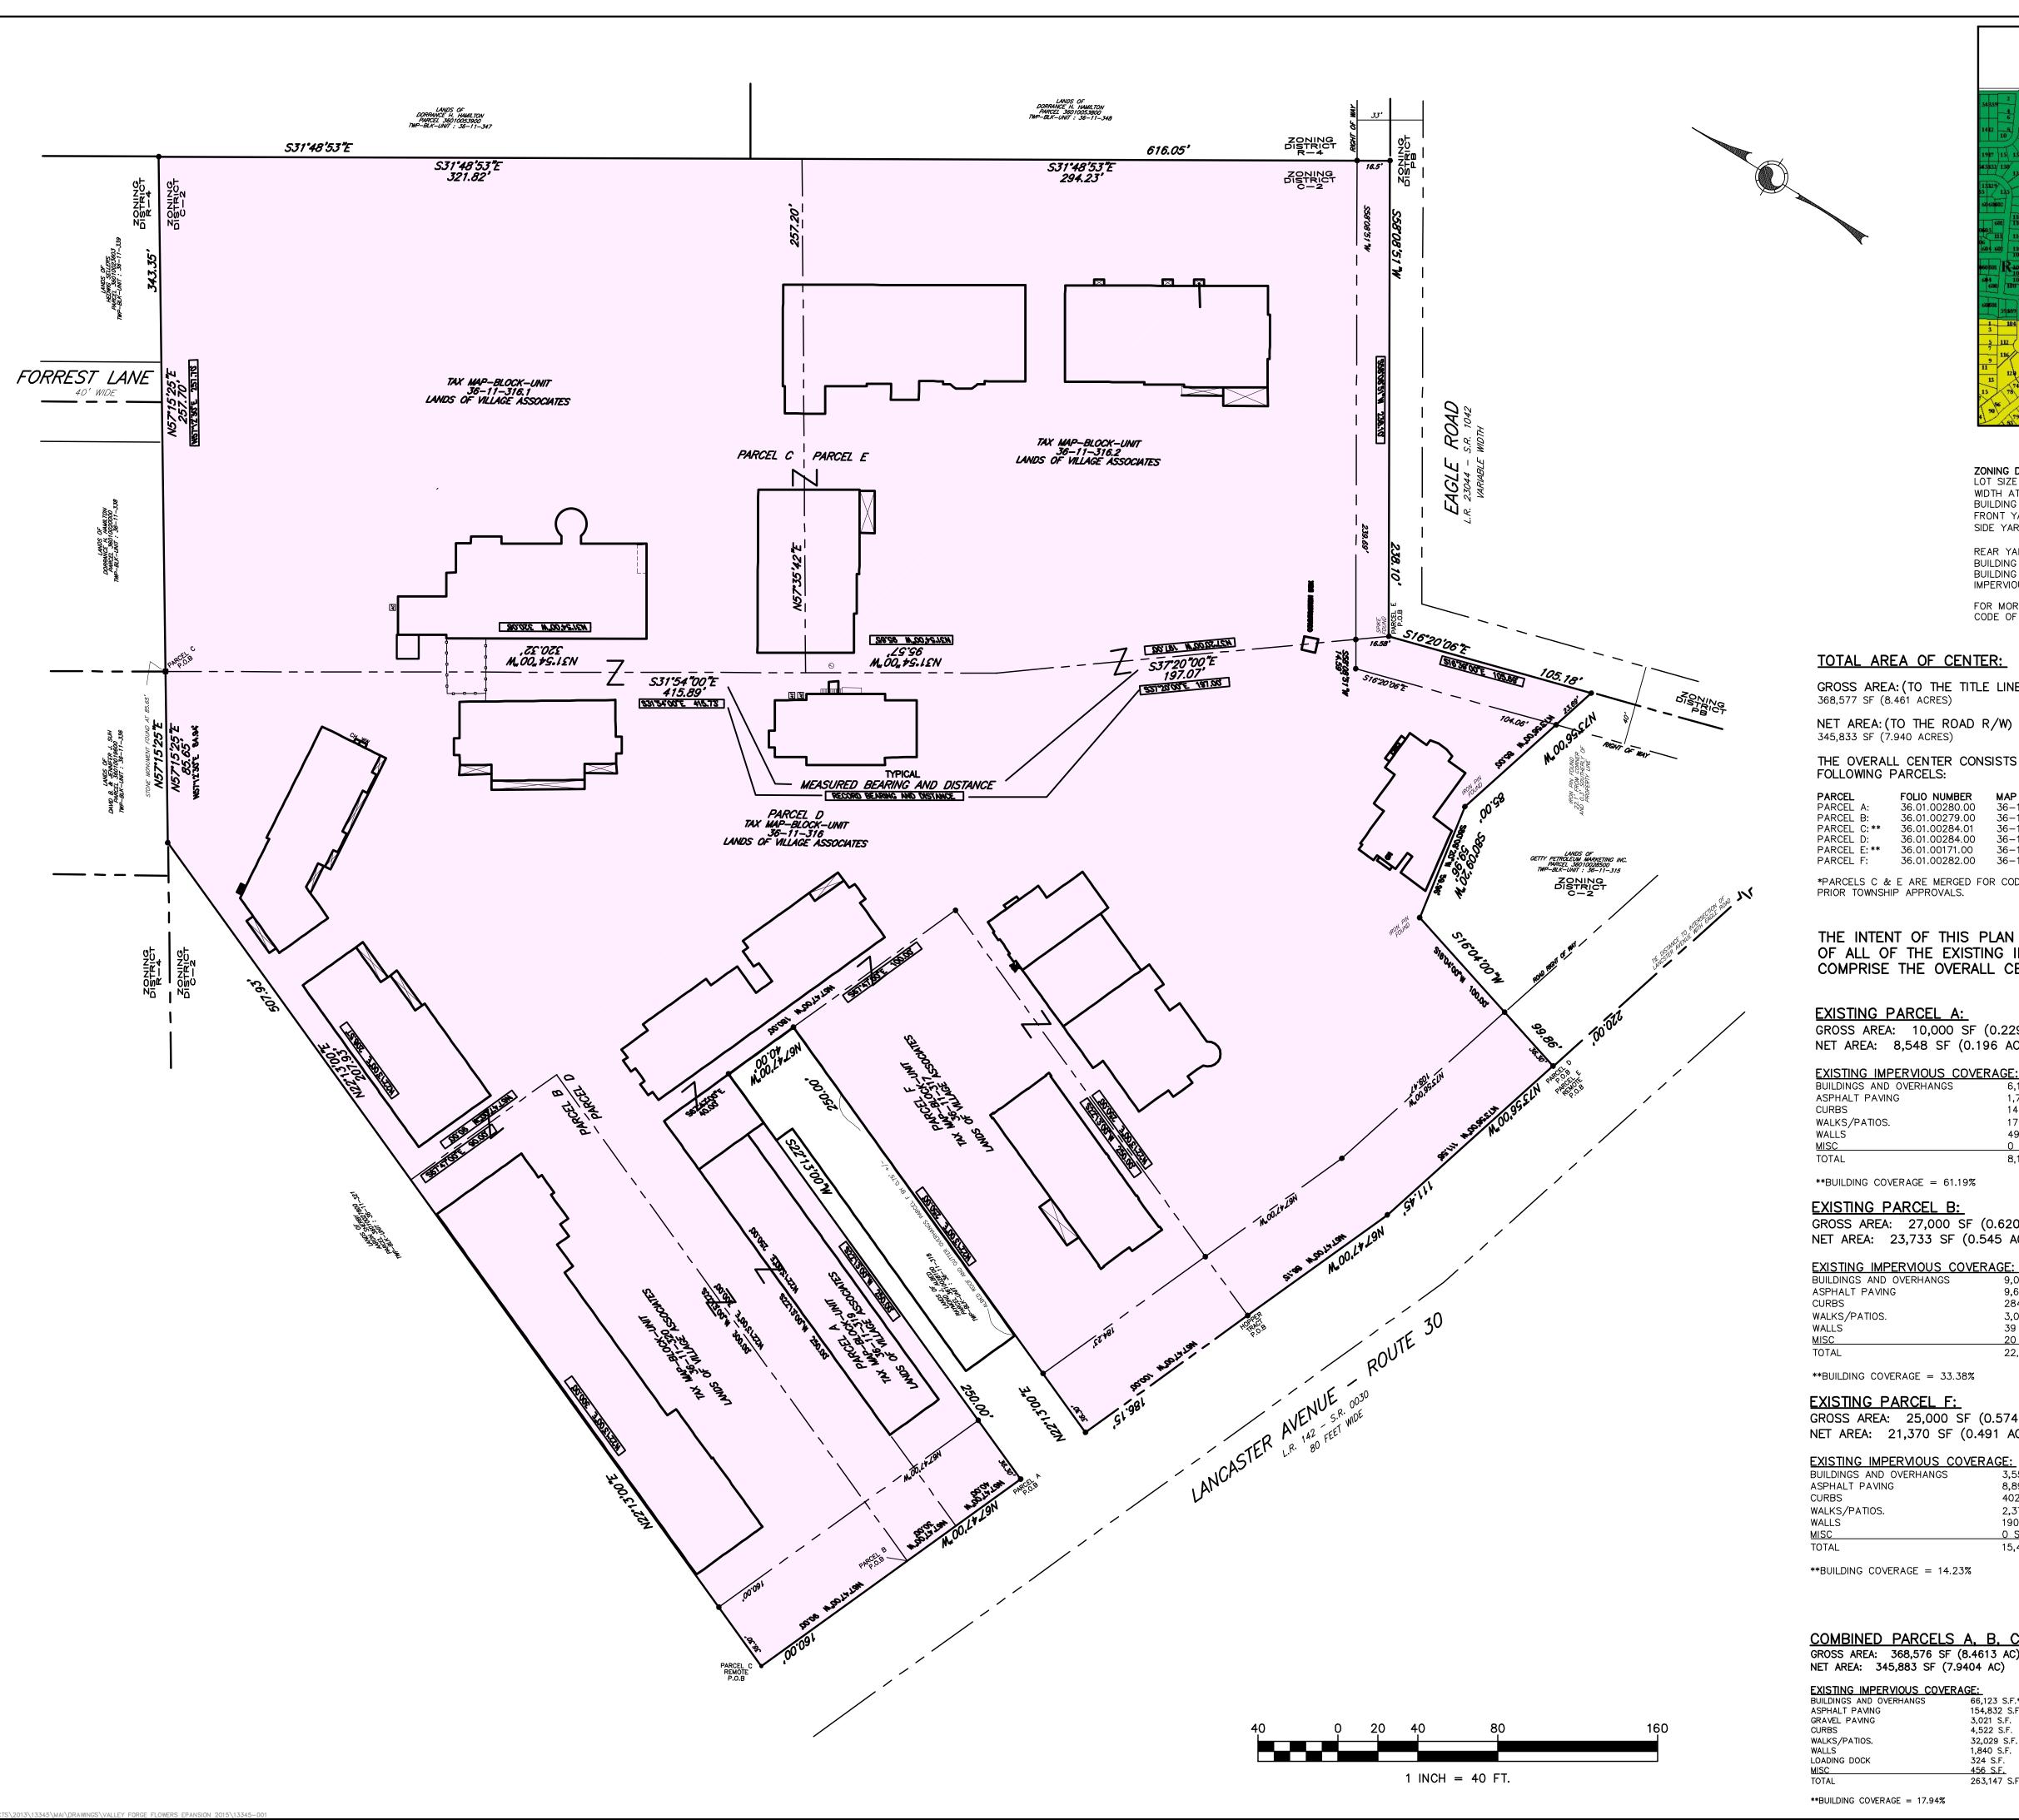

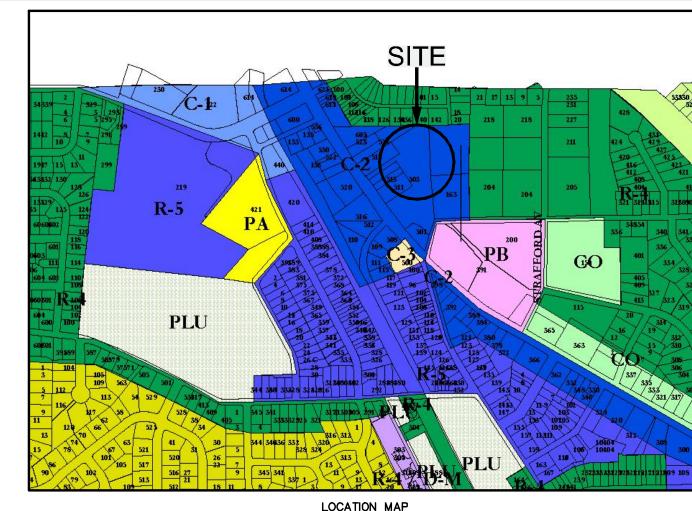

LOCATION MAP SCALE: 1" = 600

ZONING DISTRICT C-2: (GENERAL COMMERCIAL DISTRICT)
LOT SIZE 20,000 SF MIN WIDTH AT BUILDING LINE 100' MIN BUILDING AREA 30% MAX

FRONT YARD 15' MIN SIDE YARD 20' MIN. 30' ABUTTING A RESIDENTIAL DISTRICT

GREATER OF 35' OR 30% OF LOT DEPTH REAR YARD BUILDING HEIGHT 35' MAX

BUILDING COVERAGE 30% MAX 70% MAX

FOR MORE DETAILED INFORMATION YOUR ATTENTION IS CALLED TO THE ZONING CODE OF RADNOR TOWNSHIP, LATEST EDITION.

TOTAL AREA OF CENTER:

GROSS AREA: (TO THE TITLE LINE) 368,577 SF (8.461 ACRES)

NET AREA: (TO THE ROAD R/W) 345,833 SF (7.940 ACRES)

THE OVERALL CENTER CONSISTS OF THE FOLLOWING PARCELS:

PARCEL A: 36-11-319:000 PARCEL B: 36.01.00279.00 36-11-320:000 PARCEL C: ** 36.01.00284.01 36-11-316:001 PARCEL C: ** 36.01.00284.01 36-11-316.001
PARCEL D: 36.01.00284.00 36-11-316.000
PARCEL E: ** 36.01.00171.00 36-11-316:002
PARCEL F: 36.01.00282.00 36-11-317:000

*PARCELS C & E ARE MERGED FOR CODE PURPOSES PER PRIOR TOWNSHIP APPROVALS.

THE INTENT OF THIS PLAN IS TO SHOW THE CONSOLIDATION OF ALL OF THE EXISTING INDIVIDUAL PARCELS THAT COMPRISE THE OVERALL CENTER INTO ONE PARCEL.

EXISTING PARCEL A:

GROSS AREA: 10,000 SF (0.229 AC) NET AREA: 8,548 SF (0.196 AC)

EXISTING IMPERVIOUS COVERAGE: BUILDINGS AND OVERHANGS 6,119 S.F.** ASPHALT PAVING 1,779 S.F. 14 S.F.

WALKS/PATIOS. 179 S.F. WALLS 49 S.F. 0 S.F. 8,140 S.F. (81.40%)

**BUILDING COVERAGE = 61.19%

GROSS AREA: 27,000 SF (0.620 AC) NET AREA: 23,733 SF (0.545 AC)

EXISTING IMPERVIOUS COVERAGE: BUILDINGS AND OVERHANGS

9,013 S.F.** ASPHALT PAVING 9,629 S.F. CURBS 284 S.F. WALKS/PATIOS. 3,054 S.F. WALLS 39 S.F. 20 S.F. 22,039 S.F. (81.63%) TOTAL

**BUILDING COVERAGE = 33.38%

EXISTING PARCEL F: GROSS AREA: 25,000 SF (0.574 AC) NET AREA: 21,370 SF (0.491 AC)

BUILDINGS AND OVERHANGS ASPHALT PAVING 8,890 S.F. CURBS 402 S.F. WALKS/PATIOS. 2,373 S.F. 190 S.F. WALLS 0 S.F. 15,412 S.F. (61.65%)

**BUILDING COVERAGE = 14.23%

COMBINED PARCELS A, B, C, D, E & F: GROSS AREA: 368,576 SF (8.4613 AC) NET AREA: 345,883 SF (7.9404 AC)

EXISTING IMPERVIOUS COVERAGE:
BUILDINGS AND OVERHANGS 66,123 S.F.** 154,832 S.F. GRAVEL PAVING 4,522 S.F. WALKS/PATIOS. 32,029 S.F. 1,840 S.F. 324 S.F. WALLS LOADING DOCK 456 S.F.

263,147 S.F. (71.40%) **BUILDING COVERAGE = 17.94%

EXISTING CONSOLIDATED PARCELS C & E

104,856 S.F. (67.18%)

GROSS AREA: 156,116 SF (3.584 AC) NET AREA: 152,175 SF (3.493 AC)

EXISTING IMPERVIOUS COVERAGE: 21,486 S.F.** BUILDINGS AND OVERHANGS ASPHALT PAVING 69,546 S.F. 1,781 S.F. WALKS/PATIOS. 11,144 S.F. 329 S.F. WALLS LOADING DOCK 324 S.F. 246 S.F.

**BUILDING COVERAGE = 13.76%

EXISTING PARCEL D:

TOTAL

GROSS AREA: 150,460 SF (3.454 AC) NET AREA: 140,057 SF (3.215 AC)


EXISTING IMPERVIOUS COVERAGE:

BUILDINGS AND OVERHANGS 25,948 S.F.** ASPHALT PAVING 64,988 S.F. GRAVEL PAVING 3,021 S.F. 2,041 S.F. CURBS WALKS/PATIOS. 15,279 S.F. WALLS 1,233 S.F. 190 S.F. 112,700 S.F. (74.89%)

**BUILDING COVERAGE = 17.25%






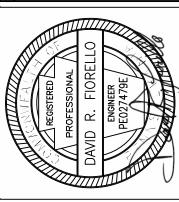

INC. MOMENEE CIVIL ENGINE



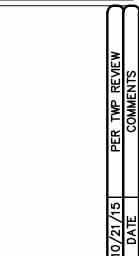

DATE: OCTOBER 21, 2015 SHEET NO.

OF 7 SCALE: 1" = 40'

FILE NO.: 13-345

COMBINED PARCELS A, B, C, D, E & F:

EXISTING IMPERVIOUS COVERAGE: BUILDINGS AND OVERHANGS ASPHALT PAVING GRAVEL PAVING WALKS/PATIOS. LOADING DOCK 456 S.F. 263,147 S.F. (71.40%)

COMBINED PARCELS A, B, C, D, E & F: GROSS AREA: 368,576 SF (8.4613 AC) NET AREA: 345,883 SF (7.9404 AC)

PROPOSED IMPERVIOUS COVERAGE:
BUILDINGS AND OVERHANGS 66,712 S.F.** 156,269 S.F. ASPHALT PAVING GRAVEL PAVING 1.631 S.F. 4,514 S.F. 31,075 S.F. WALKS/PATIOS. WALLS 1.823 S.F. LOADING DOCK 324 S.F. 262,709 S.F. (71.28%)

**BUILDING COVERAGE = 18.10%

**BUILDING COVERAGE = 17.94%

<u>5.5</u> 31.4 SPACES EXISTING SPACES (PARCEL A) = 0 NONCONFORMITY = 32 SPACES

PARKING TABULATION: PARCEL B

EXISTING CONDITIONS*: = 34.29 GROUND FLOORS 6,858/200 16 EMPLOYEES (EST) 16/2
TOTAL REQUIRED 42.29 SPACES EXISTING SPACES (PARCEL B) = 17 NONCONFORMITY = 26 SPACES

50 EMPLOYEES (EST) 50/2 TOTAL REQUIRED = 132 SPACES ***SEATING: SILVER SPOON = 30, VVF CAFE = 12 , VVF BARN CAFE = 24 SEATS EXISTING SPACES (PARCELS C & E) = 161

= 29 SPACES

PARKING TABULATION: PARCEL D


SURPLUS

EXISTING CONDITIONS*: = 77.8 GROUND FLOORS 15,562/200 OFFICE 987/200 = 4.9 RESTAURANT SEATING*** 208/3 = 69.3 65 EMPLOYEES (EST) 65/2 TOTAL REQUIRED = 185 SPACES ***SEATING: TASTE OF BRITAIN = 48, FINE DINING = 160 EXISTING SPACES (PARCEL D) = 130 NONCONFORMITY = 55 SPACES NOTE: APPLICANT DOES NOT INTEND TO ABANDON ANY PARKING EXISTING SPACES (PARCEL B) = 18 = 3 SPACES

PARKING TABULATION: ALL PARCELS (A. B. C/E. D. & F)

EXISTING CONDITIONS*: GROUND FLOORS 44,043/200 = 220.2 UPPER FLOORS 3,558/300 = 11.9 = 8.7 OFFICE 1,734/200 RESTAURANT SEATING 274/3 = 91.3 144 EMPLOYEES (EST) 144/2 = 404 SPACES TOTAL REQUIRED EXISTING SPACES (TOTAL) = 327 NON CONFORMITY = 77 SPACES

* FLOOR AREAS ARE 80% OF TOTAL PER ZONING ORDINANCE DEFINITION

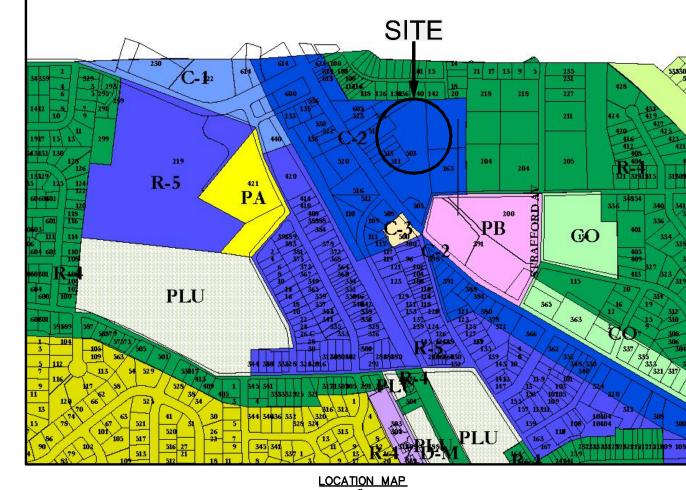

LOCATION MAP SCALE: 1" = 600

ZONING DISTRICT C-2: (GENERAL COMMERCIAL DISTRICT)
LOT SIZE 20,000 SF MIN WIDTH AT BUILDING LINE 100' MIN BUILDING AREA 30% MAX FRONT YARD 15' MIN

SIDE YARD 20' MIN. 30' ABUTTING A RESIDENTIAL DISTRICT REAR YARD GREATER OF 35' OR 30% OF LOT DEPTH BUILDING HEIGHT 35' MAX

BUILDING COVERAGE 30% MAX IMPERVIOUS COVERAGE 70% MAX

FOR MORE DETAILED INFORMATION YOUR ATTENTION IS CALLED TO THE ZONING CODE OF RADNOR TOWNSHIP, LATEST EDITION.

ZONING COMPLIANCE TABULATION - PARCEL A:

<u>ITEM</u>	REQUIREMENT	EXISTING
LOT AREA	20,000 SF MIN.	10,000 SF GROSS
		8,548 SF NET OF R/N
LOT WIDTH	100 FEET AT BUILDING LINE	40.0 FEET
BUILDING COVERAGE	30% MAXIMUM	6,119 SF (61.19%)
FRONT YARD	15 FEET MINIMUM	19.9 FEET
SIDE YARD	20 FEET MINIMUM	O FEET
	30 FEET ABUTTING A RESIDENTIAL DISTRICT	N/A
REAR YARD	GREATER OF 35' OR 30% OF LOT DEPTH	O FEET
IMPERVIOUS SURFACES	70% MAXIMUM	8,140 SF (81.40%)
BUILDING HEIGHT	35 FEET MAX	<35 FEET `

ZONING COMPLIANCE TABULATION - PARCEL B:

<u>ITEM</u>	REQUIREMENT	EXISTING
LOT AREA	20,000 SF MIN.	27,000 SF GROSS
		23,733 SF NET OF R/W
LOT WIDTH	100 FEET AT BUILDING LINE	160 FEET
BUILDING COVERAGE	30% MAXIMUM	9,013 SF (33.38%)
FRONT YARD	15 FEET MINIMUM	19.85 FEET
SIDE YARD	20 FEET MINIMUM	0.5 FEET
	30 FEET ABUTTING A RESIDENTIAL DISTRICT	N/A
REAR YARD	GREATER OF 35' OR 30% OF LOT DEPTH	21.7 FEET
IMPERVIOUS SURFACES	70% MAXIMUM	20,039 SF (81.63%)
BUILDING HEIGHT	35 FFFT MAX	<35 FFFT

ZONING COMPLIANCE TABULATION - COMBINED PARCELS C & E:

<u>ITEM</u> LOT AREA	REQUIREMENT 20,000 SF MIN.	EXISTING 156,116 SF GROSS 152,175 SF NET OF R/W
LOT WIDTH	100 FEET AT BUILDING LINE	100+ FEET
BUILDING COVERAGE	30% MAXIMUM	21,699 SF (13.90%)
FRONT YARD	15 FEET MINIMUM	76 FEET
SIDE YARD	20 FEET MINIMUM	16.8 FEET
	30 FEET ABUTTING A RESIDENTIAL DISTRICT	63 FEET
REAR YARD	GREATER OF 35' OR 30% OF LOT DEPTH	116 FEET
IMPERVIOUS SURFACES	70% MAXIMUM	105,399 SF (67.51%)
BUILDING HEIGHT	35 FEET MAX	<35 FEET

ZONING COMPLIANCE TABULATION - PARCEL D:

<u>ITEM</u>	REQUIREMENT	EXISTING
LOT AREA	20,000 SF MIN.	150,460 SF GROSS
		140,057 SF NET OF R/V
LOT WIDTH	100 FEET AT BUILDING LINE	100+ FEET
BUILDING COVERAGE	30% MAXIMUM	25,948 SF (17.25%)
FRONT YARD	15 FEET MINIMUM	23.7 FEET `
SIDE YARD	20 FEET MINIMUM	1.5 FEET
	30 FEET ABUTTING A RESIDENTIAL DISTRICT	N/A
REAR YARD	GREATER OF 35' OR 30% OF LOT DEPTH	13.8 FEET
IMPERVIOUS SURFACES	70% MAXIMUM	112,700 SF (74.89%)
BUILDING HEIGHT	35 FEET MAX	<35 FEET ` `

70NING COMPLIANCE TABULATION — PARCEL F:

	ZONING COMPLIANCE TABULATION - PARCEL F.				
<u>ITEM</u>		REQUIREMENT	EXISTING		
	LOT AREA	20,000 SF MIN.	25,000 SF GROSS		
			21,370 SF NET OF R/W		
	LOT WIDTH	100 FEET AT BUILDING LINE	100+ FEET		
	BUILDING COVERAGE	30% MAXIMUM	3,557 SF (14.23%)		
	FRONT YARD	15 FEET MINIMUM	23.5 FEET		
	SIDE YARD	20 FEET MINIMUM	O FEET		
		30 FEET ABUTTING A RESIDENTIAL DISTRICT	N/A		
	REAR YARD	GREATER OF 35' OR 30% OF LOT DEPTH	O FEET		
	IMPERVIOUS SURFACES	70% MAXIMUM	15,412 SF (61.65%)		
	BUILDING HEIGHT	35 FEET MAX	<35 FEET		


ZONING COMPLIANCE TABULATION - COMBINED PARCELS A, B, C, D, E & F:


35 FEET MAX

BUILDING HEIGHT

<u>ITEM</u>	REQUIREMENT	EXISTING	PROPOSED
LOT AREA	20,000 SF MIN.	368,576 SF GROSS	368,576 SF GROSS
		345,883 SF NET OF R/W	345,883 SF NET OF R/W
LOT WIDTH	100 FEET AT BUILDING LINE	100+ FEET	100+ FEET
BUILDING COVERAGE	30% MAXIMUM	66,123 SF (17.94%)	66,712 SF (18.10%)
FRONT YARD	15 FEET MINIMUM	19.85 FEET	19.85 FEET
SIDE YARD	20 FEET MINIMUM	0.5 FEET	0.5 FEET
	30 FEET ABUTTING A RESIDENTIAL DISTRICT	63 FEET	63 FEET
REAR YARD	GREATER OF 35' OR 30% OF LOT DEPTH	116 FEET	116 FEET
IMPERVIOUS SURFACES	70% MAXIMUM	263,147 SF (71.40%)	262,709 S.F. (71.28%)



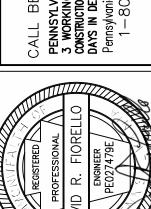


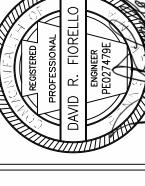



INC.

ASSOCIATES, AND LAND SURVE MOMENEE

163 EAGLE ROAD NSHIP * DELAWARE COUNTY * PENNSYLVANIA	OWNER/APPLICANT	VILLAGE ASSOCIATES 503 W. LANCASTER AVENUE, SUITE 240	
163		DRF	DRF

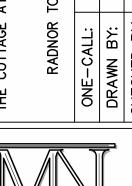

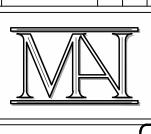


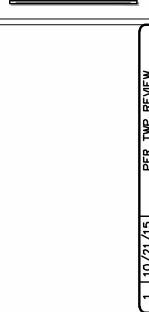


DATE: AUGUST 7, 2015 SHEET NO. OF 7

SCALE: 1" = 50"FILE NO.: 13-345

NOT TO EXCEED 35'

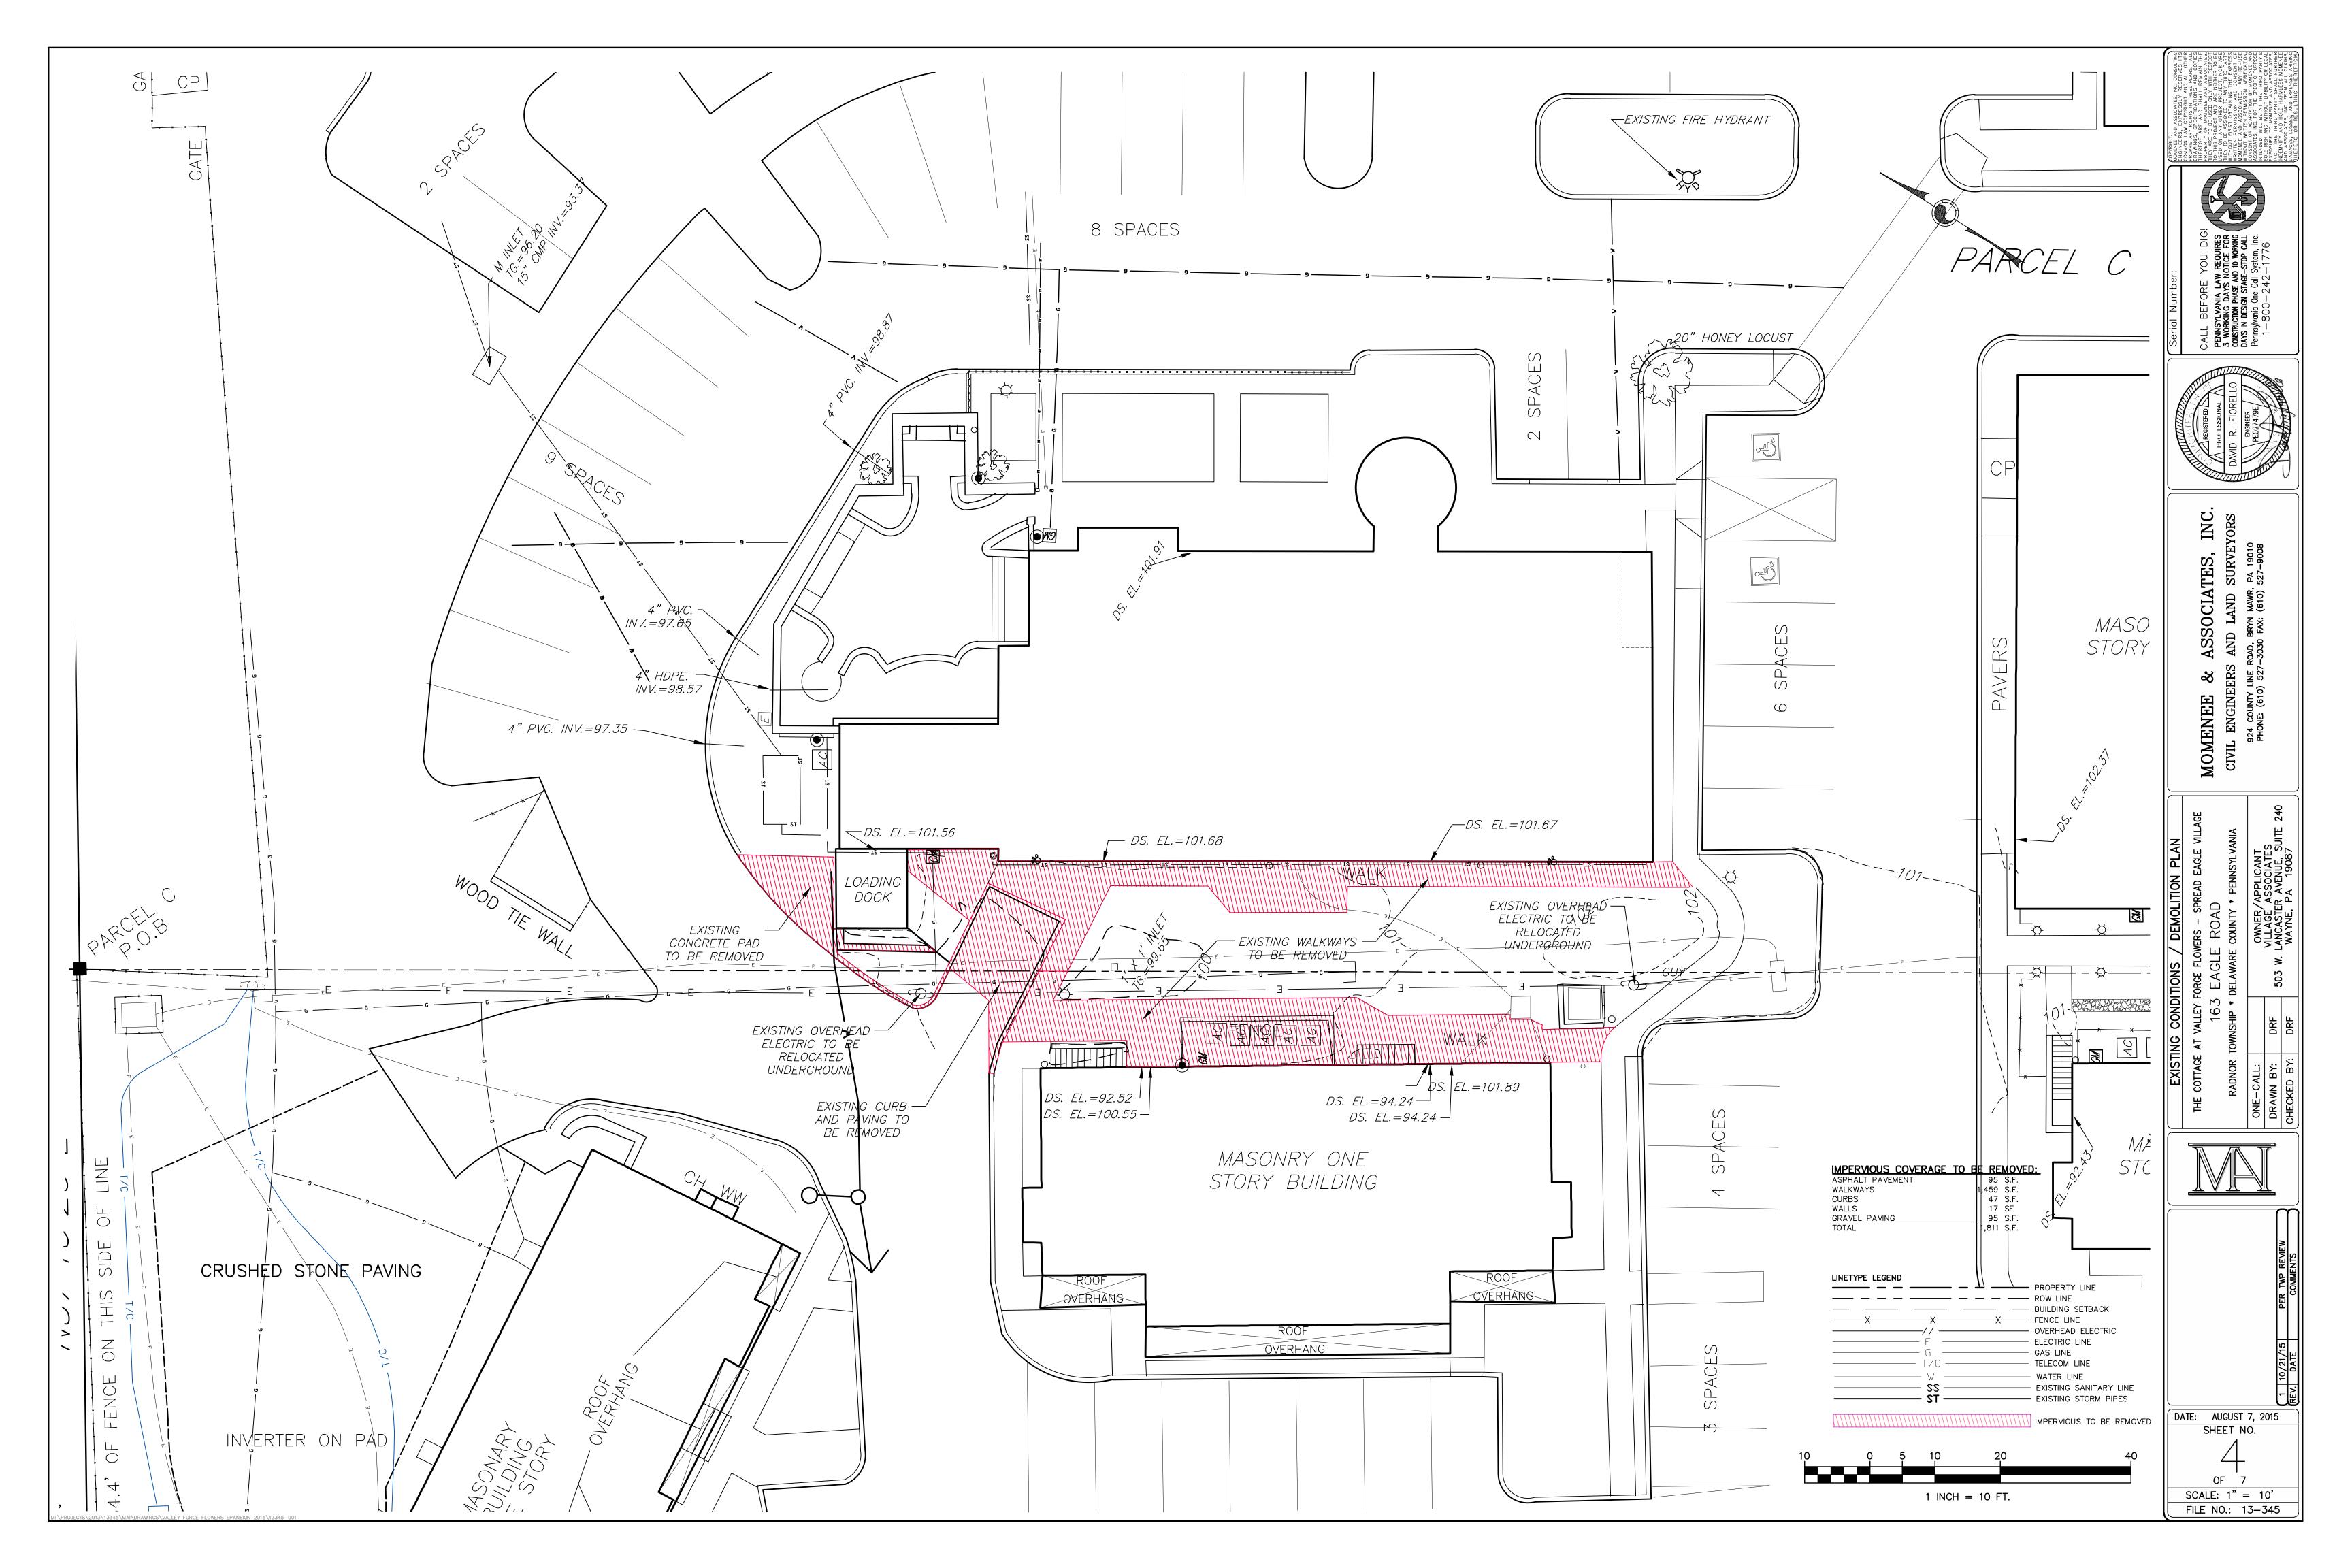

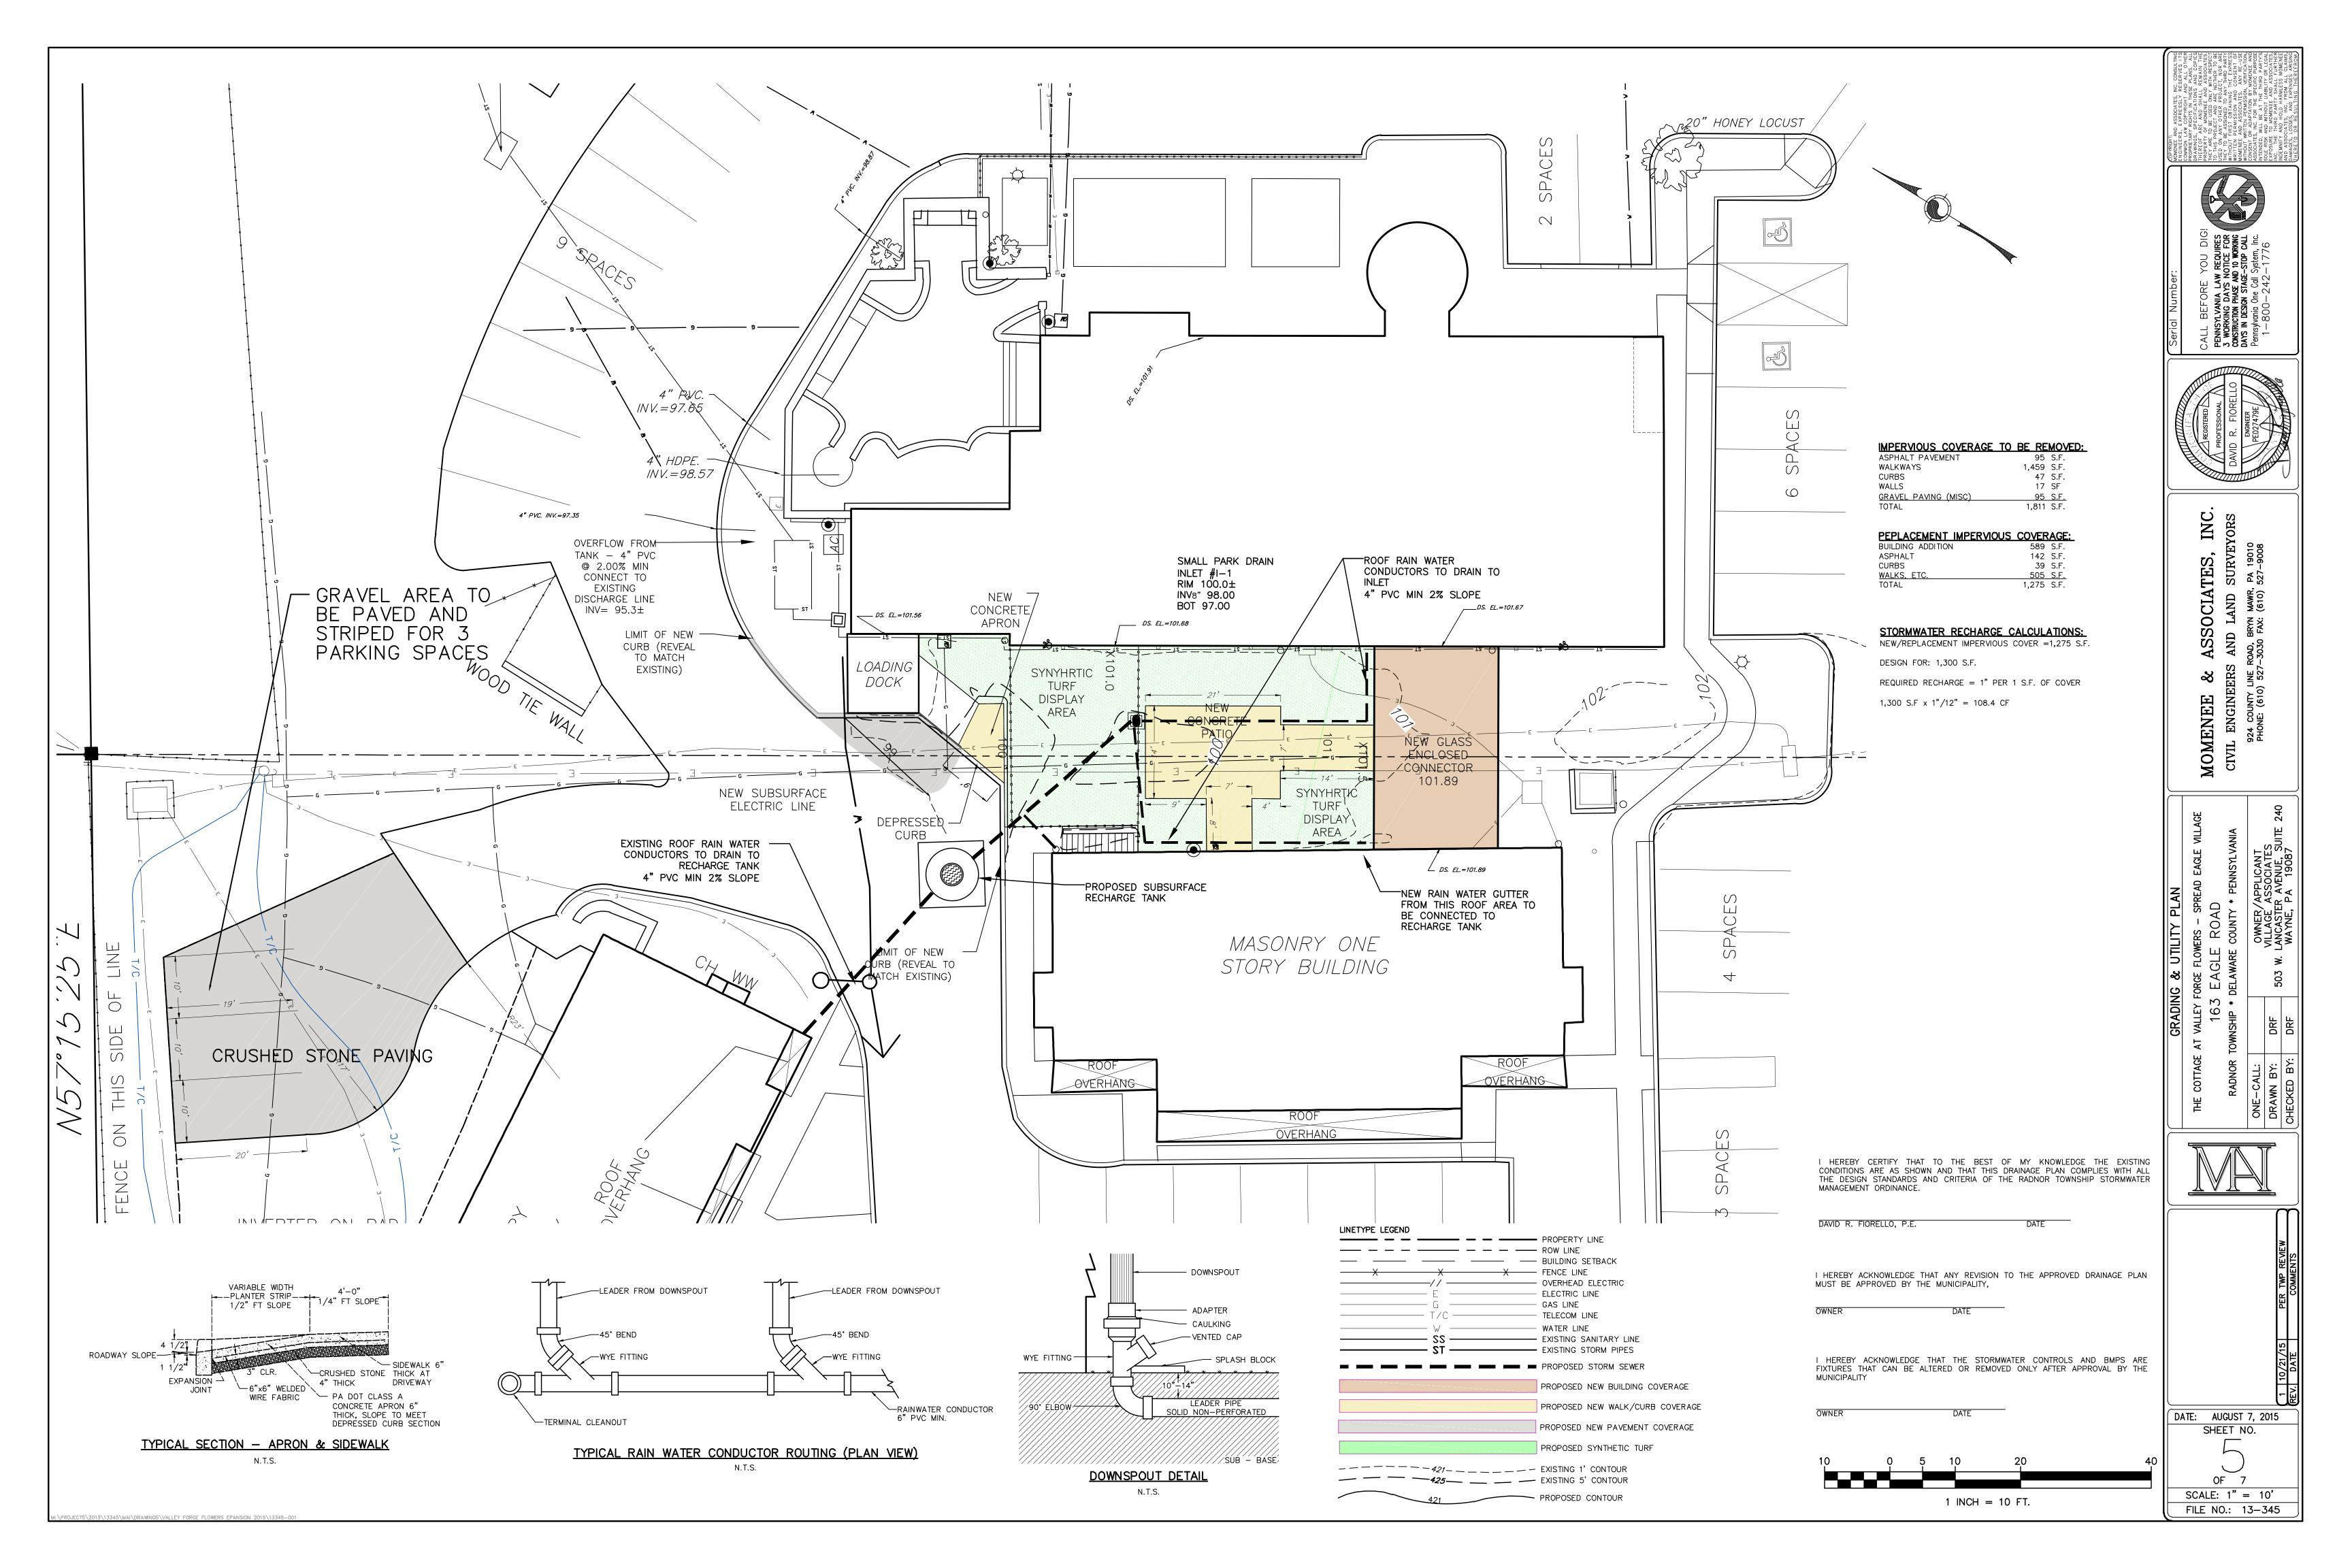



A ROUTINE "END OF DAY CHECK" SHALL BE MADE DURING CONSTRUCTION TO MAKE SURE THAT ALL CONTROL MEASURES ARE WORKING PROPERLY. ALL PERSONS ENGAGED. IN LAND DISTURBANCE ACTIVITIES SHALL PREVENT ACCELERATED EROSION AND SEDIMENTATION. THERE SHALL BE NO ADVERSE DISCHARGE OF THE SEDIMENT OR OTHER SOLID MATERIALS FROM THE SITE AS A RESULT OF STORMWATER RUNOFF.

UNTIL THE SITE IS STABILIZED, ALL EROSION AND SEDIMENTATION MUST BE MAINTAINED PROPERLY. MAINTENANCE MUST INCLUDE INSPECTIONS OF ALL EROSION AND SEDIMENTATION CONTROLS AND STOCKPILES AFTER EACH RUNOFF EVENT AND ON A WEEKLY BASIS. ALL PREVENTATIVE AND REMEDIAL MAINTENANCE WORK, INCLUDING CLEAN OUT. REPAIR. REPLACEMENT. REGRADING, RESEEDING, REMULCHING, RENETTING AND STOCKPILE COVERING MUST BE PERFORMED IMMEDIATELY.

1. STABILIZED CONSTRUCTION ENTRANCE: THE STABILIZED CONSTRUCTION ENTRANCES ARE TO BE CONSTRUCTED PER THE DETAIL. THICKNESS WILL BE CONSTANTLY MAINTAINED TO THE SPECIFIED DIMENSIONS BY ADDING ROCK. A STOCKPILE OF ROCK MATERIAL WILL BE MAINTAINED ON THE SITE FOR THIS PURPOSE. AT THE END OF EACH CONSTRUCTION DAY, ALL SEDIMENT DEPOSITED ON PUBLIC ROADWAYS WILL BE REMOVED AND RETURNED TO THE CONSTRUCTION SITE.

2. SILT FENCE: SILT FENCE SHALL BE INSTALLED PER THE DETAIL. SEDIMENT SHALL BE REMOVED FROM SILT FENCES WHEN IT REACHES 1/2 THE FENCE HEIGHT OR AS DIRECTED BY THE CONSERVATION DISTRICT OR TOWNSHIP ENGINEER. SILT FENCING WHICH HAS BEEN UNDERMINED OR TOPPED WILL BE REPLACED WITH ROCK FILTER OUTLETS IMMEDIATELY.

3. ROCK FILTER OUTLETS: ROCK FILTER OUTLETS SHALL BE INSTALLED PER THE DETAIL. SEDIMENT SHALL BE REMOVED FROM BEHIND ROCK FILTER OUTLET AFTER EACH STORM EVENT. WHEN STONE BECOMES CLOGGED WITH SEDIMENT, THE ROCK FILTER OUTLET SHALL BE REPLACED WITH CLEAN STONE.

4. INLET PROTECTION: INLET PROTECTION SHALL BE CONSTRUCTED PER THE DETAIL AND CLEANED AFTER EACH STORM EVENT OR AS DIRECTED BY THE CONSERVATION DISTRICT OR TOWNSHIP ENGINEER.


5. SWALES: ALL SWALES MUST BE TEMPORARY LINED WITH CURLEX TO ALLOW VEGETATION TO ESTABLISH. IF VEGETATION CAN NOT GROW THEN THAT AREA MUST BE

6. SEDIMENT DISPOSAL: SILT REMOVED FROM TEMPORARY SEDIMENT CONTROL STRUCTURES SHALL BE DISPOSED OF ON-SITE IN LANDSCAPED AREAS LOCATED OUTSIDE OF FLOOD PLAINS, WETLANDS, STEEP SLOPES AND DRAINAGE SWALES.

7. DUST CONTROL: DUST AND OTHER PARTICLES SHALL BE KEPT WITHIN TOLERABLE LIMITS BY USING WATER OR OTHER APPROVED DUST CONTROL AGENT. APPLICATION SHALL BE AS NEEDED OR AS DIRECTED BY THE TOWNSHIP ENGINEER OR THE CONSERVATION DISTRICT. USE OF CALCIUM CHLORIDE OR OTHER SIMILAR APPROVED AGENTS SHALL BE LIMITED TO ONLY THOSE PARTICULAR SITUATIONS IN WHICH PERIODIC CLEANING AND/OR WETTING IS NOT FEASIBLE DUE TO CONDITIONS CAUSED BY WEATHER,

TRAFFIC, ETC.

8. AIR POLLUTION: BURNING OF TREES, STUMPS, CUTTINGS, AND OTHER PERISHABLE MATERIALS WILL NOT BE PERMITTED UNLESS SPECIFICALLY ALLOWED BY THE MUNICIPALITY. THE PROVISIONS OF THE PENNSYLVANIA AIR POLLUTION CONTROL ACT, JANUARY 8, 1990, AS AMENDED TO DATE, WILL GOVERN AND AREA A PART OF THIS

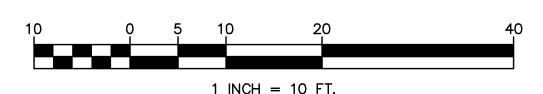

- 1. GEOTEXTILE FABRIC SHALL BE CLASS 1. GEOTEXTILE FABRIC IN ACCORDANCE WITH PENNDOT SPECIFICATION FORM 408. THE TYPE AND/OR THICKNESS SHALL BE DUPONT TYPAR #3401, AMOCO PROPEX #4545 OR APPROVED EQUAL OR AS OTHERWISE INDICATED ON THE PLAN.
- 2. TO ALL AREA WHICH REMAIN DISTURBED FOR MORE THAN 20 DAYS AND WILL BE SUBJECT TO THE ACTION OF EARTHMOVING AND OTHER EQUIPMENT, APPLY A MULCH (WOODCHIP-20 TONS PER ACRE; HAY OR STRAW-3 TONS PER ACRE). ALL OTHER DISTURBED AREAS REMAINING OPEN FOR MORE THAN 20 DAYS SHALL BE TEMPORARILY SEEDED AND MULCHED.
- 3. SHOULD UNFORESEEN EROSIVE CONDITIONS DEVELOP DURING CONSTRUCTION, THE CONTRACTOR SHALL TAKE ACTION TO REMEDY SUCH CONDITIONS AND TO PREVENT DAMAGE TO ADJACENT PROPERTIES AS A RESULT OF INCREASED RUNOFF/AND OR SEDIMENT DISPLACEMENT. STOCKPILES OF WOODCHIPS, HAY BALES, CRUSHED STONE AND OTHER MULCHES SHALL BE HELD IN READINESS TO DEAL IMMEDIATELY WITH EMERGENCY PROBLEMS OF EROSION.
- 4. THE CONTRACTOR SHALL, BY SCHEDULING THE CONSTRUCTION, UTILIZE NEW PLANTINGS AND PROPERLY INSTALL EROSION CONTROL FENCING, HAY BALES AND OTHER EROSION CONTROL MEASURES TO MINIMIZE EROSION DAMAGE.
- 5. ANY DISTURBED AREA ON WHICH ACTIVITY HAS CEASED AND WHICH WILL REMAIN EXPOSED FOR MORE THAN 20 DAYS MUST BE SEEDED AND MULCHED IMMEDIATELY. DURING NON-GERMINATING PERIODS, MULCH MUST BE APPLIED AT THE RECOMMENDED RATES. DISTURBED AREAS WHICH ARE NOT AT FINISHED GRADE AND WHICH WILL BE REDISTURBED WITHIN ONE YEAR MAY BE SEEDED AND MULCHED WITH A QUICK GROWING TEMPORARY SEEDING MIXTURE AND MULCH. DISTURBED AREAS WHICH ARE EITHER AT FINISHED GRADE OR WILL NOT BE REDISTURBED WITHIN ONE YEAR MUST BE SEEDED AND MULCHED WITH A PERMANENT SEED MIXTURE AND MULCH. DIVERSIONS, CHANNELS, SEDIMENTATION BASINS, SEDIMENT TRAPS, AND STOCKPILES MUST BE SEEDED AND MULCHED IMMEDIATELY.
- 6. A ROUTINE "END-OF-DAY-CHECK" SHALL BE MADE DURING CONSTRUCTION TO MAKE SURE THAT ALL CONTROL MEASURES ARE WORKING PROPERLY. ALL PERSONS ENGAGED IN LAND DISTURBANCE ACTIVITIES SHALL DESIGN, IMPLEMENT, AND MAINTAIN CONTROL MEASURES WHICH PREVENT ACCELERATED EROSION AND SEDIMENTATION. THERE SHALL BE NO ADVERSE DISCHARGE OF THE SEDIMENT OR OTHER SOLID MATERIALS FROM THE SITE AS THE RESULT OF STORMWATER RUNOFF.
- 7. TEMPORARY EROSION CONTROL MEASURES MAY BE REMOVED ONLY AFTER THE CONSTRUCTION AREA AND CONTAINED SILT IS STABILIZED AND THE LAWN AREA ESTABLISHED.
- 8. ALL PERSONS ENTERING ACTIVE TANKS, MANHOLES, INLETS, ETC. MUST COMPLY WITH OSHA REQUIREMENTS FOR ENTRY INTO CONFINED SPACES.


A GENERAL EASEMENT IS HEREBY CREATED OVER THE STORMWATER MANAGEMENT SYSTEMS THAT PERMITS INGRESS AND EGRESS BY RADNOR TOWNSHIP.

NO PERSON SHALL MODIFY, REMOVE, FILL, LANDSCAPE, OR ALTER ANY EXISTING STORMWATER CONTROL OR BMP, UNLESS IT IS PART OF AN APPROVED MAINTENANCE PROGRAM, WITHOUT THE WRITTEN APPROVAL OF THE MUNICIPALITY.

NO PERSON SHALL PLACE ANY STRUCTURE, FILL, LANDSCAPING, OR VEGETATION INTO A STORMWATER CONTROL OR BMP OR WITHIN A DRAINAGE EASEMENT WHICH WOULD LIMIT OR ALTER THE FUNCTIONING OF THE STORMWATER CONTROL OR BMP WITHOUT THE WRITTEN APPROVAL OF THE MUNICIPALITY.

CONSTRUCTION TIMING AND SEQUENCE:

- 1. NOTIFY THE TOWNSHIP THAT CONSTRUCTION IS GOING TO COMMENCE AND SCHEDULE A PRE-CONSTRUCTION MEETING. ANTICIPATED DATE: DECEMBER 2015.
- 2. INSTALL TREE PROTECTION / CONSTRUCTION FENCING AS INDICATED ON PLAN. FENCING MUST BE IN PLACE AND APPROVED PRIOR TO ANY DISTURBANCE. ALL DISTURBANCE SHALL BE CONTAINED TO THE DELINEATED LIMIT OF CONSTRUCTION.
- 3. IT IS ANTICIPATED THAT CONSTRUCTION ACTIVITIES WILL BE ISOLATED AND MINIMIZED SO THAT MINIMUM EROSION CONTROLS ARE NECESSARY. CONTRACTOR SHALL STOCKPILE AMPLE SEDIMENT BARRIERS WHICH SHALL BE INSTALLED AS NEEDED THROUGHOUT THE ENTIRE PROJECT.
- 4. BEGIN DEMOLITION AND REMOVAL OF THE PORTIONS OF EXISTING SIDEWALK, CURBING AND PAVEMENT NECESSARY FOR THE CONSTRUCTION OF FOUNDATIONS FOR THE BUILDING ADDITION. ALL CONSTRUCTION DEBRIS SHALL BE REMOVED FROM THE SITE AND DISPOSED OF IN AN
- 5. UPON COMPLETION OF BUILDING DEMOLITION, AND EXISTING FEATURE REMOVAL, CLEAR AND GRUB THE AREA WITHIN THE LIMITS OF NEW BUILDING CONSTRUCTION OF EXISTING VEGETATION. STRIP TOPSOIL AND STOCKPILE SUITABLE MATERIAL FOR FUTURE USE. UNSUITABLE MATERIAL SHALL BE DISPOSED OF PROPERLY. SURROUND STOCKPILE WITH SILT FENCE. TEMPORARILY SEED, MULCH, ETC. ALL STOCKPILED MATERIAL PER THE TEMPORARY SEEDING SPECIFICATIONS. MAINTAIN PORTIONS OF PAVING AND SIDEWALL IN CONSTRUCTION AREA TO MINIMIZE DISTURBANCE.
- 6. RELOCATE EXISTING OVERHEAD ELECTRIC SERVICE AND INSTALL NECESSARY UTILITY CONNECTIONS TO BUILDING LINK
- 7. EXCAVATE AND CONSTRUCT FOUNDATIONS FOR NEW BUILDING ADDITION.
- 8. BACKFILL FOUNDATIONS AND CONTINUE WITH BUILDING CONSTRUCTION.
- 9. UNTIL THE SITE IS STABILIZED, ALL EROSION AND SEDIMENTATION CONTROLS MUST BE MAINTAINED PROPERLY. MAINTENANCE MUST INCLUDE INSPECTIONS OF ALL EROSION AND SEDIMENTATION CONTROLS AFTER EACH RUNOFF EVENT AND ON A WEEKLY BASIS. ALL PREVENTATIVE AND REMEDIAL MAINTENANCE WORK: INCLUDING CLEAN OUT, REPAIR, REPLACEMENT, REGRADING, RESEEDING, REMULCHING, AND RENETTING MUST BE PERFORMED IMMEDIATELY.
- 10. CONCURRENT WITH BUILDING CONSTRUCTION, REMOVE REMAINDER OF WALKWAY AND PAVEMENT REMOVALS. ALL CONSTRUCTION DEBRIS SHALL BE REMOVED FROM THE SITE AND DISPOSED OF IN AN APPROVED MANNER.
- 11. EXCAVATE FOR AND INSTALL RAINWATER RECHARGE TANK, RAINWATER CONDUCTOR PIPING AND WATER DISTRIBUTION SYSTEM.
- 12. INSTALL NEW CURBING, AND PERIMETER SIDEWALKS.
- 13. GRADE COURTYARD AREA AND INSTALL DRAINAGE COLLECTION FACILITIES AND SYNTHETIC TURF BASE DRAIN.
- 14. INSTALL GRAVEL BASE FOR PATIO AND TURF AREAS. INSTALL PATIO PAVING.
- 15. INSTALL SYNTHETIC TURF PER MANUFACTURERS RECOMMENDATIONS.
- 16. FINAL GRADE REMAINING AREAS DENUDED DURING CONSTRUCTION, SPREAD STOCKPILED TOPSOIL AND SEED GRADED AREAS TO REESTABLISH PERMANENT VEGETATION. STABILIZE SLOPES IN EXCESS OF 4:1 WITH SOD OR EROSION CONTROL NETTING AND MULCH.
- 17. INSTALL THE HARDSCAPE AND LANDSCAPE FEATURES AND REMOVE MATERIALS NOT REQUIRED FOR FINAL CONSTRUCTION. DISPOSAL OF DISCARDED MATERIALS SHALL BE IN AN APPROVED MANNER. 18. INSTALL FINAL PAVING, SIGNAGE AND LINE STRIPING.
- 19. IMMEDIATELY SEED AND STABILIZE ANY AREAS DENUDED BY REMOVAL OF SEDIMENT BARRIERS. 20. COMPLETE CONSTRUCTION: ANTICIPATED DATE: SPRING 2015.

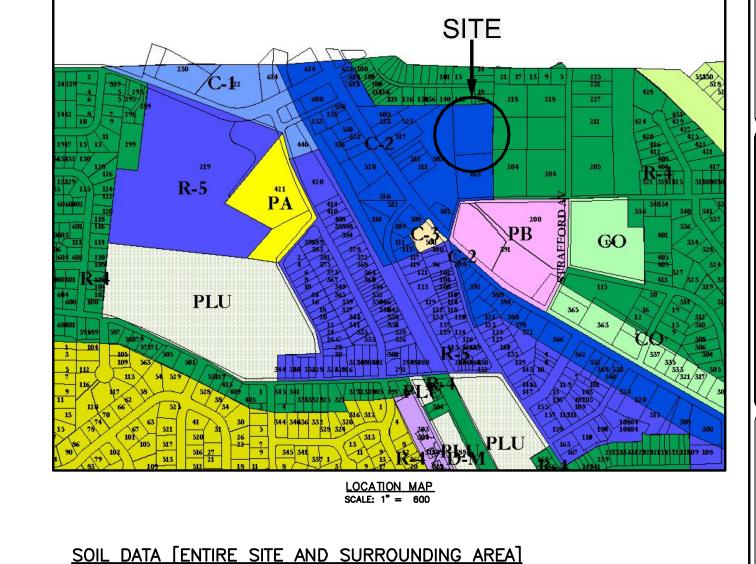


MADFI AND	0-8 	 3+	4+		 - R	
NAME	% SLOPE	S. H. WATER	TO BEDROCK	FROD	GROUP	SOIL LIMITATIONS
		TO	DEPTH			HYDRO


DISTURBED AREA = $4.500 \text{ SF} \pm$


EROSION AND SEDIMENT CONTROL NOTES:

- 1. STOCKPILE HEIGHTS MUST NOT EXCEED 35 FEET. STOCKPILE SLOPES MUST BE 2:1 OR FLATTER.
- 2. THE OPERATOR SHALL ASSURE THAT THE APPROVED EROSION AND SEDIMENT CONTROL PLAN IS PROPERLY AND COMPLETELY
- 3. UNTIL THE SITE ACHIEVES FINAL STABILIZATION, THE OPERATOR SHALL ASSURE THAT THE BEST MANAGEMENT PRACTICES ARE IMPLEMENTED, OPERATED, AND MAINTAINED PROPERLY AND COMPLETELY, MAINTENANCE SHALL INCLUDE INSPECTIONS OF ALL BEST MANAGEMENT PRACTICE FACILITIES. THE OPERATOR SHALL MAINTAIN AND MAKE AVAILABLE TO DELAWARE COUNTY CONSERVATION DISTRICT COMPLETE, WRITTEN INSPECTION LOGS OF ALL THOSE INSPECTIONS. ALL MAINTENANCE WORK, INCLUDING CLEANING, REPAIR, REPLACEMENT, REGRADING, AND RESTABILIZATION SHALL BE PERFORMED IMMEDIATELY.
- 4. IMMEDIATELY UPON DISCOVERING UNFORESEEN CIRCUMSTANCES POSING THE POTENTIAL FOR ACCELERATED EROSION AND/OR SEDIMENT POLLUTION, THE OPERATOR SHALL IMPLEMENT APPROPRIATE BEST MANAGEMENT PRACTICES TO ELIMINATE POTENTIAL FOR ACCELERATED EROSION AND/OR SEDIMENT POLLUTION
- 5. THE OPERATOR SHALL ASSURE THAT AN EROSION AND SEDIMENT CONTROL PLAN HAS BEEN PREPARED, APPROVED BY THE TOWNSHIP, AND IS BEING IMPLEMENTED AND MAINTAINED FOR ALL SOIL AND/OR ROCK SPOIL AND BORROW AREAS, REGARDLESS OF
- 6. ALL PUMPING OF SEDIMENT LADEN WATER SHALL BE THROUGH A SEDIMENT CONTROL BMP, SUCH AS A PUMPED WATER FILTER BAG DISCHARGING OVER NON-DISTURBED AREAS.
- 7. THE OPERATOR IS ADVISED TO BECOME THOROUGHLY FAMILIAR WITH THE PROVISIONS OF THE APPENDIX 64. EROSION CONTROL RULES AND REGULATIONS, TITLE 25, PART 1, DEPARTMENT OF ENVIRONMENTAL PROTECTION, SUBPART C, PROTECTION OF NATURAL RESOURCES, ARTICLE III, WATER RESOURCES, CHAPTER 102, EROSION CONTROL
- 8. A COPY OF THE APPROVED EROSION AND SEDIMENT CONTROL PLAN MUST BE AVAILABLE AT THE PROJECT SITE AT ALL TIMES.
- 9. EROSION AND SEDIMENT BMP'S MUST BE CONSTRUCTED, STABILIZED, AND FUNCTIONAL BEFORE SITE DISTURBANCE BEGINS WITHIN THE TRIBUTARY AREAS OF THOSE BMP'S.
- 10. AFTER FINAL SITE STABILIZATION HAS BEEN ACHIEVED, TEMPORARY EROSION AND SEDIMENT BMP CONTROLS MUST BE REMOVED. AREAS DISTURBED DURING REMOVAL OF THE BMP'S MUST BE STABILIZED IMMEDIATELY.
- 11. SEDIMENT MUST BE REMOVED FROM STORM WATER INLET PROTECTION AFTER EACH RUNOFF EVENT.
- 12. HAY OR STRAW MULCH MUST BE APPLIED AT 3.0 TONS PER ACRE.
- 13. STRAW MULCH SHALL BE APPLIED IN LONG STRANDS, NOT CHOPPED OR FINELY BROKEN.
- 14. UNTIL THE SITE IS STABILIZED. ALL EROSION AND SEDIMENT BMP'S MUST BE MAINTAINED PROPERLY. MAINTENANCE MUST INCLUDE INSPECTIONS OF ALL EROSION AND SEDIMENT CONTROL BMPS AFTER EACH RUNOFF EVENT AND ON A WEEKLY BASIS. ALL PREVENTATIVE AND REMEDIAL MAINTENANCE WORK, INCLUDING CLEAN OUT, REPAIR, REPLACEMENT, REGARDING, RESEEDING REMULCHING, AND RENETTING, MUST BE PERFORMED IMMEDIATELY, IF EROSION AND SEDIMENT CONTROL BMPS FAIL TO PERFORM AS EXPECTED, REPLACEMENT BMPS, OR MODIFICATIONS OF THOSE INSTALLED WILL BE REQUIRED.
- 15. SEDIMENT REMOVED FROM BMPS SHALL BE DISPOSED OF IN LANDSCAPED AREAS OUTSIDE OF STEEP SLOPES, WETLANDS, FLOODPLAINS OR DRAINAGE SWALES AND IMMEDIATELY STABILIZED, OR PLACED IN TOPSOIL STOCKPILES.
- 16. THE OPERATOR SHALL REMOVE FROM THE SITE, RECYCLE, OR DISPOSE OF ALL BUILDING MATERIALS AND WASTE IN ACCORDANCE WITH THE DEPARTMENT'S SOLID WASTE MANAGEMENT REGULATIONS AT 25 PA. CODE 260.1 ET SEQ., 271.1 ET DEQ., AND 287.1 ET SEQ. THE CONTRACTOR SHALL NOT ILLEGALLY BURY, DUMP, OR DISCHARGE ANY BUILDING MATERIAL OR WASTES AT THE SITE.
- 17. TOPSOIL TAKEN FROM CONSTRUCTION AREAS SHALL BE SEEDED WITH VEGETATIVE COVER AND STOCKPILED FOR RE-USE IN FINISH GRADING.
- 18. CRUSHED STONE BASE COURSE TO BE PLACED ON DRIVEWAYS AS SOON AS POSSIBLE AFTER GRADING TO PREVENT EROSION OF
- 19. THE CONTRACTOR SHALL, BY SCHEDULING THE CONSTRUCTION, UTILIZE NEW PLANTINGS AND PROPERLY INSTALL EROSION CONTROL FENCING, HAY BALES AND OTHER EROSION CONTROL MEASURES TO MINIMIZE EROSION DAMAGE.
- 20. PROVIDE CONSTRUCTION FENCING AS NECESSARY TO SECURE THE CONSTRUCTION SITE FROM UNAUTHORIZED ACCESS.
- 21. GRADING AND EARTHMOVING OPERATIONS SHALL BE MINIMIZED DURING THE PERIOD FROM NOVEMBER 15 TO APRIL 1 WHEN RE-VEGETATION OF EXPOSED GROUND SURFACE IS DIFFICULT. MULCH, STRAW, STONE AND/OR SOD SHALL BE USED TO STABILIZE ALL AREAS DENUDED DURING THIS TIME PERIOD.

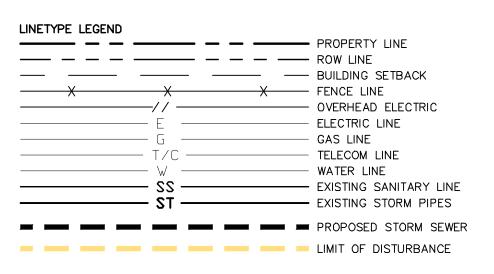




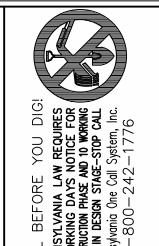


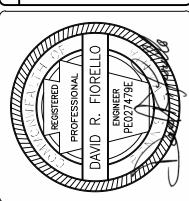

INC ASSOCIATES, MOMENEE

FLOWERS GLE RO, WARE COUNT

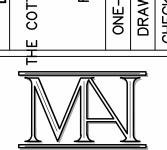

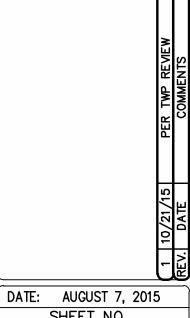

SHEET NO. OF 7 SCALE: 1" = 10"

FILE NO.: 13-345

PREPARATION OF AREAS TO BE TOPSOILED
GRADE THE AREAS TO BE COVERED BY TOPSOIL. USING ACCEPTABLE METHODS, LOOSEN SOIL TO A DEPTH OF 2 INCHES BEFORE PLACING THE TOPSOIL. REMOVE STONES AND OTHER FOREIGN MATERIAL 2 INCHES OR LARGER IN DIMENSION. REMOVE AND SATISFACTORILY DISPOSE OF UNSUITABLE AND SURPLUS MATERIAL.

PLACING AND SPREADING TOPSOIL
PLACE TOPSOIL ON THE PREPARED AREAS AND, UNLESS OTHERWISE INDICATED, SPREAD AND COMPACT TO A 4-INCH UNIFORM DEPTH ± 1 1/2 INCHES. COMPACT WITH A ROLLER WEIGHING NOT OVER 120 POUNDS PER FOOT WIDTH OF ROLLER OR BY OTHER ACCEPTABLE METHODS, AS DIRECTED. REMOVE OVERDEPTH TOPSOIL, UNLESS OTHERWISE AGREED UPON IN WRITING. DO NOT PLACE TOPSOIL IN A WET OR FROZEN CONDITION.

<u>SEEDING SPECIFICATIONS:</u> WHERE DENUDED AREAS ARE DESIRED TO BE LAWN:

- 1. PERFORM ALL CULTURAL OPERATION AT RIGHT ANGLES TO THE SLOPE. 2. APPLY LIME ACCORDING TO TEST OR AT THE RATE OF 25 LBS. OF GROUND LIMESTONE PER
- 1,000 SQ. FT. 3. APPLY FERTILIZER ACCORDING TO SOIL TEST OR WORK IN DEEPLY 20 LBS. OF 0-20-20 OR EQUIVALENT PER 1,000 SQ. FT. AND AT THE TIME OF SEEDING, WORK INTO THE SURFACE 10
- LBS. OF 10-10-10 OR EQUIVALENT PER 1,000 SQ. FT. OR OTHER APPROVED MIXTURE. 4. SMOOTH AND FIRM SEEDED PRIOR TO SEEDING.
- 5. SEED USING A MIXTURE OF 60% PENNSTAR KENTUCKY BLUEGRASS, 30% PENNLAWN RED FESCUE AND 10% PENNFINE PERENNIAL RYEGRASS AT THE RATE OF FIVE (5) POUNDS PER 1,000 SQ. FT. OR OTHER APPROVED MIXTURE.
- 6. COVER GRASS AND LEGUME SEEDS WITH 1/4" OF SOIL WITH SOIL EQUIPMENT, MULCH (RATE OF 3 TONS PER ACRE).
- 7. MOW AS REQUIRED. 8. WHERE SLOPES EXCEED 25% JUTE NETTING OR OTHER APPROVED (EQUAL) SLOPE STABILIZATION MEASURES SHALL BE UTILIZED. IN ADDITION, THE SEEDING SPECIFICATIONS FOR STEEP SLOPES SHALL BE INCREASED TO INCLUDE 3 LBS/1,000 SQ. FT. OF ANNUAL RYEGRASS FOR RAPID VEGETAL ESTABLISHMENT.

HYDROSEEDING SPECIFICATIONS:

DEFINITION: STABILIZING SEDIMENT PRODUCING AND SEVERELY ERODED AREAS BY ESTABLISHING PERMANENT GRASS COVER.


PURPOSE: TO PROVIDE PERMANENT VEGETATIVE COVER TO CONTROL RAPID RUN-OFF AND EROSION.

PROCEDURE: SURFACE TO BE HYDRO-SEEDED SHALL BE CLEANED OF ALL DEBRIS AND OTHER MATTER HARMFUL TO UNIFORM GERMINATES. A WATER-SLURRY MIXTURE COMPOSED OF THE BELOW MENTIONED "MATERIALS" SHALL BE SPRAYED UNIFORMLY OVER THE AREAS TO BE HYDRO-SEEEDED.

PERMANENT SEEDING

MATERIALS:


NAME	AME DESCRIPTION	
1) SEED MIXTURE	60% PENNSTAR KENTUCKY BLUEGRASS	
% BY WEIGHT	30% PENNLAWN RED RESCUE	130 LBS
	10% PENNFINE PERRENIAL RYEGRASS	
2) COMMERCIAL FERTILIZER	10/20/2020	1,000 LBS
3) LIME	GROUND AGRICULTURAL LIMESTONE (MAY BE APPLIED SEPARATELY)	2 TONS
4) MULCH	HAY OR STRAW	3 TONS
5) SOIL STABILIZER	TERRA TACK OR EQUIVALENT	20 LBS
TEMPORARY SEEDIN	IG	
1) SEED	ANNUAL RYEGRASS (95% PURE)	40 LBS
2) COMMERCIAL FERTILIZER	5-5-5	1,000 LBS
3) LIME	GROUND AGRICULTURAL LIMESTONE (MAY BE APPLIED SEPARATELY)	1 TON
4) MULCH	HAY OR STRAW	3 TONS

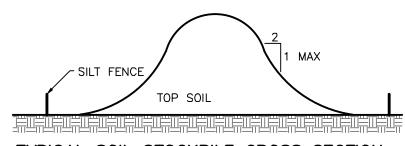

TYPICAL SOIL STOCKPILE CROSS SECTION N.T.S.


1. SILT FENCE MUST COMPLETELY ENCIRCLE STOCKPILES

2. TOPSOIL SHALL NOT BE REMOVED FROM THE DEVELOPMENT SITE OR USED AS FILL. TOPSOIL SHALL BE REMOVED FROM THE AREAS OF CONSTRUCTION AND STORED SEPARATELY THE TOPSOIL SHALL BE STABILIZED TO MINIMIZE EROSION DURING STORAGE. UPON COMPLETION OF CONSTRUCTION, THE TOPSOIL SHALL BE UNIFORMLY REDISTRIBUTED ON THE SITE.

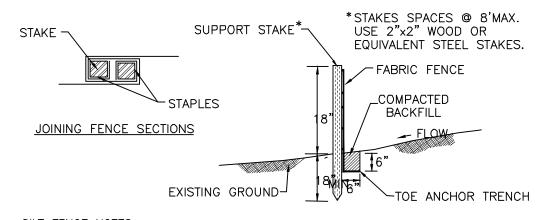


- 1. FILTER FABRIC FENCE MUST BE PLACED AT LEVEL GRADE. BOTH ENDS OF THE BARRIER MUST BE EXTENDED AT LEAST 8' UP SLOPE AT 45° TO THE MAIN
- 2. ANY SILT FENCING WHICH HAS BEEN UNDERMINED OR TOPPED MUST BE REPLACED WITH ROCK FILTER OUTLETS IMMEDIATELY. SEE ROCK FILTER OUTLET
- 3. SEDIMENT MUST BE REMOVED WHERE ACCUMULATIONS REACH 1/2 THE ABOVE GROUND HEIGHT THE FENCE.

STANDARD SILT FENCE

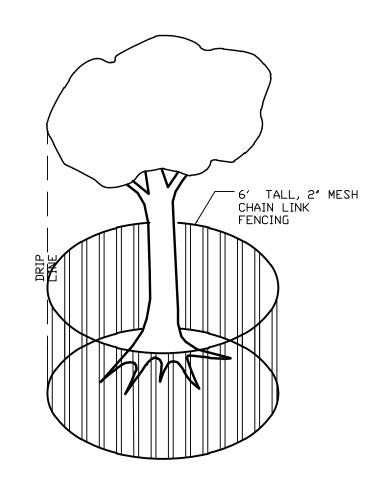


TREE PROTECTION FENCE PLACEMENT


ALL WOODY VEGETATION TO BE RETAINED WITHIN 25 FEET OF A BUILDING SITE, PARKING AREA, DRIVEWAY OR OTHER PROPOSED IMPROVEMENT SHALL BE PROTECTED FROM EQUIPMENT DAMAGE BY FENCING OR OTHER EFFECTIVE BARRIERS APPROVED BY THE TOWNSHIP ENGINEER AND/OR ARBORIST. FENCING OR BARRIERS SHALL BE PLACED AS MUCH AS IS PRACTICAL AT THE DRIPLINE. LOCATION MAY BE ALTERED TO AVOID INTERFERENCE WITH PROPOSED GRADING AND IMPROVEMENTS AS SHOWN ON THE PLANS. BARRIER LOCATION SHALL BE SUBJECT TO APPROVAL BY THE TOWNSHIP ENGINEER AND/OR ARBORIST.

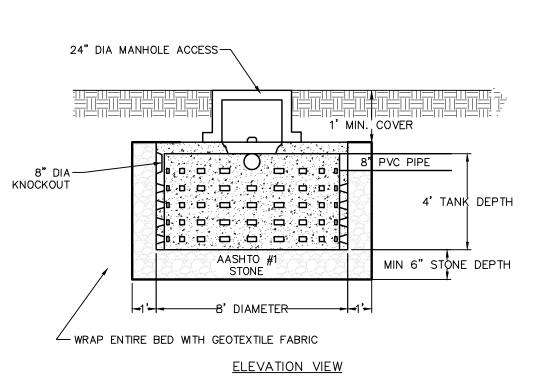

ROOF DRAINS TO BE CONNECTED TO TANKS

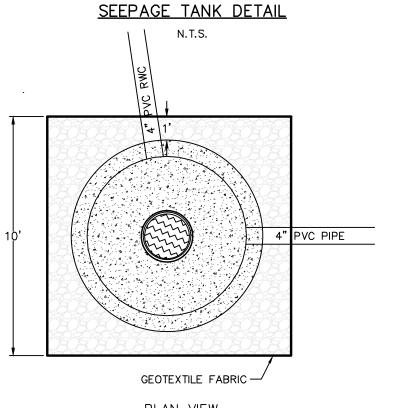

PLAN VIEW SEEPAGE TANK DETAIL

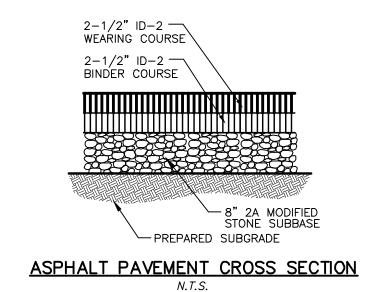

SMALL PARK GRATE DETAIL N.T.S. MANHOLE COVER DETAIL | PERMEABLE SYNTHETIC TURF PERMEABLE IFIELD EDGE ANCHOR |6"-8" FREE DRAINING STONE DEPENDING UPON TURF SYSTEM UTILIZED |TAPER SUBSOIL FROM BOTTOM OF NAILER TO - COMPACTED SUBGRADE PERFORATED PIPE] PERMEABLE

SECTION

SYNTHETIC TURF PLACEMENT DETAIL

CHAIN LINK FABRIC ATTACHED TO POSTS WITH 6 GA. WIRE TIES @ 24" O.C. MAX. TYP. ~7 GA. TENSION HEIGHT 2" LINE POST (TYP) 10' Q.Q. MAX - MIN 24" POST BASE SECTION TO BE UTILIZED ON PAVED AREAS

17**‡"**

SMALL PARK GRATE

SMALL PARK FRAME

16"

PRE-CAST CONCRETE BOX

GEOTEXTILE FABRIC

- 1. PROTECTION BARRIERS SHALL BE 6 FEET HIGH, CONSTRUCTED OF 2" CHAIN LINK MESH FABRIC.
- 2. FABRIC SHALL BE SECURED TO 2" POSTS WITH 6 GA. ALUMINUM WIRE TIES AT 24" O.C.
- 3. POSTS SHALL BE A MINIMUM OF 2 FEET IN THE GROUND AND SPACED 10 FEET ON CENTER MAX.
- 4. PLASTIC ZIP-TIES MAY NOT BE USED TO SECURE FABRIC TO POSTS.

MIN 2 EACH 1" HOLES IN

- FILTER FABRIC SURROUNDING STONE

- BOTTOM FOR DRAINAGE

- 2' AASHTO 57 STONE

SECTION VIEW


SECTION SHOWING FRAME & COVER

SMALL PARK GRATE BOX

(NON-TRAFFIC BEARING)


NOTE: PROVIDE MIN. 1' SUMP IN ALL INLETS

TREE PROTECTION BARRIER FENCING

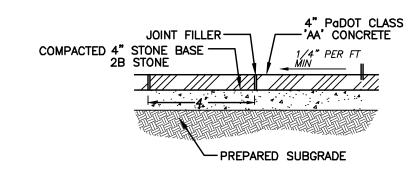



SIDEWALK/PATIO DETAIL

NOTE: THE BED FOR CONCRETE SIDEWALKS SHALL BE THOROUGHLY COMPACTED BY TAMPING AND, WHEN SO COMPACTED, SHALL BE UNIFORMLY 4 INCHES BELOW THE FINISHED SURFACE. ON THIS FOUNDATION SHALL BE CONSTRUCTED A 4 INCH, CONCRETE PAVEMENT. JOINTS SHALL BE MADE EVERY 4 FEET AND A SPACE OF 1/4 INCH TO 1/2 INCH LEFT BETWEEN BLOCKS AT EVERY TENTH JOINT AND FILLED WITH PREPARED JOINT FILLER. ALL CONCRETE SHALL BE CURED WITH THE USE OF AN APPROVED WHITE-PIGMENTED CURING COMPOUND.

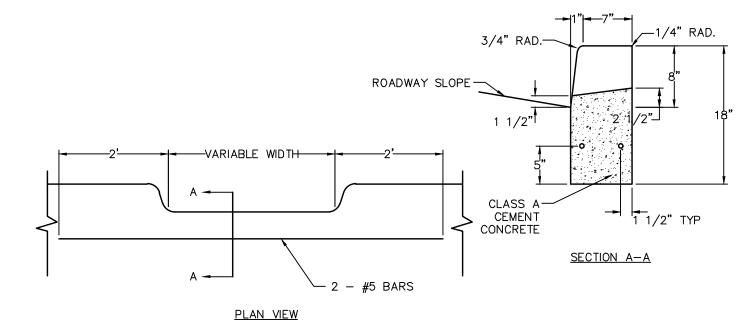

DEPRESSED CURB FOR DRIVEWAYS

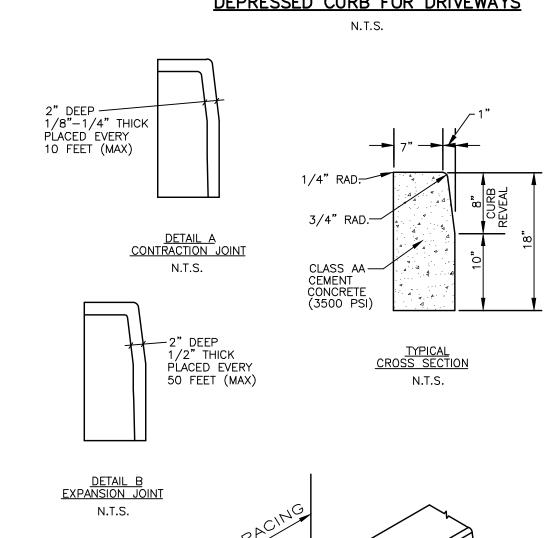

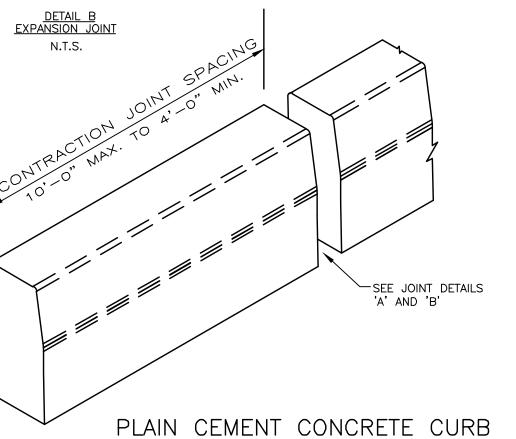


1. MATERIALS AND CONSTRUCTION SHALL MEET THE REQUIREMENTS OF PUBLICATION 408, SECTION 630 AND 640 FOR PLAIN CEMENT CONCRETE CURB.

3. PLACE 1/2" PREMOLDED EXPANSION JOINT FILLER MATERIAL AT STRUCTURES AND AT THE END OF THE WORK DAY. CUT MATERIAL TO CONFORM TO AREA ADJACENT TO CURB OR TO CONFORM TO CROSS SECTIONAL AREA OF CURB.

4. IN ACCORDANCE WITH SECTION 141.20.G.(5), CURB TO BE CONSTRUCTED IN UNIFORM LENGTHS OR BLOCKS, SEPARATED BY CONTRACTION JOINTS EVERY TEN FEET (SEE DETAIL 'A') AND EXPANSION JOINTS EVERY 50 FEET (SEE DETAIL 'B'). 5. ALL WEARING COURSE SURFACES SHALL BE SEALED TO THE CONCRETE CURB WITH A


ONE-FOOT WIDE GRADE BM-1 OR A-1 BITUMINOUS GUTTER SEAL. 6. ALL CONCRETE SHALL BE CURED WITH THE USE OF AN APPROVED WHITE-PIGMENTED CURING COMPOUND.

2. SPACE CONTRACTION JOINTS IN UNIFORM LENGTHS OR SECTIONS.

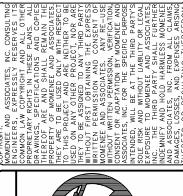






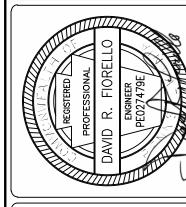

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ASSOCIATES, AND LAND SURVI MOMENEE

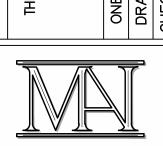

DATE: AUGUST 7, 2015

SHEET NO. OF 7 SCALE: AS NOTED FILE NO.: 13-345