SOUTH DEVON AREA FLOOD REDUCTION PROJECT

AT THE WEST WAYNE PRESERVE

AND FRIENDS OF RADNOR TRAIL PARK

RADNOR TOWNSHIP, DELAWARE COUNTY, PA

LITTLE DARBY CREEK WATERSHED

LOCATION MAP



MAP SCALE: 1:300



Sheet Number COVER SHEET C1.00 EXISTING CONDITIONS PLAN C1.10 DEMOLITION PLAN **DEMOLITION PLAN - ENLARGEMEN** C1.11 C1.20 **EROSION & SEDIMENT CONTROL NOTES** C1.21 **EROSION & SEDIMENT CONTROL PLAN** C1.22 FROSION & SEDIMENT CONSTRUCTION SEQUENCE STORMWATER & GRADING PLAN C1.30 STORMWATER & GRADING PLAN - ENLARGEMENT C1.32 STORMWATER & GRADING PLAN - ENLARGEMENT 2 C1.33 STORMWATER PROFILES - SHEET 1 STORMWATER PROFILES - SHEET 2 C1.34 PIPE AND STRUCTURE TABLES C1 35 STORMWATER & GRADING NOTES C1.36 C1.40 SITE PLAN SITE PLAN - ENLARGMENT 1 C1.41 SITE PLAN - FNLARGMENT 2 C1 42 C1.43 SITE DETAILS - SHEET 1 C1.44 SITE DETAILS - SHEET 2 C5.00 **EROSION & SEDIMENT CONTROL DETAILS - SHEET** C5.01 EROSION & SEDIMENT CONTROL DETAILS - SHEET 2 C5.02 STORMWATER DETAILS - SHEET 1 C5.03 STORMWATER DETAILS - SHEET 2 C5.04 STORMWATER DETAILS - SHEET 3 L1.0 PLANTING PLAN L1.1 PLANTING DETAILS & PLANT SCHEDULE




IT SHALL BE THE CONTRACTOR'S RESPONSIBILITY TO CONDUCT ACTIVITIES IN A CLEAN, NEAT MANNER THROUGHOUT THE CONTRACT PERIOD. ALL DEBRIS GENERATED BY THE CONTRACTOR'S ACTIVITIES SHALL BE CLEANED UP AND REMOVED FROM THE PREMISES AT THE END OF EACH WORKING DAY. IF THE CONTRACTOR FAILS TO COMPLY, THE TOWNSHIP OF RADNOR HAS THE RIGHT TO HAVE THE SITE CLEANED AT THE CONTRACTOR'S

ALL LOCATIONS OF EXISTING UTILITIES SHOWN ON THIS PLAN HAVE BEEN DEVELOPED FROM EXISTING UTILITY RECORDS AND/OR ABOVE GROUND EXAMINATION OF THE SITE. COMPLETENESS OR ACCURACY OF LOCATION AND DEPTH OF UNDERGROUND UTILITIES OR STRUCTURES CANNOT BE GUARANTEED. CONTRACTOR MUST VERIFY LOCATION AND BEFORE START OF WORK PER PENNSYLVANIA ACT 287 OF 1974 AS AMENDED BY ACT 199 OF 2004 OR LATER.





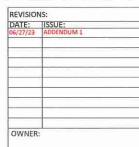

301 IVEN AVENUE WAYNE, PA 19087-5297

CIVIL ENGINEER:



MELIORA DESIGN 259 MORGAN STREET PHOENIXVILLE, PA 19460 610.933.0123 WWW.MELIORADESIGN.COM

LANDSCAPE ARCHITECT:

3868 TERRACE STREET PHILADELPHIA, PA 19128 215.482.7973 WWW.VIRIDIANL5,COM

SURVEYOR

CONTROL POINT ASSOCIATES, INC. 1500 MANOR DRIVE, SUITE 210 CHALFONT, PA 18914 215.712.9800 WWW.CPASURVEY.COM

SOUTH DEVON AREA FLOOD REDUCTION PROJECT

AT THE WEST WAYNE PRESERVE




BID DOCUMENTS


DRAWING TITLE:


COVER SHEET


AS NOTED RAWN BY: MPB


HECKED BY:

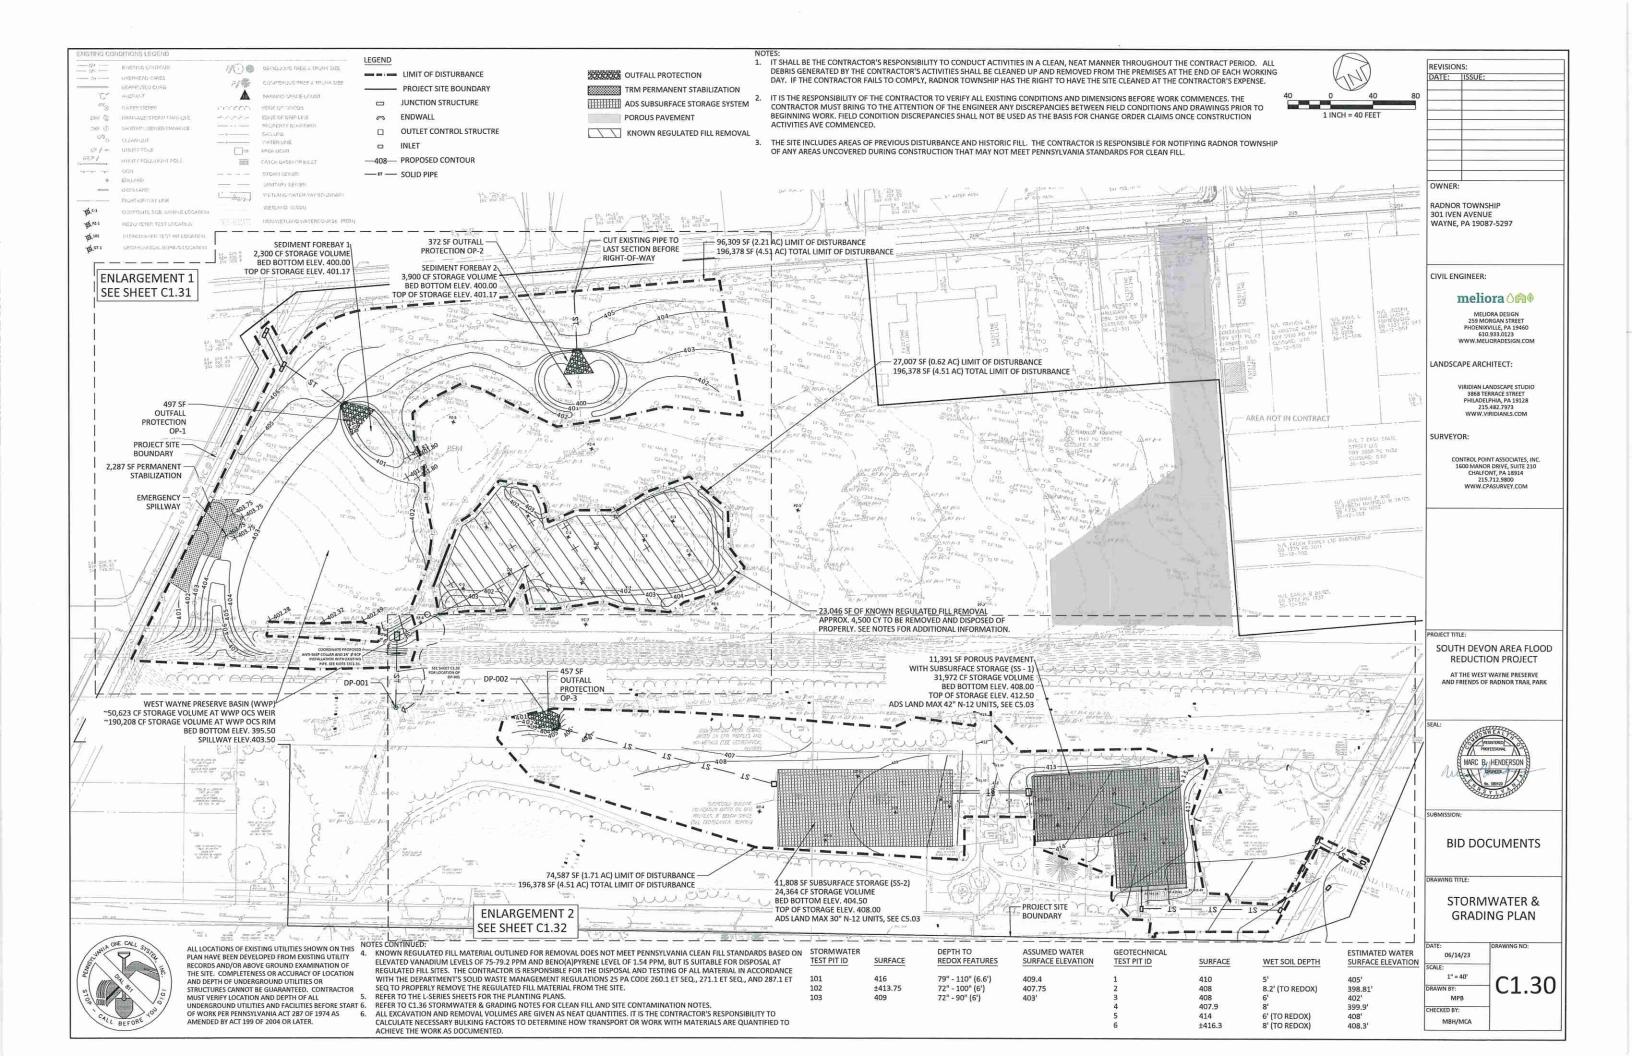


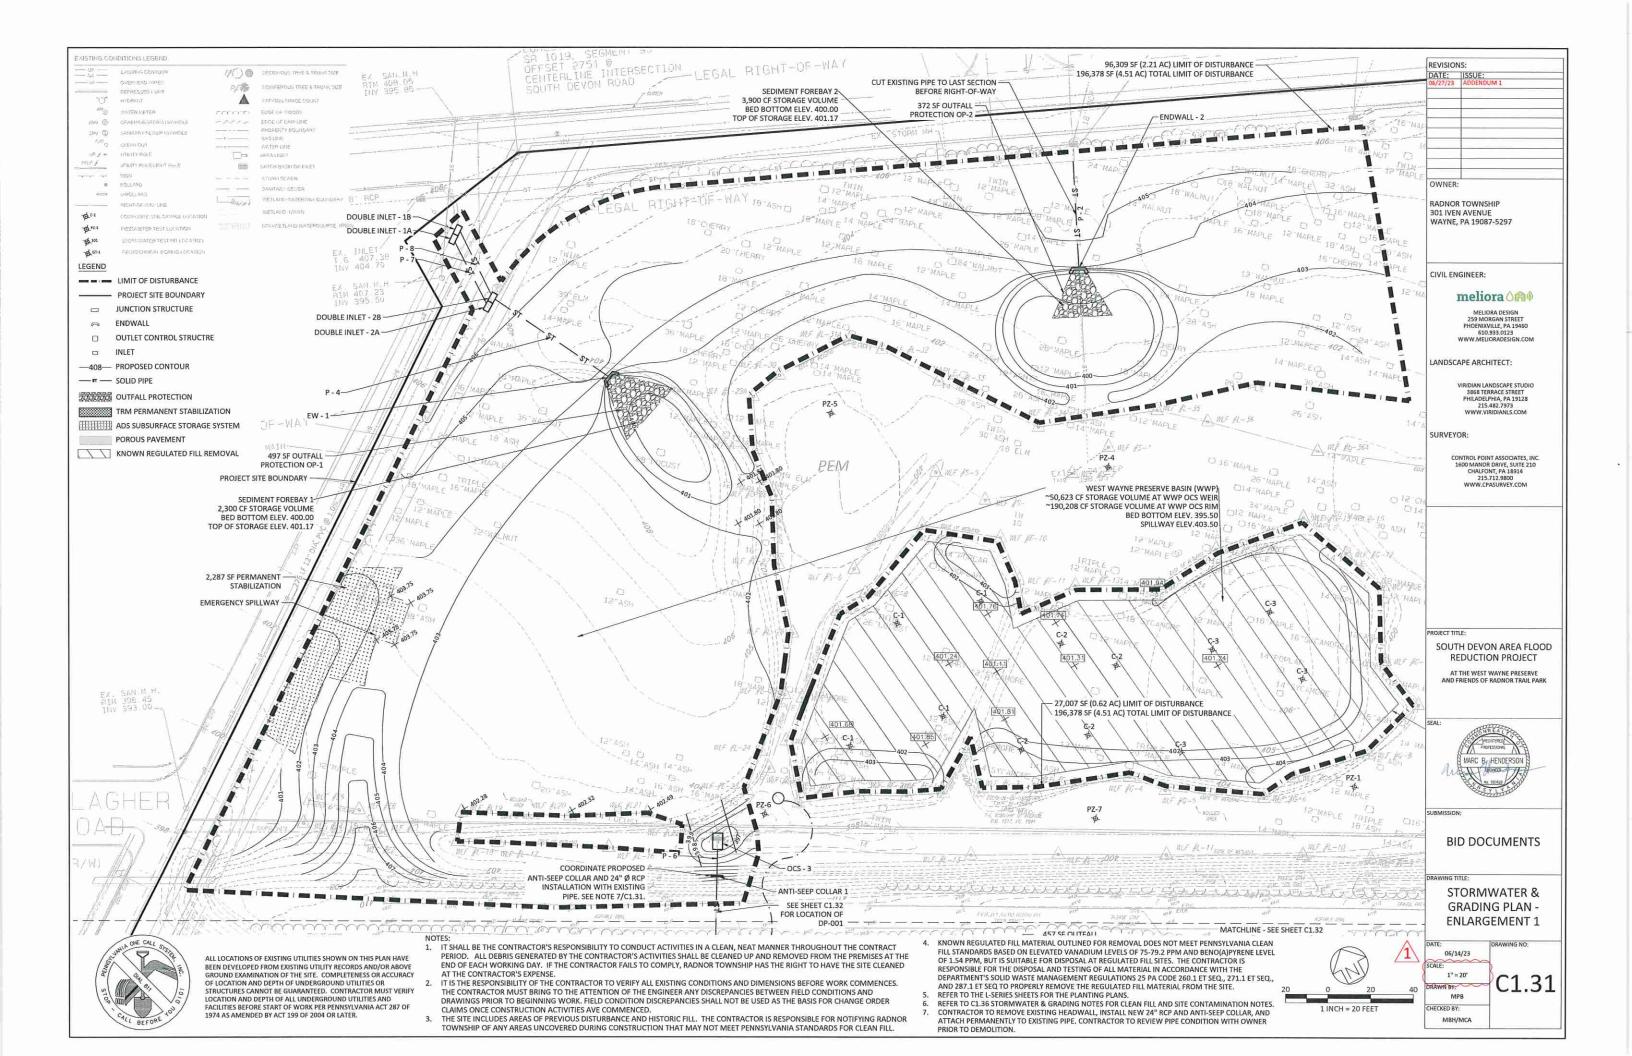


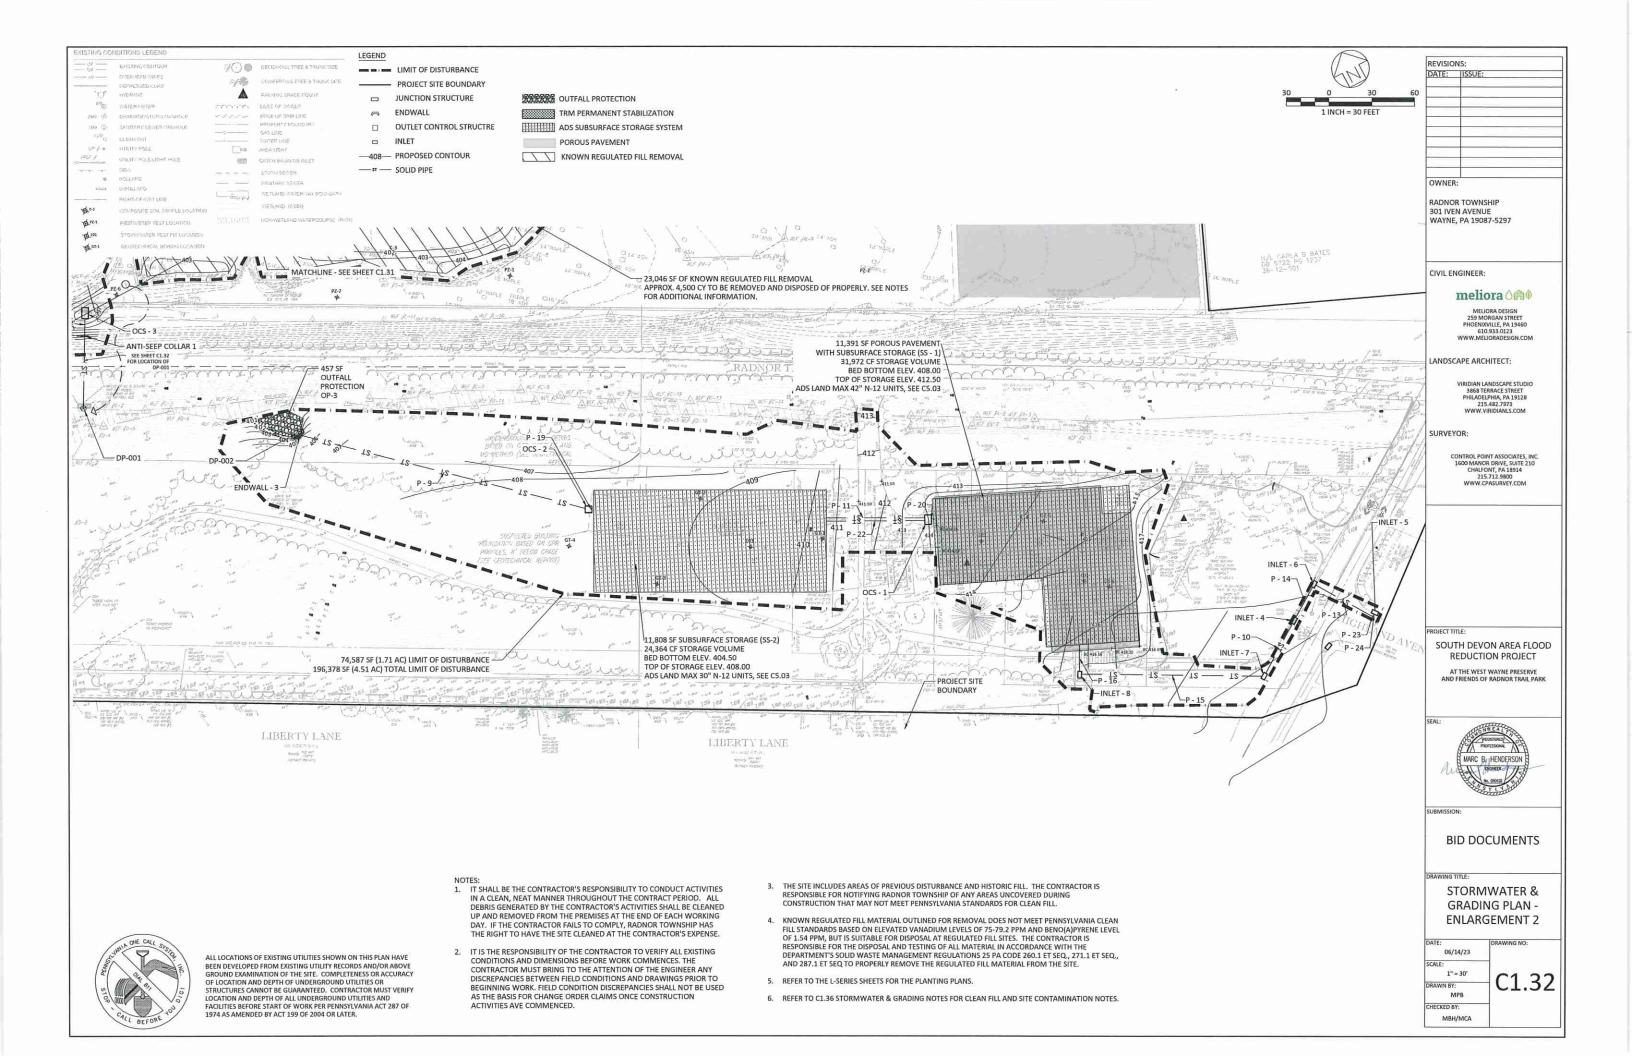

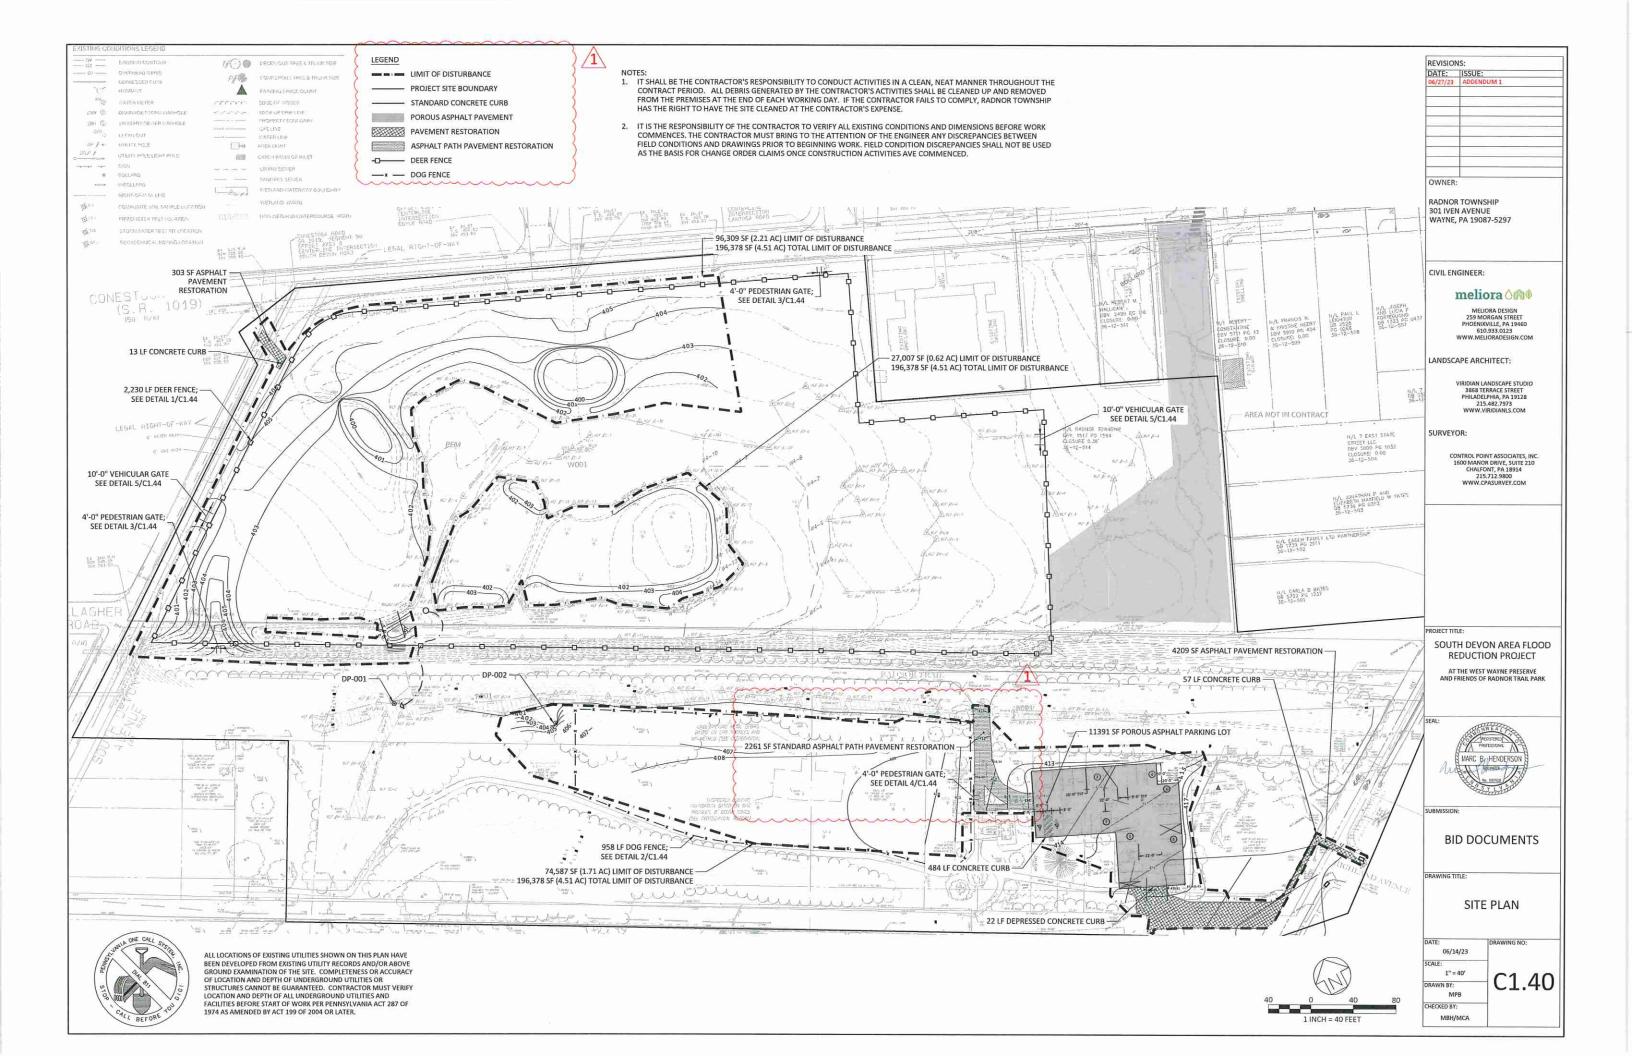

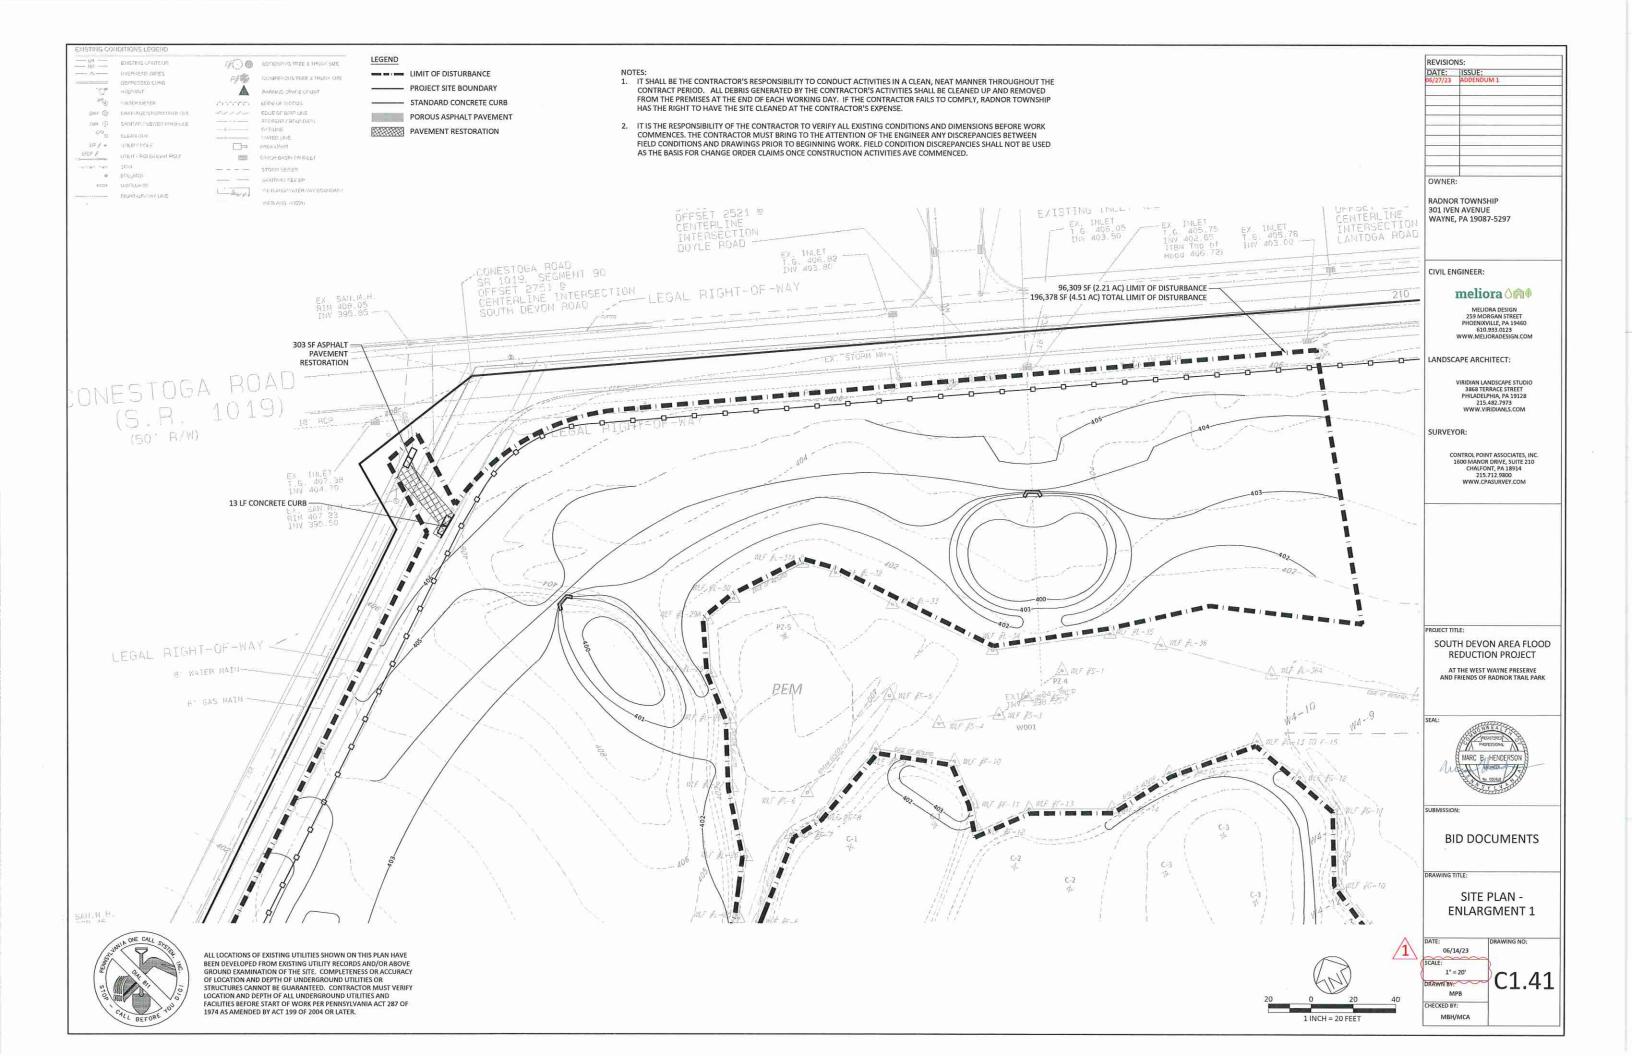

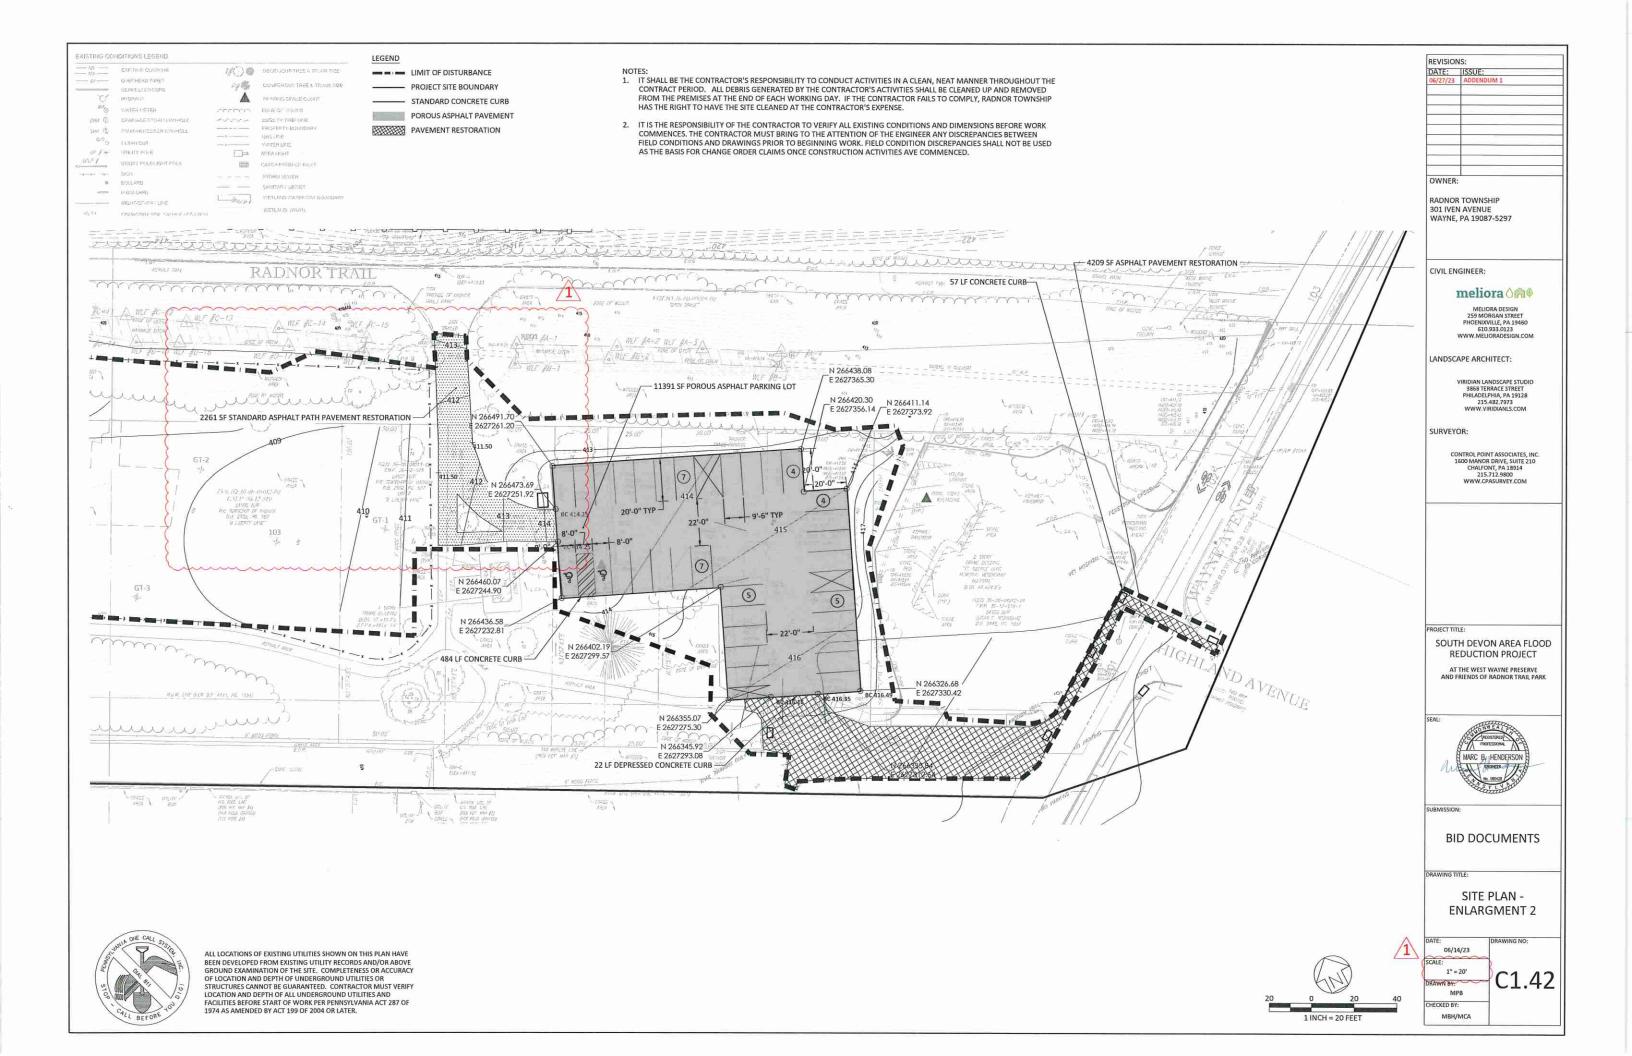


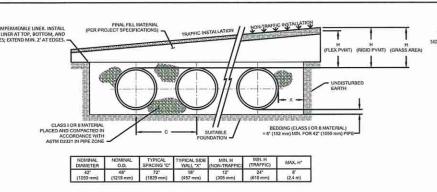

IGHTS OVER MANIFOLD FITTINGS, CONTACT MANUFACTURER'S REPRESENTATIVE FOR INSIDERATIONS WHEN COVER EXCEEDS 8 FT (2.4 m).


- ASURES SHOULD BE TAKEN TO PREVENT THE MIGRATION OF TIVE FINES INTO THE BACKFILL MATERIAL, WHEN REQUIRED, SEE


DETENTION SYSTEM CROSS SECTION C5.04 SS-1 UPPER PARKING LOT N.T.S.

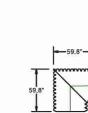

42" DOUBLE MANIFOLD TEE SS-1 UPPER PARKING LOT N.T.S.




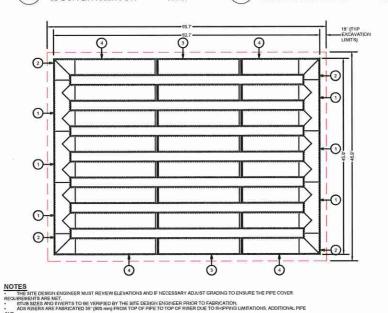

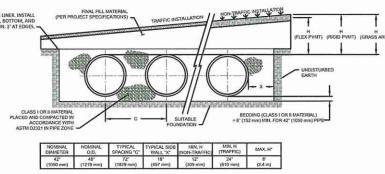


IM FILL HEIGHTS OVER MANIFOLD FITTINGS, CONTACT MANUFACTURER'S REPRESENTATIVE FOR ATION CONSIDERATIONS WHEN COVER EXCEEDS 6 FT (2.4 m).

DETENTION SYSTEM CROSS SECTION C5.04 SS-1 LOWER PARKING LOT N.T.S

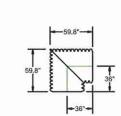


42" DOUBLE MANIFOLD TEE SS-1 LOWER PARKING LOT N.T.S.




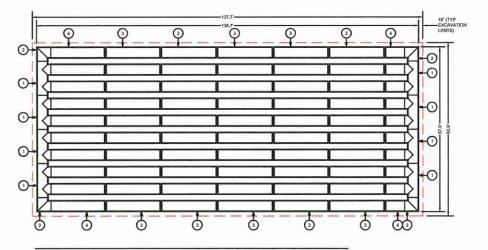


NOTES
THE SITE DESIGN ENGINEER MUST REVIEW ELEVATIONS AND IF NECESSARY ADJUST GRADING TO ENSURE THE PIPE COVER

DETENTION SYSTEM PIPE LAYOUT
C5.04 SS-1 LOWER PARKING LOT N.

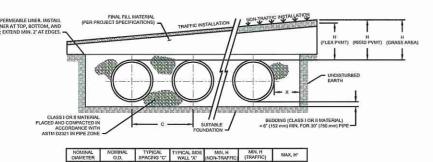

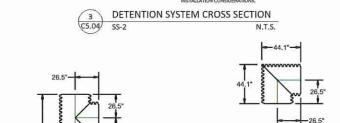

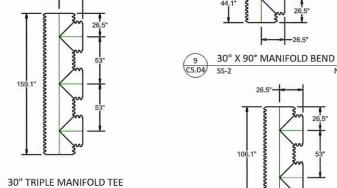

10 C5.04 N.T.S. (5) +② -0° -0 +2


GINEER MUST REVIEW ELEVATIONS AND IF NECESSARY ADJUST GRADING TO ENSURE THE PIPE COVER THE STED DESIGN ENGINEER MUST REVIET ELEVATIONS AND ASSOCIATED STATE OF THE STED DESIGN ENGINEER PRICE TO FASRICATION.

STUB SIZES AND INVESTS TO BE VERIFIED BY THE SITE DESIGN ENGINEER PRICE TO FARRICATION.

ADS RISERS ARE FASRICATED 35" (500 mm) FROM TOP OF PIPE TO TOP OF RISER DUE TO SHIPPING LIMITATIONS, ADDITIONAL PIPE.

ERS CAN BE USED TO EXTEND THE RISERS TO GRADE. AYOUT SHOWN DOES NOT INCLUDE ADDITIONAL PIPE & MANIFOLD NEEDED FOR PROPER PIPE INSERTION INTO STRUCTURES.

13 DETE C5.04 SS-2 DETENTION SYSTEM PIPE LAYOUT

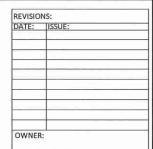

RADNOR TOWNSHIP 301 IVEN AVENUE WAYNE, PA 19087-5297

CIVIL ENGINEER:



MELIORA DESIGN 259 MORGAN STREET PHOENIXVILLE, PA 19460 610.933.0123 WWW.MELIORADESIGN.COM

LANDSCAPE ARCHITECT:

3868 TERRACE STREET PHILADELPHIA, PA 19128 215.482.7973 WWW.VIRIDIANLS.COM

SURVEYOR:

CONTROL POINT ASSOCIATES, INC. 1600 MANOR DRIVE, SUITE 210 CHALFONT, PA 18914 215.712.9800 WWW.CPASURVEY.COM

N.T.S.

30" DOUBLE MANIFOLD TEE

SOUTH DEVON AREA FLOOD AT THE WEST WAYNE PRESERVE

MARC BUILDERSON



BID DOCUMENTS

RAWING TITLE:


CHECKED BY:


MBH/MCA


STORMWATER DETAILS SHEET 3

DRAWING NO: 06/14/23 AS NOTED C5.04 DRAWN RY MPB


DETENTION SYSTEM I C5.04 SS-1 UPPER PARKING LOT DETENTION SYSTEM PIPE LAYOUT

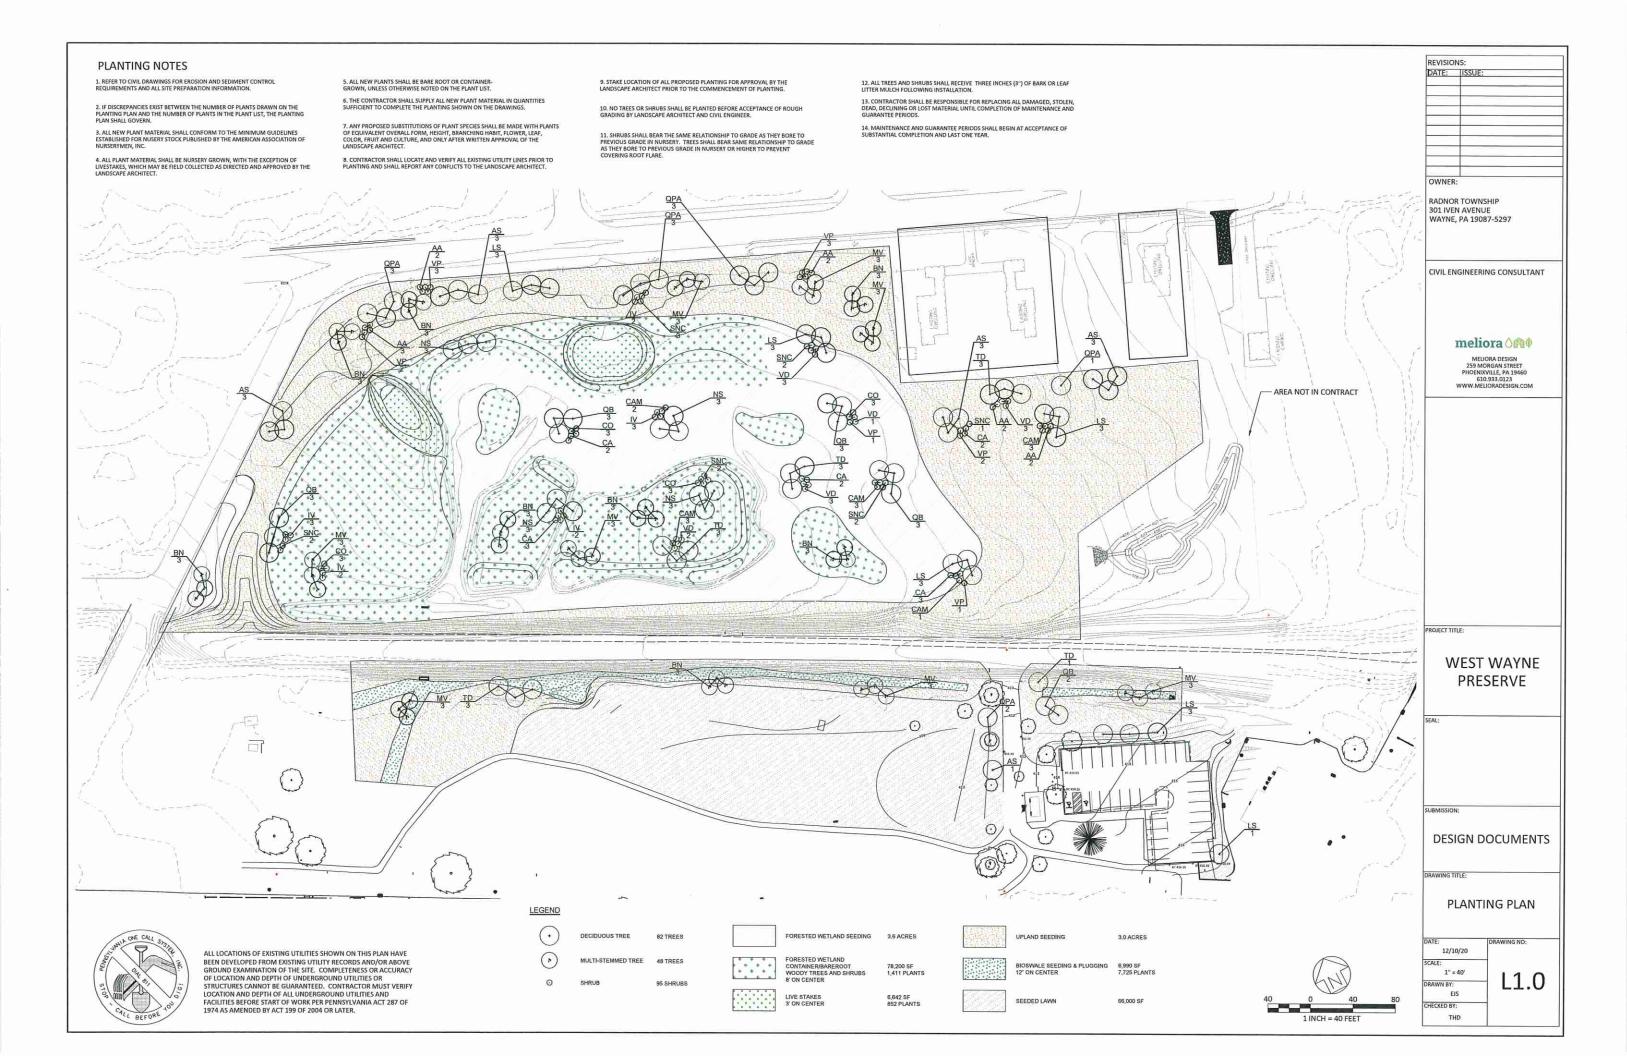


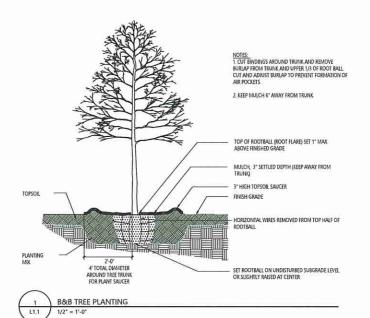


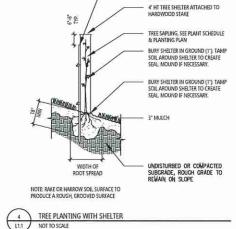

1"X1"X6" HARDWOOD STAKE PLACE STAKE ON SIDE OF PRIMARY WIND DIRECTION.

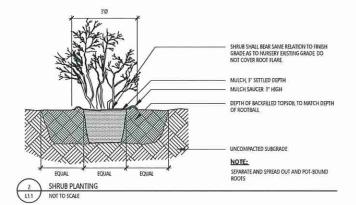

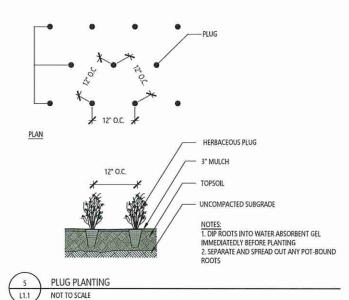

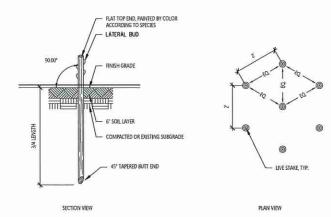

1. LIVE STAKES ARE TO BE DORMANT LIVE BRANCHES MEASURING 24 TO 36 INCHES, WITH BASAL END DIAMETERS OF \$\mathcal{E}\$ TO 2 INCHES, WITH NO SIDE BRANCHES.

2. BUTT ENDS OF STAKE SHALL BE ANGLED AT 45 DEGREES.

OBTAIN LIVE STAKES FROM A NURSERY OR CUT FROM APPROVED SOURCES USING A SHARP TOOL. AVOID DAMAGE TO THE COLLECTION SITE BRANCHES SHALL BE FLEXIBLE, FREE FROM DISEASE OR EXCESS DEAD TWIGS, AND MUST BE DORMANT.

4. ALL SIDE BRANCHES SHALL BE CLEANLY GUT FROM LIVE STAKES.

3 LIVE STAKE PLANTING
L1.1 NOT TO SCALE

		B&B Trees						
24	BN	Betula nigra	River Birch	8' tall	As shown	8&8	FACW	multi-stem
13	COH	Celtis occidentalis	Hackberry	2 1/2"-3" caliper	As shown	B&B	FACU	
14	LS	Liquidambar styracifilua	Sweetgum	2 1/2"-3" caliper	As shown	8&8	FAC	
24	MV	Magnolia virginiana	Sweetbay Magnolia	8' tall	As shown	8&8	FACW	multi-stem
14	NS	Nyssa sylvatica	Black Tupelo	2 1/2"-3" caliper	As shown	8&8	FAC	_
14	QB	Quercus bicolor	Swamp White Oak	2 1/2"-3" caliper	As shown	8&8	FACW+	
13		Quercus palustris	Pin Oak	2 1/2"-3" caliper	As shown	8&8	FACW	
14	TD	Taxodium distichum	Bald Cypress	8' tall	As shown	B&B	OBL	conifer
		B&B Shrubs						
11		Aronia arbutifolia	Red Chokecherry	24-36*	As shown	Container/Bareroot	FACW	
12	co	Cephelanthus occidentalis	Common Buttonbush	24-36"	As shown	Container/Bareroot	OBL	
12	CA	Clethra alnifolia	Sweet Pepper Bush	24-36"	As shown	Container/Bareroot	FACW	
12		Comus amomum	Silky Dogwood	24-36"	As shown	Container/Bareroot	FACW	
12	IV	Ilex verticillata	Winterberry Holly	24-36"	As shown	Container/Bareroot	FACW	
12	SNC	Sambucus nigra canadensis	American Black Elderberry	24-36"	As shown	Container/Bareroot	FACW	
12	VD	Viburnum dentatum	Arrow-wood	24-36"	As shown	Container/Bareroot	FAC	
#2	VP	Vibumum prunifolium	Blackhaw	24-36°	As shown	Container/Bareroot	FACU	
	٠.	Forested Wetland Containe	r/Bareroot Trees & Shrubs					
83		Acer saccharinum	Silver Maple	24-36"	8' OC	Container/Bareroot	FAC	
83		Betula nigra	River Birch	24-36"	8' OC	Container/Bareroot	FACW	
83		Celtis occidentalis	Hackberry	24-36"	8' OC	Container/Bareroot	FACU	
83		Liquidambar styracifilua	Sweetgum	24-36"	8' OC	Container/Bareroot	FAC	
83		Platanus occidentalis	American Sycamore	24-36"	8' OC	Container/Bareroot	FACW-	
83		Quercus bicolor	Swamp White Oak	24-36"	8' OC	Container/Bareroot	FACW+	
83		Quercus palustris	Pin Oak	24-36"	8' OC	Container/Bareroot	FACW	
83		Salix nigra	Black Willow	24-36"	8, OC	Container/Bareroot	OBL	
83		Acer negundo	Box Elder	24-36"	8, OC	Container/Bareroot	FAC	
83		Alnus semulata	Smooth Alder	24-36"	8' OC	Container/Bareroot	OBL	
83		Aronia arbutifolia	Red Chokecherry	24-36"	8' OC	Container/Bareroot	FACW	
83		Cephelanthus occidentalis	Common Buttonbush	24-36"	8' OC	Container/Bareroot	OBL	
83		Clethra ainifolia	Sweet Pepper Bush	24-36"	8' OC	Container/Bareroot	FACW	
83		Cornus amomum	Silky Dogwood	24-36"	8' OC	Container/Bareroot	FACW	
83		llex verticillata	Winterberry Holly	24-36"	8, OC	Container/Bareroot	FACW	
83		Sambucus nigra canadensis	American Black Elderberry	24-36"	8' OC	Container/Bareroot	FACW	
83		Viburnum dentatum	Arrow-wood	24-36"	8' OC	Container/Bareroot	FAC	
83		Viburnum prunifolium	Blackhaw	24-36"	8' OC	Container/Bareroot	FACU	
::		Live Stakes			***************************************		- Augusta	_
170	· ·	Comus amomum	Silky Dogwood	3-4'	3, OC	Live Stake	FACW	
171		Cephelanthus occidentalis	Common Buttonbush	3-4'	3' OC	Live Stake	OBL	
171		Salix nigra	Black Willow	3-4'	3, OC	Live Stake	OBL	
170		Sambucus nigra canadensis	American Black Elderberry	3-4'	3, OC	Live Stake	FACW	
170	\vdash	Viburnum dentatum	Arrow-wood	3-4'	3' OC	Live Stake	FAC	_
		Bioswale Plugging		17-3	10.00	Inna Dimen	Tree.	-!-
1287	1	Asclepias incamata	Swamp Milkweed	LP50 Plug	12" OC	PLUG	1	
		Aster novae-angliae	New England Aster	LP50 Plug	12" OC	PLUG		\rightarrow
1287		Eupatorium fistulosum	Joe-Pye Weed	LP50 Plug	12" OC	PLUG		_
					12" OC	PLUG		_
1287		Helenium autumnale	Spenzeweed					
1287 1287 1288 1288		Helenium autumnale Heliopsis helianthoides	Sneezeweed Smooth Oxeye	LP50 Plug LP50 Plug	12" OC	PLUG		

SPACING TYPE

INDICATOR/STATUS NOTES

PLANT SCHEDULE QUAN. SYM. BOTANICAL NAME

B&B Trees

	NG SCHEDULE		
	BOTANICAL NAME	COMMON NAME	% of MI)
	Bloswale Seeding 12 lbs. per ac	re	
_	Elymus virginicus	Virginia Wild Rye	169
	Schlzachyrlum scoparium	Little Bluestem	109
	Vernonia noveboracensis	New York Ironweed	109
	Helenium autumnale	Common Sneezeweed	75
	Liatris spicata	Dense Blazing Star	65
	Panicum virgatum	Switchgrass	69
	Verbena hastata	Blue Vervain	69
	Eupatorium purpureum	Purple Joe-Pye	55
	Scirpus atrovirens	Green Bulrush	55
	Penstemon digitalis	Foxglove Beardtongue	49
	Pycnanthemum virginianum	Mountain Mint	49
	Rudbeckia hirta	Black-Eyed Susan	43
	Sorghastrum nutans	Indian Grass	49
	Symphyotrichum novae-angliae	New England Aster	49
	Lobelia siphilitica	Blue Lobelia	39
	Monarda fistulosa	Wild Bergamot	39
	Heliopsis helianthoides	False Sunflower	29
	Iris versicolor	Blueflag Iris	19
	Forested Wetland Seeding 9lbs		
	Carex lurida	Shallow Sedge	209
	Andropogon gerardii	Big Bluestem	145
	Panicum virgatum	Switchgrass	129
	Heliopsis hellanthoides	False Sunflower	109
	Mimulus ringens	Monkey Flower	99
	Juncus effusus	Soft Rush	89
	Symphyotrichum novae-angilae	New England Aster	79
	Vernonia noveboracensis	New York Ironweed	69
	Monarda fistulosa	Wild Bergamot	59
	Asclepias incarnata	Swamp Milkweed	45
	Verbena hastata	Blue Vervain	35
17.6	Pycnanthemum virginianum	Mountain Mint	25
Š	Upland Seeding 21 lbs per acre	V.	
	Elymus virginicus	Virginia Wild Rye	259
	Panicum virgatum	Switchgrass	209
	Andropogon gerardii	Big Bluestern	169
	Heliopsis hellanthoides	False Sunflower	129
	Tridens flavus	Purpletop	89
	Rudbeckia hirta	Black-Eyed Susan	75
	Chamaecrista fasciculata	Partridge Pea	69
	Sorghastrum nutans	Indian Grass	69



ROJECT TITLE:

SOUTH DEVON AREA FLOOD REDUCTION PROJECT


AT THE WEST WAYNE PRESERVE AND FRIENDS OF RADNOR TRAIL PARK





BID DOCUMENTS


PLANTING DETAILS PLANT SCHEDULE

06/14/23 CHECKED BY: TD

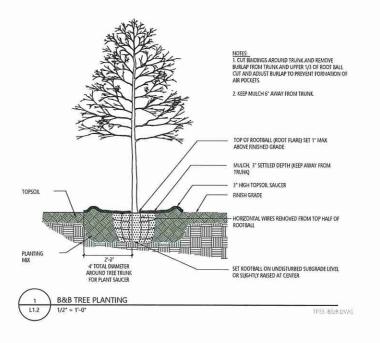

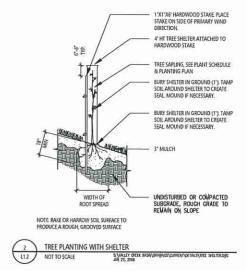

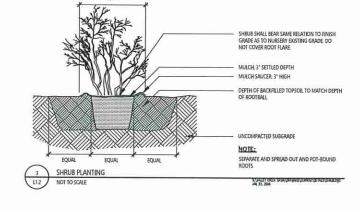

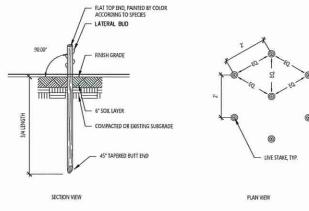

NOTES:


1. LIVE STAKES ARE TO BE DORMANT LIVE BRAINCHES MEASURING 24 TO 36 INCHES, WITH BASAL END DIAMETERS OF ½ TO 2 INCHES, WITH NO SIDE BRAINCHES.

2 BUTT ENDS OF STAKE SHALL BE ANGLED AT 45 DEGREES.

3. OBTAIN LIVE STAKES FROM A NURSERY OR CUT FROM APPROVED SOURCES USING A SHARP TOOL AVOID DAMAGE TO THE COLLECTION SITE BRANCHES SHALL BE FLEXIBLE, FREE FROM DISEASE OR EXCESS DEAD THYIGS, AND MUST BE DORMANT.

4. ALL SIDE BRANCHES SHALL BE CLEANLY CUT FROM LIVE STAKES.

4 LIVE STAKE PLANTING
L1.2 NOT TO SCALE

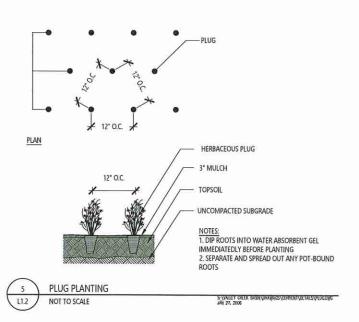

LIVE STAKE HANDLING & INSTALLATION

1. LIVE STAKES ARE LIVE, ROOTABLE VEGETATIVE CUTTINGS. DELIVERY TIME FOR LIVE STAKES IS TYPICALLY 2 -3 WEEKS FROM ORDER DATE, WHEN ORDERING, INCLUDE TIME FOR SOAKING (SEE NOTE 3 BELOW).

2. IF THE CUTTINGS HAVE NOT BEEN TOP SEALED BY THE NURSERY, DIP THE TOP 1-2 INCHES OF THE CUTTING INTO A 50-50 MIX OF LIGHT-COLORED LATEX PAINT AND WATER. TOP SEALING PREVENTS EXCESSIVE TRANSPIRATION. USE DIFFERENT PAINT COLORS TO IDENTIFY EACH SPECIES. THE TOP OF THE CUTTING MUST BE CORRECTLY IDENTIFIED BEFORE SEALING, BUDS EMERGING FROM THE LEAF SCAR ALWAYS POINT UP. STEM DIAMETER IS OFTEN SMALLER NEAR THE TOP, STAKES PLANTED UPSIDE-DOWN WILL HAVE SIGNIFICANT MORTALITY.

3. SOAK LIVE STAKES IN WATER FOR 24 HOURS PRIOR TO PLANTING, AVOID SOAKING THE SEALED TOP END. SOAKING CAN BE DONE IN TRASH CANS. PROTECT THE CUTTINGS FROM SUN AND WIND EXPOSURE DURING SOAKING.

4. PLANT LIVE STAKES AT THE SPACING SHOWN IN DETAIL 1/L1.0. TO PLANT A STAKE, FIRST DRIVE A PILOT HOLE THROUGH THE TURF REINFORCEMENT MAT AND INTO THE GROUND USING A STEEL ROD OR PIECE OF REBAR.

5. TAMP THE STAKE INTO THE PILOT HOLE WITH A DEAD BLOW HAMMER (HAMMER HEAD FILLED WITH SHOT OR SAND). DO NOT SPLIT THE STAKE DURING INSTALLATION, REMOVE AND REPLACE SPLIT STAKES,

6. BURY THREE-QUARTERS OF THE STAKE. INADEQUATELY BURIED STAKES WILL DIE OF DESSICATION. FIRMLY PACK THE SOIL AROUND THE STAKE AFTER INSTALLATION.

TREE SHELTER INSTALLATION

TREE SHELTERS: TUBEX SHELTERS OR APPROVED EQUAL. TUBES SHALL INCLUDE MANUFACTURER-SUPPLIED HARDWOOD STAKES, TIES, AND BIRD SCREEN.

2. TREE SHELTERS ARE AVAILABLE FROM OCTORARO NATIVE PLANT NURSERY, 6126 STREET ROAD, KIRKWOOD, PA 17536, (PH) 717 529-3160 (F) 717 529-4099.

3. FOLLOW MANUFACTURER'S INSTRUCTIONS FOR INSTALLATION.

REVISIO	
DATE:	ISSUE:
	+
OWNER	l:
RADNO	R TOWNSHIP
	N AVENUE
301 IVE	N AVENUE , PA 19087-5297
301 IVE	
301 IVE WAYNE	, PA 19087-5297
301 IVE WAYNE	
301 IVE WAYNE	, PA 19087-5297
301 IVE WAYNE	, PA 19087-5297 NGINEERING CONSULTANT
301 IVE WAYNE	, PA 19087-5297
301 IVE WAYNE	, PA 19087-5297 NGINEERING CONSULTANT
301 IVE WAYNE	MELIORA DESIGN 259 MORGAN STREET
301 IVE WAYNE	MELIORA DESIGN 259 MORGAN STREET PHOENIXULE, PA 19460
301 IVE WAYNE	MELIORA DESIGN 259 MORGAN STREET
301 IVE WAYNE	MELIORA DESIGN 259 MORGAN STREET PHOENIXVILLE, PA 19460 610,933,0123

WEST WAYNE PRESERVE

DESIGN DOCUMENTS

DRAWING TITLE:

PLANTING PLAN

DRAWING NO:

12/10/20 NA L1.2 DRAWN BY: EJS CHECKED BY: