RECORD PLAN SUBMISSION FOR CHURCH WALK AND BRIDGE



Villanova University

SITUATED IN RADNOR TOWNSHIP, DELAWARE COUNTY, PENNSYLVANIA

PLAN INDEX

RELATION	NO.	DESCRIPTION	START DATE	REVISION DATE
1 OF 20	C0.0	TITLE SHEET	MARCH 13, 2015	OCTOBER 6, 2015
2 OF 20	C1.1	EXISTING FEATURES / DEMOLITION PLAN	MARCH 13, 2015	OCTOBER 6, 2015
3 OF 20	C2.0	COMPOSITE SITE PLAN	MARCH 13, 2015	OCTOBER 6, 2015
4 OF 20	C2.1	SITE PLAN	MARCH 13, 2015	OCTOBER 6, 2015
5 OF 20	C3.1	GRADING PLAN	MARCH 13, 2015	OCTOBER 6, 2015
6 OF 20	C4.1	UTILITY PLAN	MARCH 13, 2015	OCTOBER 6, 2015
7 OF 20	C4.2	UTILITY PROFILES	MAY 26, 2015	OCTOBER 6, 2015
8 OF 20	C5.1	EROSION & SEDIMENTATION CONTROL PLAN	MARCH 13, 2015	OCTOBER 6, 2015
9 OF 20	C5.2	EROSION & SEDIMENTATION CONTROL DETAIL SHEET	MARCH 13, 2015	OCTOBER 6, 2015
10 OF 20	C5.3	EROSION & SEDIMENTATION CONTROL DETAIL SHEET	MARCH 13, 2015	OCTOBER 6, 2015
11 OF 20	C6.1	CONSTRUCTION DETAIL SHEET	MARCH 13, 2015	OCTOBER 6, 2015
12 OF 20	C6.2	CONSTRUCTION DETAIL SHEET	MARCH 13, 2015	OCTOBER 6, 2015
13 OF 20	C7.1	SITE LIGHTING PLAN	MARCH 13, 2015	AUGUST 10, 2015
14 OF 20	C7.2	SITE LIGHTING PLAN	MARCH 13, 2015	AUGUST 10, 2015
15 OF 20	C7.3	SITE LIGHTING DETAILS	MARCH 13, 2015	AUGUST 10, 2015
16 OF 20	L1.0	PLANTING PLAN	MARCH 13, 2015	AUGUST 10, 2015
17 OF 20	L1.1	PLANTING PLAN AT ALDWYN TRIANGLE	MARCH 13, 2015	AUGUST 10, 2015
18 OF 20	L2.0	PLANTING SCHEDULE AND TABULATIONS	MARCH 13, 2015	AUGUST 10, 2015
19 OF 20	L2.1	LANDSCAPE DETAILS	MARCH 13, 2015	AUGUST 10, 2015
20 OF 20	L2.2	LANDSCAPE DETAILS	MARCH 13, 2015	AUGUST 10, 2015

20112071855 20112071869 20112071907 20112071907 20112071937 PROJECT SERIAL NO. 20112071972

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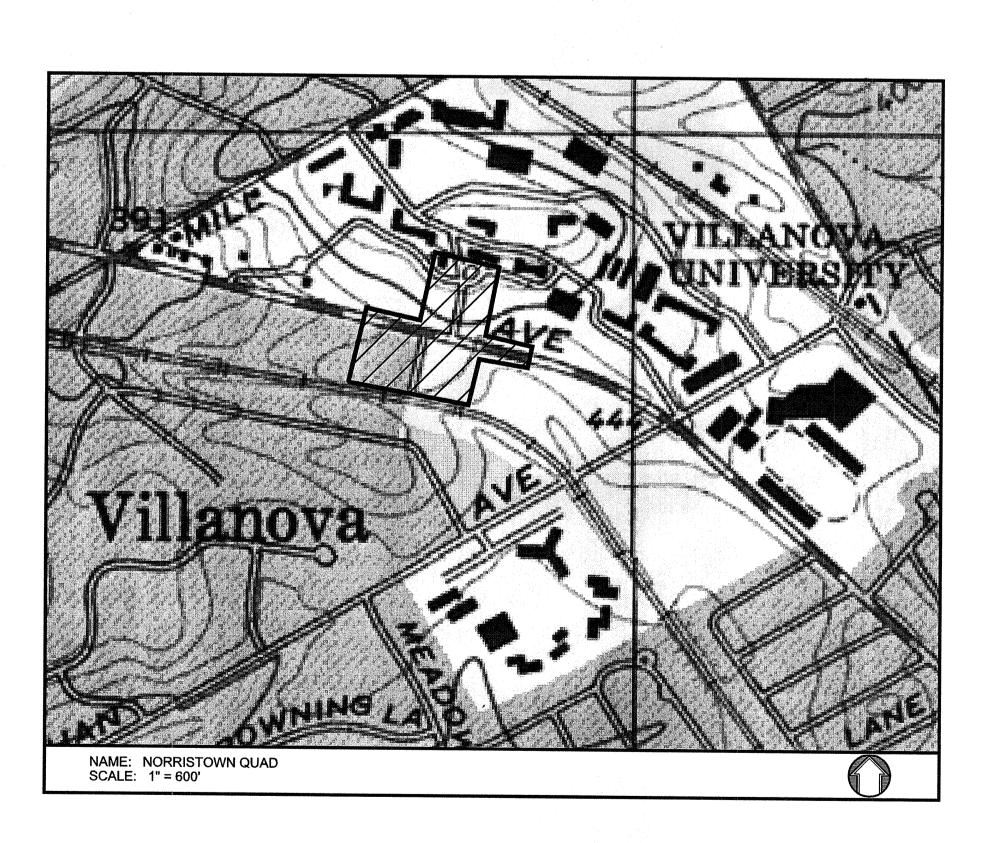
PENNSYLVANIA LAW REQUIRES

3 WORKING DAYS NOTICE FOR CONSTRUCTION PHASE AND 10 WORKING

DAYS IN DESIGN STAGE - STOP CALL

Pennsylvania One Call System, Inc.

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OWNER / APPLICANT

VILLANOVA UNIVERSITY

VILLANOVA UNIVERSITY 800 E LANCASTER AVE VILLANOVA, PA 19085 610-519-4500

GREGORY C. NEWELL, PE
PENNSYLVANIA LICENSE NO. PE 36760-E

RADNOR TOWNSHIP ENGINEER CERTIFICATION:
REVIEWED: BY RADNOR TOWNSHIP ENGINEER,
THIS _______ DAY OF _______, 20__.

required by radnor township subdivision and land development ordinance.

HEREBY CERTIFY THAT THE PLAN SHOWN AND DESCRIBED HEREON IS TRUE AND CORRECT TO THE ACCURACY

RADNOR TOWNSHIP BOARD OF SUPERVISORS CERTIFICATION:

APPROVED BY RADNOR TOWNSHIP BOARD OF SUPERVISORS,
THIS ______ DAY OF ______, 20__.

PRESIDEN

DELAWARE COUNTY PLANNING DEPARTMENT CERTIFICATION:

REVIEWED BY THE DELAWARE COUNTY PLANNING DEPARTMENT,
THIS ______ DAY OF ______, 20__.

RADNOR TOWNSHIP ZONING OFFICER CERTIFICATION:

REVIEWED BY THE RADNOR TOWNSHIP ZONING OFFICER,
THIS ______ DAY OF ________, 20__.

RECORDER OF DEEDS
RECORDED IN THE OFFICE OF THE RECORDER OF DEEDS IN MEDIA, DELAWARE COUNTY, PENNSYLVANIA, IN PLAN BOOK _____, PAGE_ON THE _____DAY OF ______, 20__.

(DEPUTY) RECORDER OF DEEDS

CERTIFICATE OF OWNERSHIP

AND ACKNOWLEDGEMENT OF PLAN

ON THIS, THE ______ DAY OF ______, 20 ____, BEFORE ME, THE

UNDERSIGNED OFFICER, PERSONALLY APPEARED _____

(NAME OF OWNER)

WHO BEING DULY SWORN ACCORDING TO LAW, DEPOSES AND SAYS THAT HE/SHE IS THE OWNER AND/OR EQUITABLE OWNER OF THE PROPERTY SHOWN ON THIS PLAN, AND THAT HE/SHE ACKNOWLEDGES THE SAME TO BE HIS/HER ACT AND PLAN AND DESIRES THE SAME BE RECORDED AS SUCH ACCORDING TO LAW.

WITNESS MY HAND AND SEAL THE DAY AND DATE ABOVE WRITTEN.

MY COMMISSION EXPIRES:

(NOTARY PUBLIC OR OTHER OFFICER)

Villanova University
Church Walk and Bridge
Lancaster and Ithan Avenues

Villanova PA 19085

VMA RAMSA

ARCHITECT-OF-RECORD
Voith & Mactavish Architects LLF
2401 Walnut Street, 6th Floor
Philadelphia, PA 19103
phone: 215-545-4544
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Robert A.M. Stern Architects LLP
460 West 34th Street
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Wayne, PA 19087

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www.navenewell.com

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PLANNING AND DESIGN
The Harman Group, Inc.
900 West Valley Forge Road, Suite 200
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phone cell: 267-303-3753
www.sikora-wa.com

ELEVATOR CONSULTANT
Zipf Associates Inc.
25 Bala Avenue, Suite 201
Bala Cynwyd, PA 19004
phone: 610-667-1717
fax:610-667-0216



RECORD PLAN SUBMISSION


Revision #6 OCTOBER 6, 2015

Date March 13, 2015

itle Title Sheet

Scale As Noted
Drawn By DWN

C0.0

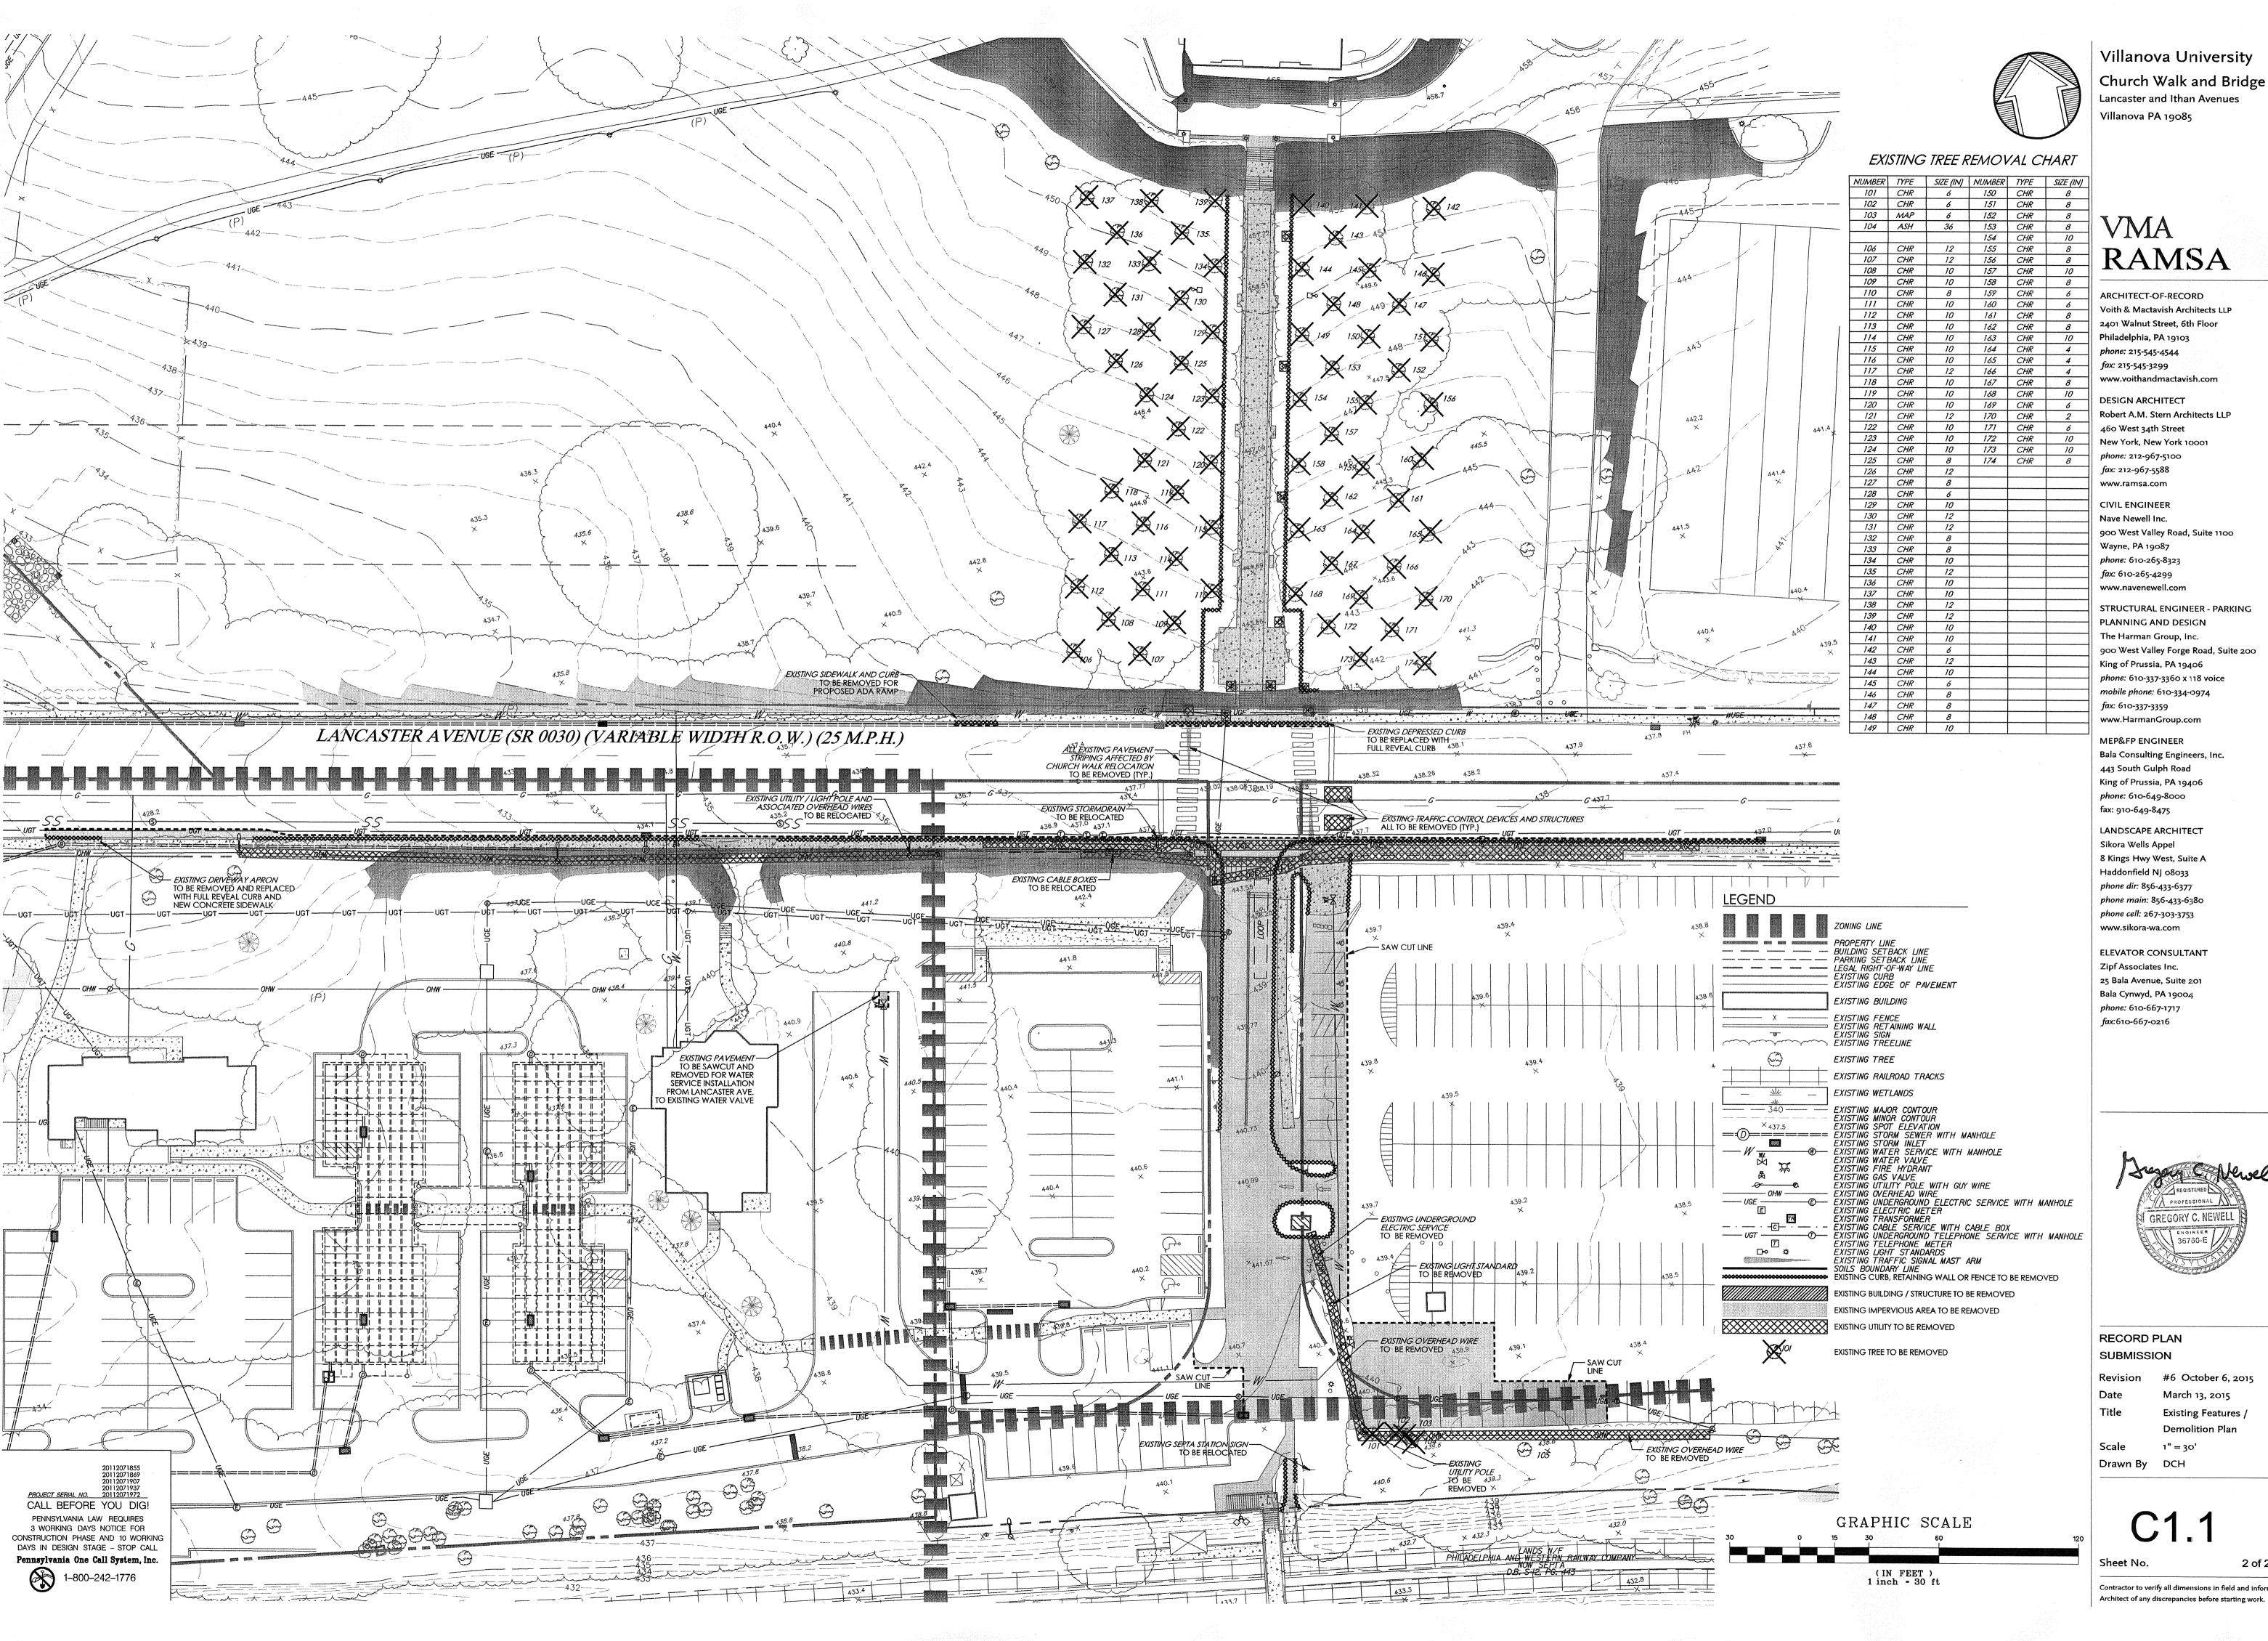

Church Walk and Bridge Lancaster and Ithan Avenues Villanova PA 19085

Philadelphia, PA 19103 phone: 215-545-4544 fax: 215-545-3299 www.voithandmactavish.com **DESIGN ARCHITECT**

460 West 34th Street fax: 212-967-5588 www.ramsa.com

CIVIL ENGINEER Nave Newell Inc.


900 West Valley Road, Suite 1100 Wayne, PA 19087 phone: 610-265-8323 fax: 610-265-4299 www.navenewell.com

STRUCTURAL ENGINEER - PARKING PLANNING AND DESIGN The Harman Group, Inc. 900 West Valley Forge Road, Suite 200 King of Prussia, PA 19406 phone: 610-337-3360 x 118 voice mobile phone: 610-334-0974 fax: 610-337-3359 www.HarmanGroup.com

MEP&FP ENGINEER Bala Consulting Engineers, Inc. 443 South Gulph Road King of Prussia, PA 19406 phone: 610-649-8000 fax: 910-649-8475

LANDSCAPE ARCHITECT Sikora Wells Appel 8 Kings Hwy West, Suite A Haddonfield NJ 08033 phone dir: 856-433-6377 phone main: 856-433-6380 phone cell: 267-303-3753 www.sikora-wa.com

ELEVATOR CONSULTANT Zipf Associates Inc. 25 Bala Avenue, Suite 201 Bala Cynwyd, PA 19004 phone: 610-667-1717 fax:610-667-0216

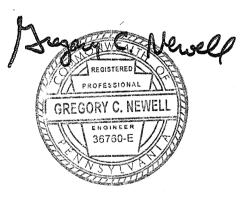

RECORD PLAN SUBMISSION

Revision #6 October 6, 2015 March 13, 2015 Existing Features /

Demolition Plan 1" = 30' Drawn By DCH

Sheet No.

2 of 20 Contractor to verify all dimensions in field and inform

CAMPUS-WIDE ZONING DATA

PLANNED INSTITUTIONAL DISTRICT (PI)

CLASSIFICATION: REQUIRED EXISTING **PROPOSED** BUILDING AREA 30% MAX. 13.0% (29.26 ACRES) (a) 14.3% (32.25 ACRES) (b) TOTAL IMPERVIOUS COVERAGE 45% MAX. 37.6% (84.60 ACRES) (a) 36.4% (81.85 ACRES) (c)

a. DATA OBTAINED FROM LAST CAMPUS DEVELOPMENT APPROVAL SHOWN ON A PLAN ENTITLED "VILLANOVA UNIVERSITY WEST CAMPUS, PROPOSED SOCCER FIELD RECONSTRUCTION", PLAN DATED OCTOBER 4, 2013, LAST REVISED MAY 6, 2014, PREPARED BY ASSOCIATED ENGINEERING CONSULTANTS INCORPORATED (AEC).

1.05 ACRES (1A: 0.42 + 1B: 0.19 + 1C: 0.44) 1.17 ACRES (2A: 0.32 + 2B: 0.37 + 2C: 0.48) DORMITORY BUILDING 1 DORMITORY BUILDING 2 PERFORMING ARTS CENTER +0.77 ACRES 2.99 ACRES (PROPOSED BUILDING AREA)

81.85 ACRES

EXISTING BUILDING AREA 29.26 ACRES PROPOSED BUUILDING AREA +2.99 ACRES EXISTING IMPERVIOUS 84.60 ACRES CICD REDUCTION -2.65 ACRES BRIDGE & VISITOR LOT REDUX -0.10 ACRES

CAMPUS PARKING ANALYSIS

EXISTING REQUIRED PARKING SPACES

AREA USE DESCRIPTION	AREA USE QUANTITY	REQUIRED PARKING
DORMITORY	4,322 BEDS	1,441
OFFICE (NET SF)	365,851 SF	1,303
RETAIL	6,250 SF (6)	44
RESTAURANT		
LARGEST ASSEMBLY AREA	3,778 FIXED SEATS	945
GYMNASIUM / LIBRARY	42,432 SF	283
LARGEST ASSEMBLY AREA	13,722 SF	344
UNSPECIFIED AREA	30,929 SF	104
	TOTAL SPACES	4,464 SPACES
	PARKING AVAILABILITY	5,130 SPACES
	SURPLUS	666 SPACES

PROPOSED REQUIRED PARKING SPACES

AREA USE DESCRIPTION	AREA USE QUANTITY	REQUIRED PARKING
DORMITORY	5,460 BEDS (1)	1,820
OFFICE (NET SF)	368,091 SF (2)	1,311
RETAIL	12,371 SF (3)	76
RESTAURANT	85 SEATS (4)	39
LARGEST ASSEMBLY AREA	4,178 FIXED SEATS (5)	1,045
GYMNASIUM / LIBRARY	42,432 SF	283
LARGEST ASSEMBLY AREA	13,722 SF	344
UNSPECIFIED AREA	37,179 SF (6)	124
	TOTAL SPACES	5,042 SPACES
	PARKING AVAILABILITY	5,126 SPACES
	SUPPLUS	84 SPACES

PROPOSED PARKING TABULATION

AREA USE DESCRIPTION		EXISTING	PROPOSED
MAIN LOT	· · · · · · · · · · · · · · · · · · ·	1,126	62
PIKE LOT		577	1,289
VISITOR LOT		80	45
W. LANCASTER LOT		79	240
ST. AUGUSTINES CENTER		271	494
NEVIN FIELD HOUSE		48	47
UNAFFECTED CAMPUS SPACES		2949	2949
	TOTAL	5,130 SPACES	5,126 SPACES

,138 BEDS PROPOSED WITHIN DORMITORIES 1A-2C (2) 2,240 SF OFFICE PROPOSED WITHIN THE PERF. ARTS CENTER (3) 9,369 SF BOOKSTORE, 2,877 SF CONVENIENCE STORE, 125 SF RETAIL WITHIN THE PERFORMING ARTS CENTER & 27 EMPLOYEES (4) 85 SEATS & 20 EMPLOYEES WITHIN PROPOSED BISTRO (5) 400 SEAT THEATER WITHIN THE PERF. ARTS CENTER (6) CONVERSION OF EXISTING BOOKSTORE TO UNSPECIFIED AREA

ZONING DATA

COMPREHENSIVE INTEGRATED COLLEGE DEVELOPMENT DISTRICT (CICD)

		Meny frame
CLASSIFICATION: MINIMUM CAMPUS AREA	REQUIRED 75 ACRES	PROPOSED 225 ACRES (PI ZONING DISTRICT
MINIMON CAME OF AKEA	75 ACKES	15 ACRES (CO ZONING DISTRICT
		240 ACRES (TOTAL CAMPUS)
MINIMUM/MAXIMUM CICD AREA	>10 / <15 ACRES	13.81 GROSS ACRES
		11.71 NET ACRES
MAXIMUM BUILDING LENGTH	180'	171'
MINIMUM BUILDING SEPARATION		
BETWEEN BUILDING AND BUILDING	45'	45'
BETWEEN BUILDING AND PARKING STRUCTURE	30'	30'
MAXIMUM BUILDING HEIGHT		
ACADEMIC AND PERFORMANCE FACILITIES	50'	49.9'
FLY LOFT	65'	64.1'
HOUSING AND SOCIAL FACILITIES	45'	44.9' BLDG. 1, 44.8' BLDG. 2
PARKING STRUCTURE	38'	37.9'
MAXIMUM BUILDING COVERAGE - TOTAL (INCLUDES PARKING STRUCTURE)	30%	35.5%*
MAXIMUM BUILDING COVERAGE - INDIVIDUAL		
RESIDENCE HALL 1 (1.05 ACRES)	10%	7.6%
RESIDENCE HALL 2 (1.17 ACRES)	10%	8.5%
PERFORMING ARTS CENTER (0.77 ACRES)	10%	5.6%
MAXIMUM RETAIL SQUARE FOOTAGE	5% OF GSF	2.9% OF GSF ***
MINIMUM FACILITY SETBACK FROM SINGLE FAMILY RESIDENTIAL USE	100'	227.8'
MINIMUM ELEVATOR/STAIR TOWER ON PARKING STRUCTURE SETBACK	10'	10'
MAXIMUM LENGTH OF ELEVATOR/STAIR TOWER PROJECTION	50'	41.4'
MINIMUM LOADING AREA SETBACK	5'	5'
RIPARIAN BUFFER SETBACK	50'	82.5'
MAXIMUM IMPERVIOUS AREA	82%**	69%
	•	• • •


- BUILDING COVERAGE EXCEEDING 30% SHALL REQUIRE TWO SQUARE FEET OF OPEN SPACE DEDICATION PER ONE SQUARE FOOT OVER 30%. 33,106 SF EXCEEDING 30% BUILDING COVERAGE REQUIRES 66,212 SF OPEN SPACE DEDICATION. (87,120 SF PROVIDED) (REFER TO THIS SHEET FOR LOCATION OF PRESERVATION AREA)
- ** PROPOSED IMPERVIOUS CONDITIONS MUST BE A MINIMUM 10% REDUCTION FROM EXISTING IMPERVIOUS AREA MAIN LOT: 6.8 Ac + PIKE LOT: 4.0 Ac = 10.8 Ac/11.71 Ac = 92% EXISTING IMPERVIOUS COVERAGE - 10% = 82%

5,101 SF (2A) + 9,369 SF (2B) + 125 SF (PAC) 14,595 SF = 2.9% OF GSF194,558 SF (BUILDING 1) + 223,376 SF (BUILDING 2) * 79,400 SF (PAC)

SETBACK CHART	ARTERIA	L STREETS	MINOR CO	OLLECTORS	RAILROAD RI	GHTS-OF-WAY
	REQUIRED	PROPOSED	REQUIRED	PROPOSED	REQUIRED	PROPOSED
PERFORMANCE AND SOCIAL FACILITIES	35'	38.2'	30'	65'	50'	332'
HOUSING FACILITIES	35'	39'	30'	30'	50'	61.6'
PARKING STRUCTURES	120'	169.5'	20'	21'	30'	30'
SURFACE PARKING LOTS	60'	237.7'	60'	103'	5'	12'
RETAIL SUBORDINATE USES	35'	39'	30'	30'	50'	234.4'

PROJECT SERIAL NO. 20112071972 CALL BEFORE YOU DIG! PENNSYLVANIA LAW REQUIRES 3 WORKING DAYS NOTICE FOR CONSTRUCTION PHASE AND 10 WORKING DAYS IN DESIGN STAGE - STOP CALL Pennsylvania One Call System, Inc.

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VILLANOVA BUILDING HEIGHT CALCULATIONS STEAM PLANT AVERAGE BUILDING HEIGHT EXG GRADE | FLOOR LEVEL | FROM FLOOR MENDEL SCIENCE CENTER 438.5 439.0 ST. AUGUSTINE CENTER 435.0 437.0 436.0 SAC PARKING GARAGE BUILDING 1 44.3 494 PROPOSED PARKING SPACES 435.0 43.2 (2 ADDITIONAL LEVELS) **BUILDING 2B** 430.8 430.0 43.9 MEMORIAL 435.0 44.0 432.3 43.7 44.8 (<45) 433.3 PIKE GARAGE 427.8 44.0 37.9 (<38) 421.7 47.3 49.9 (<50) 434.5 PAC FLY TOWER 432.0 434.5 61.5 64.1 (<65) DRISCOLL TENNIS COURT: KENNEDY PARKING GARAGE **ALUMI HALL** CONNELLY CENTER HEALTH SERVICES TOLENTINE HALL DAVIS CENTER ST. THOMAS MONASTERY **AUSTIN HALL** ST. RITA HALL VASEY HALL **DOUGHERTY BARTLEY** Constitution of the same ST. THOMAS OF -– MILITARY SCIENCES BUILDING VILLANOVA CICD DISTRICT MIDDLETON **PEDESTRIAN** BRIDGE JAKE NEVIN FIELDHOUSE BUTLER VILLANOVA **PERFORMING** THE THE PARTY OF T ARTS CENTER R-3 GARAGE the first bounds TRIANGLE 5.18 AC. TOTAL PIKE SOFTBALL FIELD TO BE PRESERVED ADDITIONAL AREA TO BE PRESERVED = 3.18 AC PRESERVATION AREA; TO SATISFY MINIMUM CICD REQUIREMENTS = 2.00 AC.* STANFORD HALL FINAL CONDITIONAL USE APPLICATION CONDITIONS: AND NOW, THIS 24™ DAY OF NOVEMBER, 2014, AFTER DUE DELIBERATION AND DISCUSSION AT PUBLIC HEARINGS, THE RADNOR ST. MONICA TOWNSHIP BOARD OF COMMISSIONERS DOES HEREBY GRANT THE CONDITIONAL USE APPLICATION OF VILLANOVA UNIVERSITY, HALL SUBJECT TO THE FOLLOWING CONDITIONS: 1. THE APPLICANT SHALL COMPLY WITH ALL OTHER APPLICABLE TOWNSHIP ORDINANCES AND SHALL SUBMIT A LAND DEVELOPMENT PLAN PURSUANT TO THE TOWNSHIP'S SUBDIVISION AND LAND DEVELOPMENT ORDINANCE PRIOR TO THE SOUTH *ALDWYN TRIANGLE: CONSTRUCTION OF ANY FACILITIES. THAT THE TRANSPORTATION, ROADWAY AND SIGNALIZATION AND IMPROVEMENTS NECESSARY FOR THE CONSTRUCTION CAMPUS LAND PRESERVATION CALCULATIONS HAVE FULL ACCESS TO ITHAN AVENUE FROM BOTH THE PIKE LOT PARKING GARAGE AND LANCASTER AVENUE HOUSING PARKING AREA WITH PROVISIONS FOR STOP CONTROL FOR BOTH PARKING ACCESSES TO ITHAN AVENUE AND A PEDESTRIAN ACTIVATED SIGNAL INCLUDING THE NEW PEDESTRIAN CROSSWALK BE REQUIRED IF APPROVED BY ALLOWABLE BUILDING COVERAGE: 13.81 AC x .30 = 4.14 ACRESKATHERINE ZONING DISTRICT TABLE PENNDOT, UNLESS WAIVED BY THE BOARD OF COMMISSIONERS DURING THE LAND DEVELOPMENT PROCESS. DURING THE LAND DEVELOPMENT PROCESS. PROPOSED BUILDING/STRUCTURE COVERAGE: 4.90 ACRES C-1 LOCAL COMMERCIAL DISTRICT THAT DURING THE LAND DEVELOPMENT PROCESS AN EVENT CIRCULATION PLAN BE DEVELOPED TO ADDRESS EVENT PROPOSED BUILDINGS = 2.99 AC PROPOSED GARAGE = 1.91 AC CO COMMERCIAL-OFFICE DISTRICT PARKING AND TRAFFIC CIRCULATION WITH THE INPUT OF THE RADNOR TOWNSHIP POLICE DEPARTMENT AND TOWNSHIP TRAFFIC PI PLANNED INSTITUTIONAL DISTRICT ENGINEER OUTLINING PROCEDURES, TRAFFIC PATTERNS, PARKING CONFIGURATIONS AND WAY FINDING TECHNIQUES FOR THE VARIOUS SPORTING AND OTHER EVENTS HELD AT THE UNIVERSITY. UPON DEVELOPMENT OF THE EVENT BUILDING COVERAGE ABOVE 30% = 0.76 ACRES (4.90 - 4.14) R-2 RESIDENCE DISTRICT CIRCULATION PLAN, VILLANOVA SHALL BE RESPONSIBLE FOR CONSTRUCTING AND/OR INSTALLING SUCH SIGNS, R-3 RESIDENCE DISTRICT STRUCTURES, OR OTHER DIRECTIONAL AIDS NECESSARY TO IMPLEMENT THE EVENT CIRCULATION PLAN. REQUIRED LAND PRESERVATION = $0.76 \times 2 = 1.52$ ACRES R-4 RESIDENCE DISTRICT THAT VILLANOVA UNIVERSITY CONTRIBUTES THE SUM OF ONE HUNDRED SEVENTY-FIVE THOUSAND DOLLARS (\$175,000.00) CAUGHLIN TOWARDS THE DESIGN, APPROVAL AND INSTALLATION OF A TRAFFIC ADAPTIVE SIGNAL SYSTEM THAT WOULD PROPOSED UNRESTRICTED LAND PRESERVATION AREA = 2.00 ACRES INCORPORATE THE FOLLOWING SIGNALIZED INTERSECTIONS ALONG LANCASTER AVENUE: PROPOSED LAND PRESERVATION AREA PER CONDITIONAL USE DECISION #7 = 5.18 ACRES SPROUL ROAD / SPRING MILL ROAD; ALDWYN LANE / KENILWORTH STREET CHURCH WALK ITHAN AVENUE **LOWRYS LANE** AIRDALE ROAD **GENERAL NOTES:** COUNTY LINE ROAD . THIS PLAN IS BASED ON A SURVEY CONDUCTED IN THE FIELD BY NAVE NEWELL, INC., AND COMPLETED AUGUST 8, 2011. THAT DURING THE LAND DEVELOPMENT PROCESS AN EMERGENCY EVACUATION PLAN FOR THE NEW STUDENT HOUSING 2. PROPERTY AS SHOWN IS IN NON-FLOOD PRONE COMMUNITY AS DEPICTED ON THE FEDERAL EMERGENCY AGENCY FIRM THAT APPROPRIATE FENCING BE PROVIDED ON BOTH THE NORTH AND SOUTH SIDES OF LANCASTER AVENUE IN THE AREA FLOOD INSURANCE RATE MAP COMMUNITY PANEL NO. 42045C0050F PER NO. 42045CINDOA, MAP REVISED NOVEMBER 18, 2009. 3. LOCATIONS OF EXISTING UTILITIES AS SHOWN HEREIN HAVE BEEN DEVELOPED FROM EXISTING UTILITY RECORDS, PLANS BY OF THE CHURCH WALK PEDESTRIAN BRIDGE IN AN EFFORT TO RESTRICT PEDESTRIAN TRAFFIC FROM ACCESSING THE LEGEND

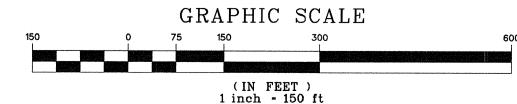CAMPUS. A GATE SHALL BE PROVIDED FOR VEHICULAR AND PEDESTRIAN ACCESS DURING CHURCH EVENTS IF

APPROVED BY THE BOARD OF COMMISSIONERS DURING THE LAND DEVELOPMENT APPROVAL PROCESS. THAT THE UNIVERSITY PRESERVE THE ENTIRE AREA KNOWN AS THE ALDWYN TRIANGLE AND RESTRICT IT AS OPEN SPACE EXCEPT FOR THAT PORTION OF THE AREA NECESSARY TO PROVIDE PEDESTRIAN ACTIVITY AND HANDICAP ACCESSIBILITY IMPROVEMENTS FOR THE ADJACENT SEPTA RAIL LINE.
THAT A LANDSCAPE AND BUFFER PLAN BE DEVELOPED TO COMPLY WITH SECTION 280-68.1.D.(3)(b) OF THE ZONING

THAT VILLANOVA SEEK PERMISSION FROM PECO TO PLANT SCREENING ON THE SOUTH SIDE OF THE PECO R-100 LINE TO VISUALLY SCREEN THE SEPTA BRIDGE FROM THE ADJACENT RESIDENTIAL NEIGHBORS. PROVIDED THAT THE APPLICANT RECEIVES PERMISSION, VILLANOVA SHALL PROVIDE AN INSTALLATION AND MAINTENANCE PLAN OF THE VEGETATION NECESSARY FOR THIS SCREENING DURING LAND DEVELOPMENT.

AND THEIR ADDRESSES WITHIN TWENTY (20) DAYS OF THE EXECUTION OF ANY CONTRACTS BY VILLANOVA IN CONNECTION WITH THE DEVELOPMENT AND/OR CONSTRUCTION OF THE PROPOSED PROJECT. THE PURPOSE OF THIS LIST IS TO PERMIT THE TOWNSHIP TO AUDIT FOR REQUIRED BUSINESS PRIVILEGE/MERCANTILE TAXES. DURING THE LAND DEVELOPMENT PROCESS, THE APPLICANT SHALL USE ITS BEST EFFORTS TO DEVELOP AND CONSTRUCT ORMWATER MANAGEMENT FACILITIES, INCLUDING GREEN INFRASTRUCTURE PRACTICES AND COMPONENTS THAT MEET OR EXCEED INFILTRATION OR RETENTION REQUIREMENTS AS CURRENTLY REQUIRED BY THE RADNOR TOWNSHIP STORMWATER MANAGEMENT ORDINANCE. THE APPLICANT SHALL CONDUCT SOIL TESTING AS NECESSARY TO DETERMINE WHETHER THE SITE CAN ACCOMMODATE VOLUME MANAGEMENT IN EXCESS OF 1-INCH OF RUN-OFF FROM ALL IMPERVIOUS SURFACES RESULTING FROM THE PROJECT. IF SOIL TESTING INDICATES THAT IT IS POSSIBLE TO PROVIDE VOLUME MANAGEMENT IN EXCESS OF 1-INCH OF RUN-OFF, THE APPLICANT SHALL CONSTRUCT SUCH NECESSARY TORMWATER FACILITIES ON THE SITE TO ACCOMMODATE THIS INCREASED VOLUME.

THE APPLICANT SHALL OBTAIN REVISIONS TO BOTH THE RADNOR TOWNSHIP AND LOWER MERION TOWNSHIP ACT 537 PLANS IN ORDER TO ACCOMMODATE THE INCREASED WASTEWATER DISPOSAL GENERATED BY THE PROJECT. THE APPLICANT SHALL DEVELOP A TRAFFIC PLAN DURING THE LAND DEVELOPMENT PROCESS DELINEATING THE PATHS BY WHICH THE EXISTING POPULATION OF COMMUTING AND PART-TIME STUDENTS WILL BE DIRECTED TO AND FROM PARKING FOR EACH PHASE OF THE CONSTRUCTION

10. VILLANOVA SHALL PROVIDE RADNOR TOWNSHIP A LIST OF CONTRACTORS, SUBCONTRACTORS AND VENDORS

THE APPLICANT SHALL PERMIT PARISHIONERS TO PARK, ON A SPACE AVAILABLE BASIS, ON THE NORTH SIDE OF LANCASTER AVENUE ON EXISTING VILLANOVA PROPERTY ADJACENT TO THE CHURCH FOR CHURCH RELATED EVENTS. THE APPLICANT SHALL MAINTAIN A PEDESTRIAN CROSSWALK FROM THE PROPOSED PROJECT SITE TO THE EXISTING CHURCH AT THE PRESENT CHURCH WALK LOCATION IF APPROVED BY PENNDOT

THE SOUTH FACING DORMITORIES. DURING THE LAND DEVELOPMENT PROCESS, THE TOWNSHIP AND APPLICANT SHALL ESTABLISH A PERMISSIBLE SOUND LEVEL AT THE PROPERTY BOUNDARY OF THE ALDWYN LANE RESIDENTIAL USES. THE APPLICANT'S LAND DEVELOPMENT PLANS SHALL BE IN SUBSTANTIAL CONFORMITY WITH THE CONDITIONAL USE PLANS DATED MAY 2, 2014 AS AMENDED DURING THE HEARINGS.

THE APPLICANT SHALL INSURE THAT NO AMPLIFIED MUSIC OR OTHER EXCESSIVE NOISE SHALL EMANATE FROM ANY OF

OTHERS AND/OR ABOVE GROUND EXAMINATION OF SITE. THE COMPLETENESS OR ACCURACIES OF THE LOCATIONS ARE NOT GUARANTEED. SHOULD ANY NEW CONSTRUCTION BE PROPOSED, THE CONTRACTOR MUST VERIFY LOCATIONS AND DEPTHS OF ALL UTILITIES BEFORE START OF WORK 4. NO REVIEW OF THE PROPERTY REGARDING THE PRESENCE OF WETLANDS WAS ACCOMPLISHED AS A PART OF THIS SURVEY 5. NO REVIEW OF THE PROPERTY REGARDING THE PRESENCE OF HAZARDOUS MATERIAL WAS ACCOMPLISHED AS A PART OF

ALL PROPOSED UTILITIES IN CONJUNCTION WITH THIS SITE SHALL BE PLACED UNDERGROUND. 8. PURSUANT TO SECTION 420 OF THE ACT OF JUNE 1, 1945, (PL1242, NO. 428), KNOWN AS THE "STATE HIGHWAY LAW", PENNDOT HIGHWAY OCCUPANCY PERMITS ARE REQUIRED FOR ANY PROPOSED CONSTRUCTION WITHIN THE RIGHT-OF-WAY OF LANCASTER AVENUE, S.R. 0030. ALL CONSTRUCTION IS TO BE IN COMPLIANCE WITH THE STANDARDS AND SPECIFICATIONS OF RADNOR TOWNSHIP. 10. THE PROPOSED BUILDING FOOTPRINTS NOTED ON THE PLAN ARE SCHEMATIC. THE ACTUAL ARCHITECTURAL PLANS SHALL BE UTILIZED FOR BUILDING CONSTRUCTION AND MUST BE NO LARGER THAN SCHEMATIC FOOTPRINT SHOWN, THE PROPOSED

GRADING AND UTILITY CONNECTIONS ARE TO BE COORDINATED WITH THE ARCHITECTURAL PLANS, PRIOR TO CONSTRUCTION.

6. THE PROPOSED USES ARE TO BE SERVICED BY PUBLIC SEWER (LOWER MERION TOWNSHIP) AND PUBLIC WATER (AQUA PA).

TO AVOID ANY CONFLICTS. THE CONTRACTOR SHOULD NOTIFY THE OWNER OF ANY DISCREPANCIES PRIOR TO CONSTRUCTION. 11. THE PROPOSED SEWER AND WATER SERVICE CONNECTIONS ARE TO BE COORDINATED WITH THE ARCHITECTURAL PLANS TO ENSURE EXACT LOCATION. THE CONTRACTOR IS RESPONSIBLE FOR VERIFYING ALL UTILITY CONNECTION LOCATIONS, AND SHOULD NOTIFY THE OWNER OF ANY DISCREPANCIES PRIOR TO CONSTRUCTION. 12. THE OWNER SHALL HAVE THE RESPONSIBILITY FOR THE PERPETUAL MAINTENANCE OF THE PERMANENT STORM WATER DETENTION BASINS AND BASIN OUTLET STRUCTURES. NO CHANGES SHALL BE MADE TO THE STRUCTURES, PIPES OR FINISH GRADING WITHOUT PRIOR WRITTEN APPROVAL FROM THE TOWNSHIP

13. NO BUILDING OR OBSTRUCTION THAT WOULD OBSCURE THE VISION OF A MOTORIST SHALL BE PERMITTED WITHIN THE CLEAR-SIGHT TRIANGLE 14. THE PROJECT WILL REQUIRE A "GENERAL NPDES PERMIT" FROM THE PENNSYLVANIA DEPARTMENT OF ENVIRONMENTAL PROTECTION SUBJECT TO OBTAINING APPROVED EROSION AND SEDIMENTATION CONTROL PLANS FROM THE DELAWARE COUNTY CONSERVATION DISTRICT, PRIOR TO CLEARING OR EARTH MOVING ACTIVITY. 15. ALL CURVED SECTIONS OF CURBING SHALL HAVE A FIVE FOOT RADIUS (R=5"), UNLESS NOTED OTHERWISE AS SHOWN ON

16. THE INTENDED USE OF THE PROPOSED BUILDINGS ARE FOR STUDENT HOUSING AND ASSOCIATED RETAIL. 17. ULTIMATE RIGHT-OF-WAY OF ITHAN AVENUE, AS SHOWN, IS OFFERED FOR DEDICATION TO RADNOR TOWNSHIP AS PART OF 18. GRADING AND EROSION CONTROL PLANS MUST BE SUBMITTED AND APPROVED PRIOR TO ISSUANCE OF BUILDING PERMITS 19. NOISE EMANATING FROM THE SOUTH- FACING DORMS SHALL NOT 55 dBA AT NIGHTTIME AT THE PROPERTY BOUNDARY OF THE

ALDWYN LANE RESIDENTIAL USES.

PROPERTY LINE — — — — BUILDING SETBACK LINE ----- PARKING SETBACK LINE ---- LEGAL RIGHT-OF-WAY LINE ---- EXISTING CURB EXISTING EDGE OF PAVEMENT EXISTING BUILDING --- - EXISTING FENCE EXISTING RETAINING WALL EXISTING WETLANDS LIMITS OF CICD DISTRICT PROPOSED RIGHT-OF-WAY LINE - PROPOSED EDGE OF PAVEMENT PROPOSED BUILDING --- PROPOSED DECORATIVE FENCE — PROPOSED RETAINING WALL

MINIMUM REQUIRED PRESERVATION AREA

ADDITIONAL PRESERVATION AREA PROVIDED

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Villanova University

Lancaster and Ithan Avenues

Villanova PA 19085

VMA

Church Walk and Bridge

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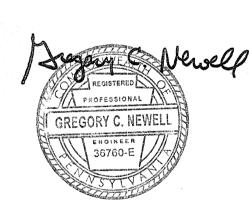
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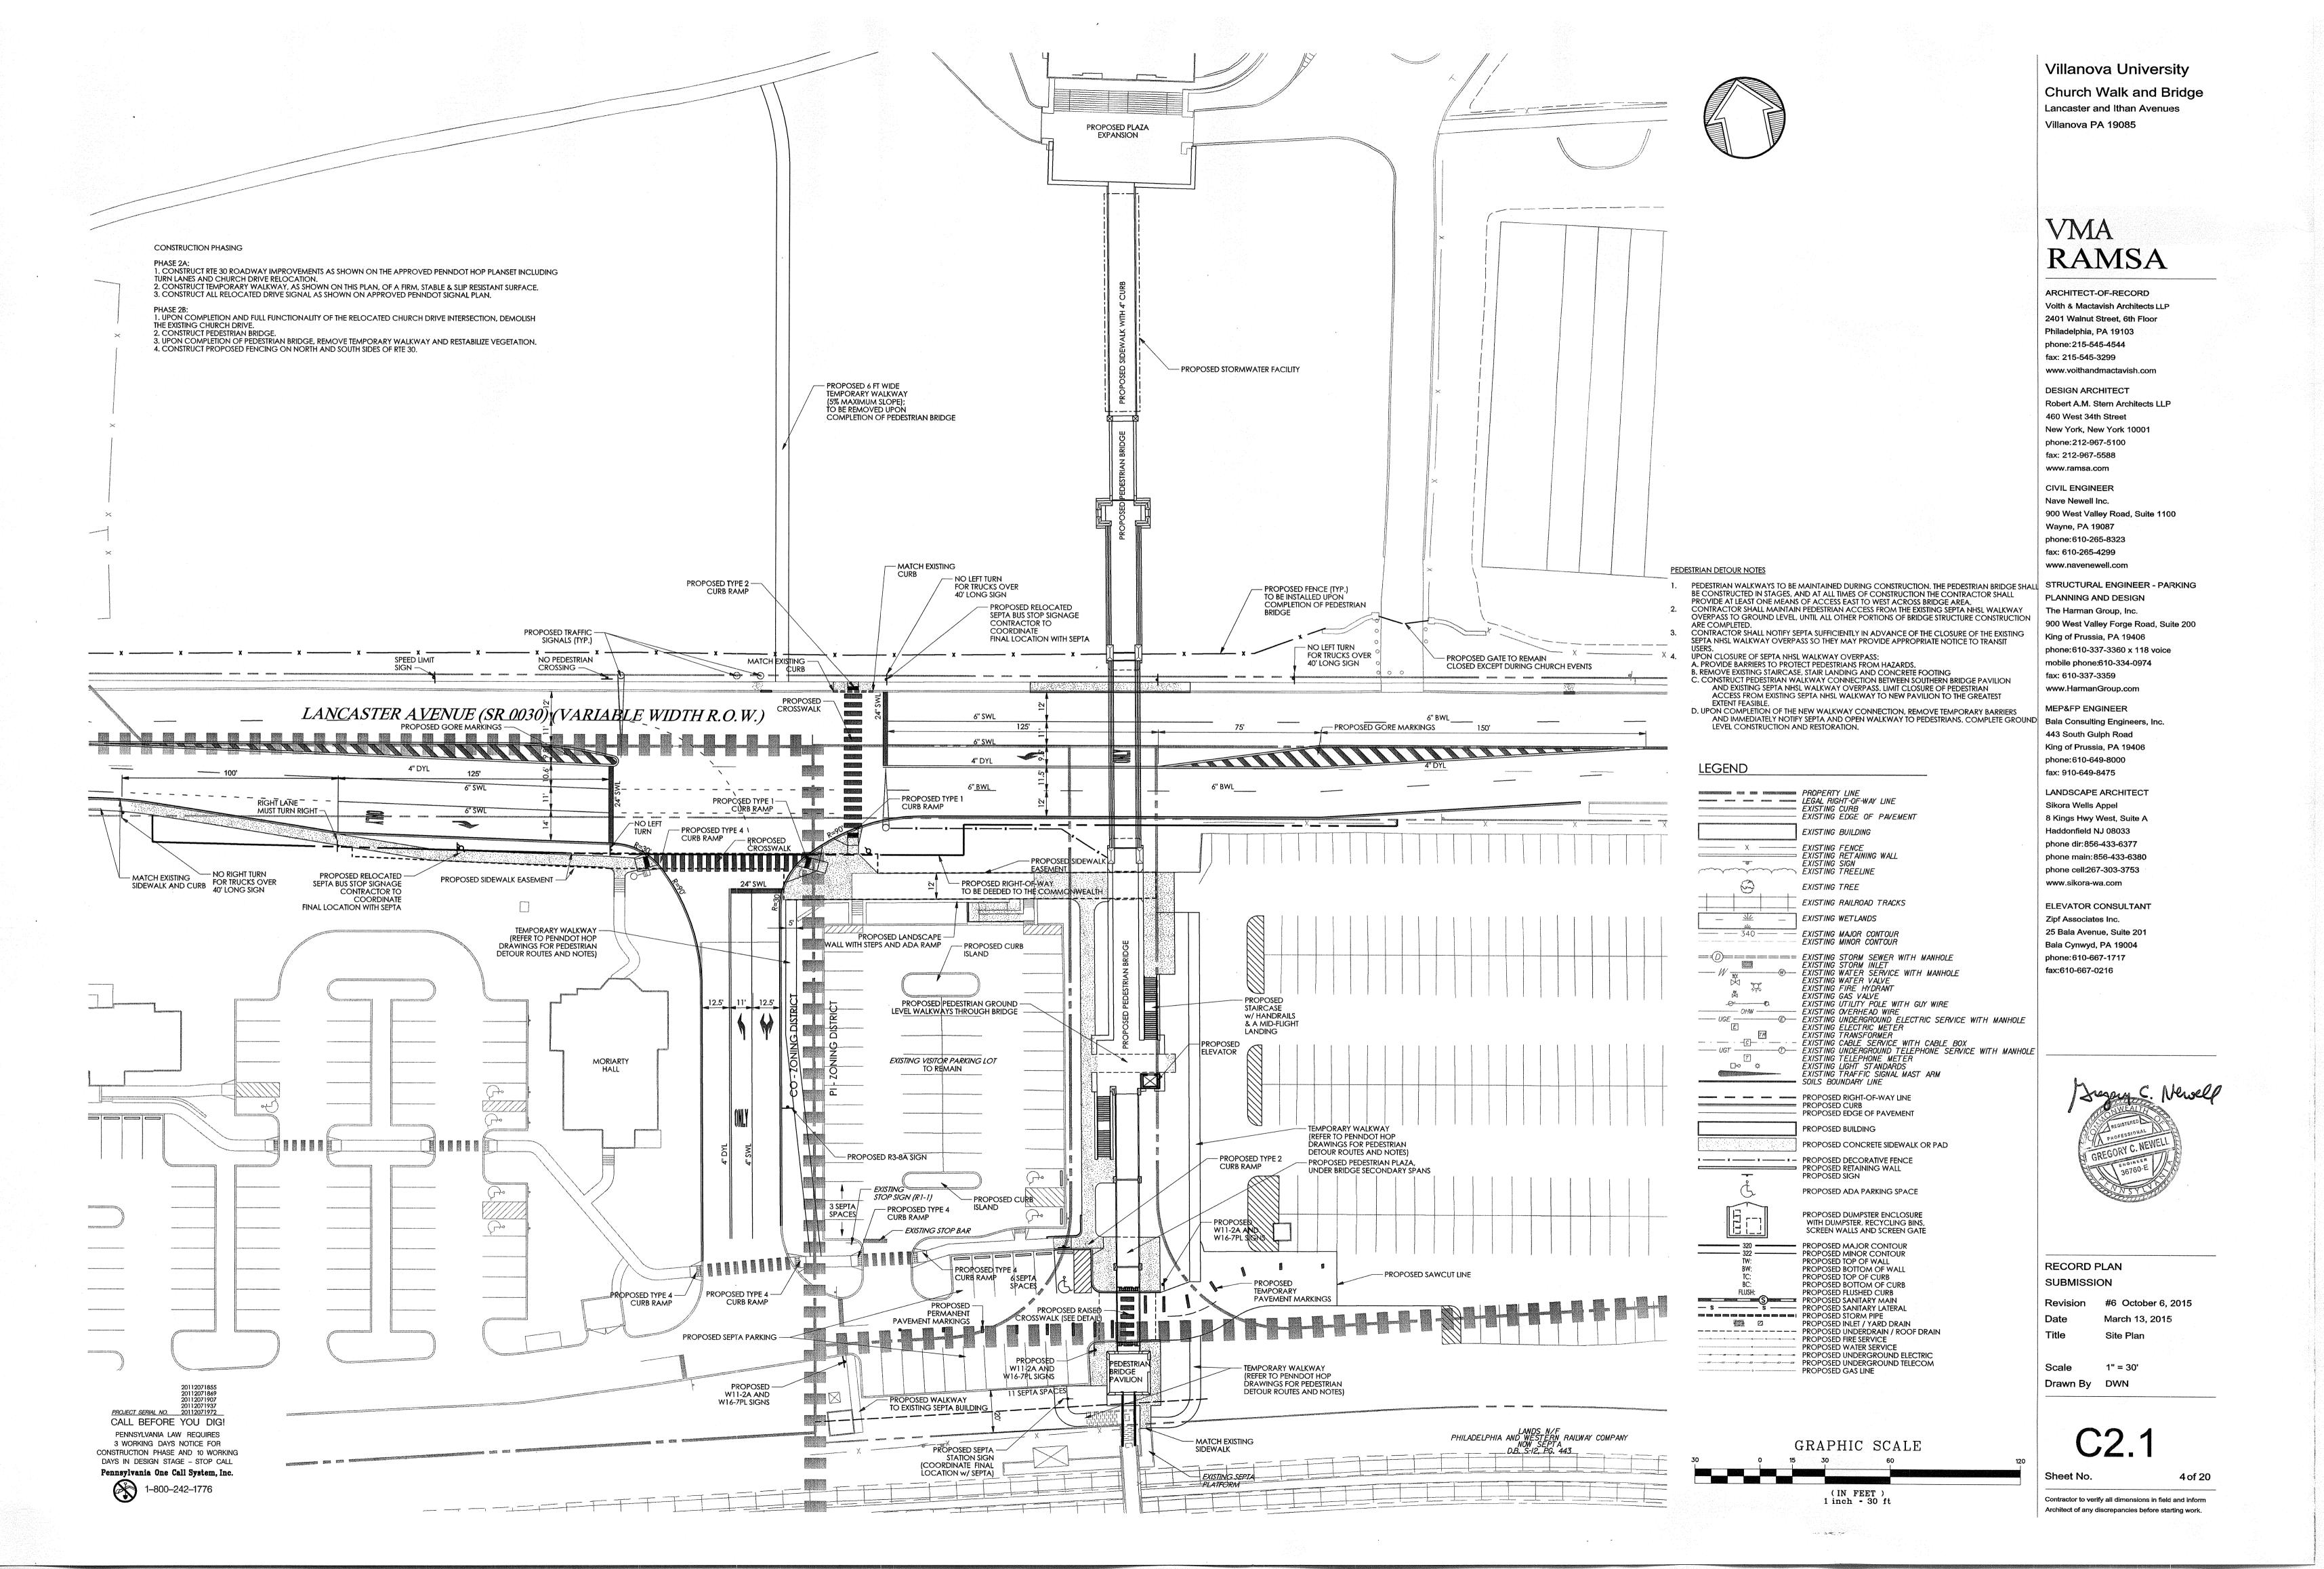
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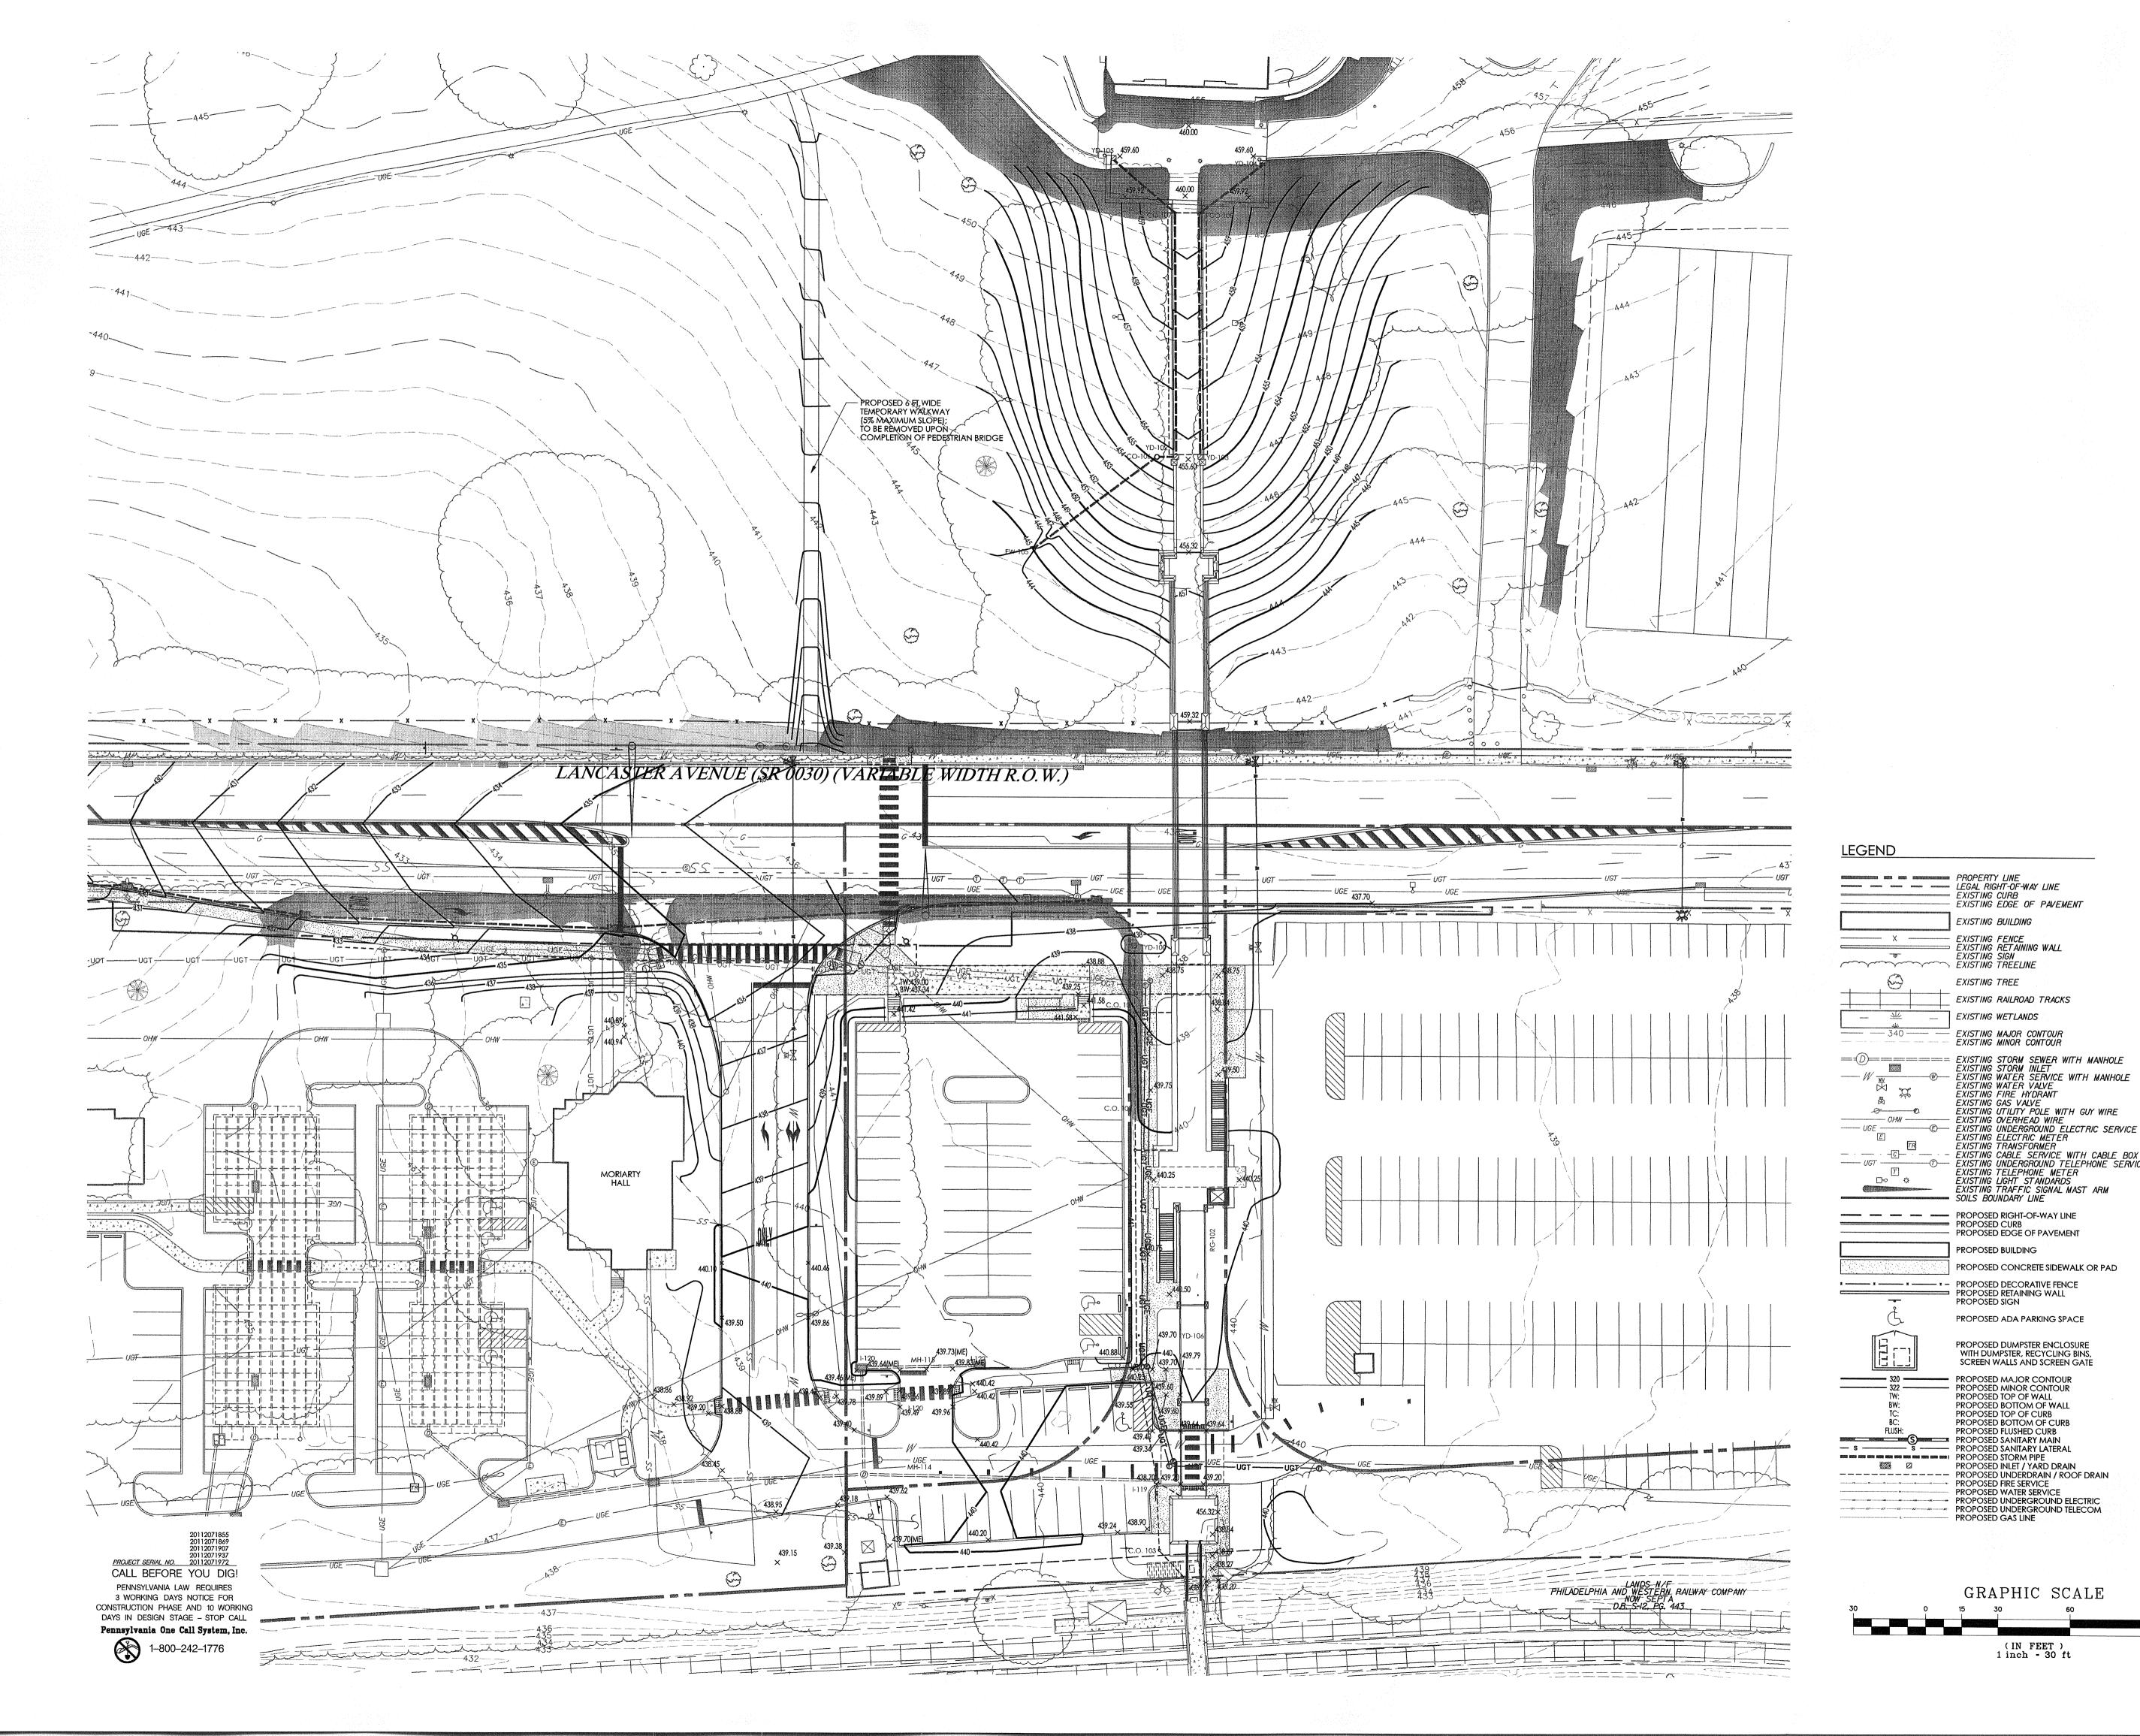
#6 October 6, 2015 March 13, 2015 Composite Site Plan

1" = 150' Scale Drawn By MMB

Architect of any discrepancies before starting work.

Contractor to verify all dimensions in field and inform





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EXISTING EDGE OF PAVEMENT

EXISTING BUILDING

EXISTING SIGN EXISTING TREELINE

EXISTING WETLANDS

EXISTING TREE

EXISTING FENCE EXISTING RETAINING WALL

EXISTING RAILROAD TRACKS

EXISTING MAJOR CONTOUR EXISTING MINOR CONTOUR

EXISTING OVERHEAD WIRE

SOILS BOUNDARY LINE

PROPOSED BUILDING

PROPOSED SIGN

EXISTING GAS VALVE EXISTING UTILITY POLE WITH GUY WIRE

PROPOSED CONCRETE SIDEWALK OR PAD

PROPOSED ADA PARKING SPACE

PROPOSED DUMPSTER ENCLOSURE WITH DUMPSTER, RECYCLING BINS, SCREEN WALLS AND SCREEN GATE

PROPOSED MAJOR CONTOUR

PROPOSED BOTTOM OF WALL PROPOSED TOP OF CURB PROPOSED BOTTOM OF CURB

PROPOSED INLET / YARD DRAIN

GRAPHIC SCALE

(IN FEET) 1 inch - 30 ft

PROPOSED WATER SERVICE


PROPOSED GAS LINE

PROPOSED FLUSHED CURB

PROPOSED TOP OF WALL

- EXISTING OVERHEAD WIRE
- EXISTING UNDERGROUND ELECTRIC SERVICE WITH MANHOLE
EXISTING ELECTRIC METER
EXISTING TRANSFORMER
- EXISTING CABLE SERVICE WITH CABLE BOX
- EXISTING UNDERGROUND TELEPHONE SERVICE WITH MANHOLE
EXISTING TELEPHONE METER
EXISTING LIGHT STANDARDS
EXISTING TRAFFIC SIGNAL MAST ARM
SOILS BOUNDARY LINE

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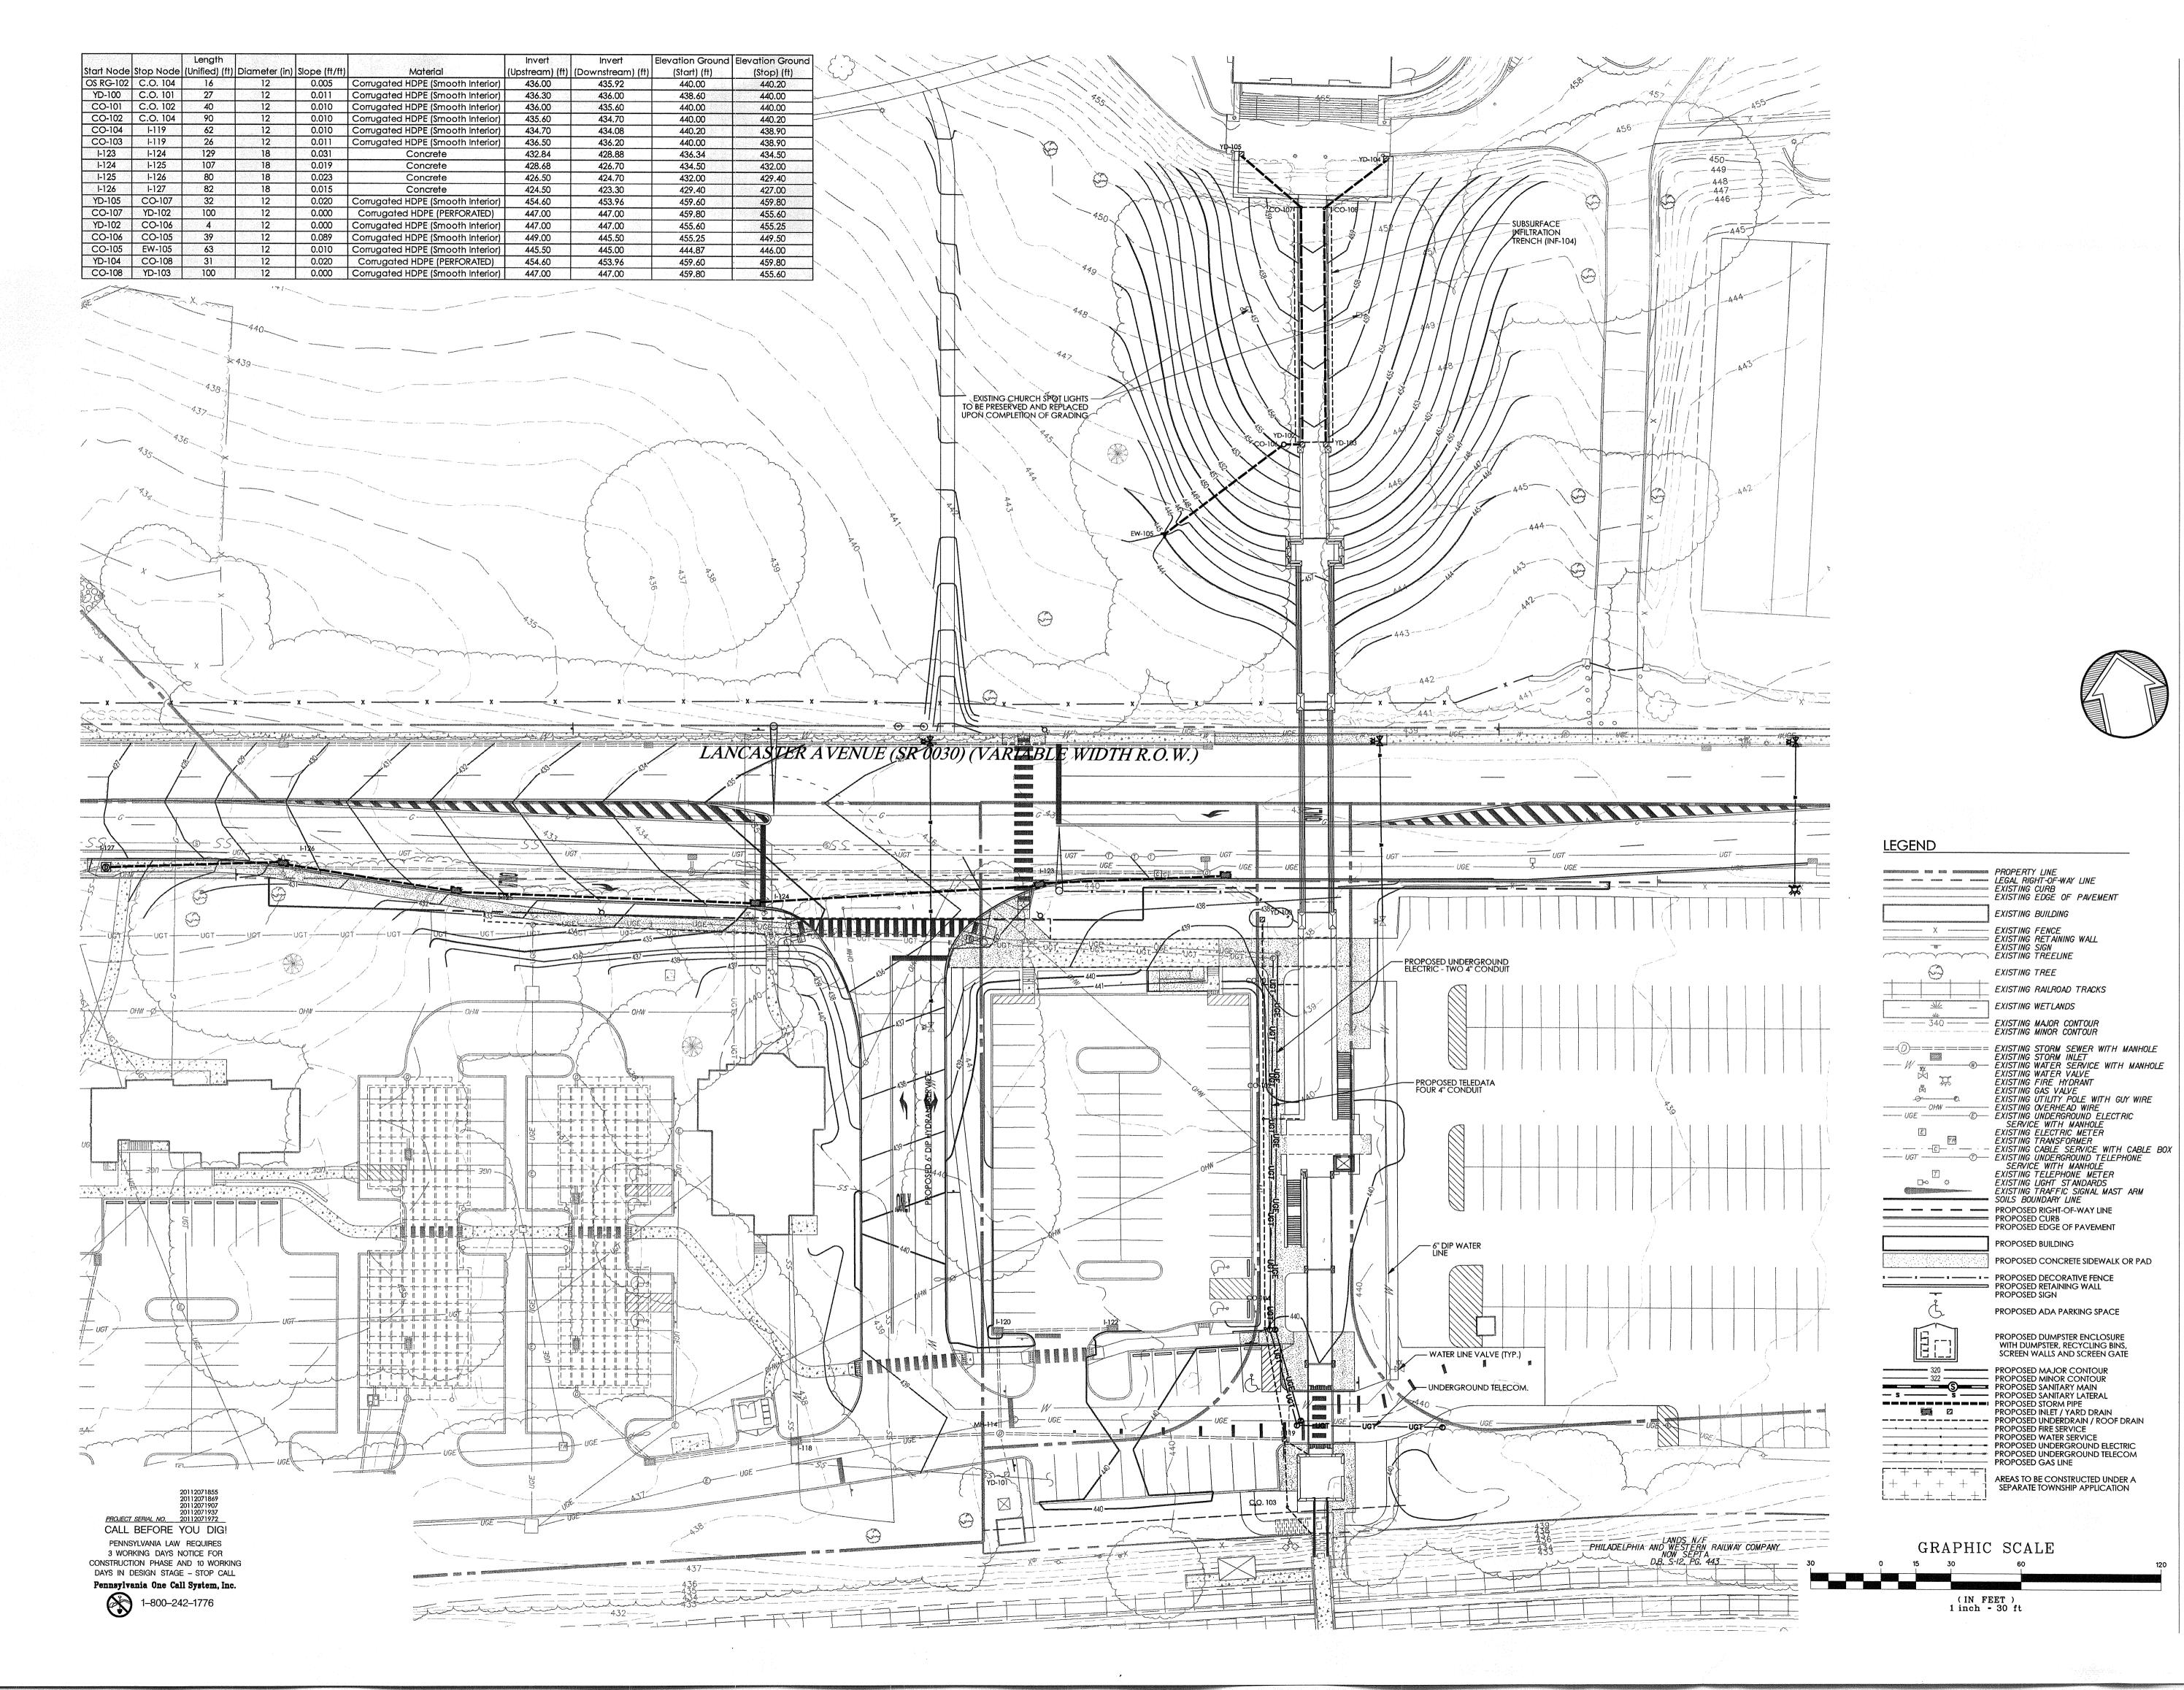


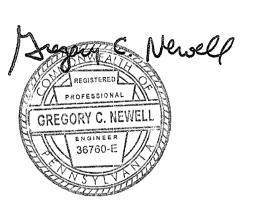RECORD PLAN SUBMISSION

Revision #6 October 6, 2015 March 13, 2015 Title Grading Plan

Scale 1" = 30' Drawn By DWN

Sheet No.



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EXISTING BUILDING

EXISTING TREE

EXISTING WETLANDS

EXISTING MAJOR CONTOUR
EXISTING MINOR CONTOUR

SERVICE WITH MANHOLE
EXISTING TELEPHONE METER
EXISTING LIGHT STANDARDS
EXISTING LIGHT STANDARDS
EXISTING LIGHT STANDARDS

PROPOSED CONCRETE SIDEWALK OR PAD

PROPOSED EDGE OF PAVEMENT

PROPOSED ADA PARKING SPACE

PROPOSED DUMPSTER ENCLOSURE WITH DUMPSTER, RECYCLING BINS, SCREEN WALLS AND SCREEN GATE

PROPOSED WATER SERVICE

AREAS TO BE CONSTRUCTED UNDER A SEPARATE TOWNSHIP APPLICATION

PROPOSED BUILDING

PROPOSED SIGN

EXISTING RAILROAD TRACKS

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#6 October 6, 2015 Revision Date March 13, 2015

Utility Plan


Scale 1" = 30' Drawn By DWN

Title

Architect of any discrepancies before starting work.

Sheet No.

Contractor to verify all dimensions in field and inform

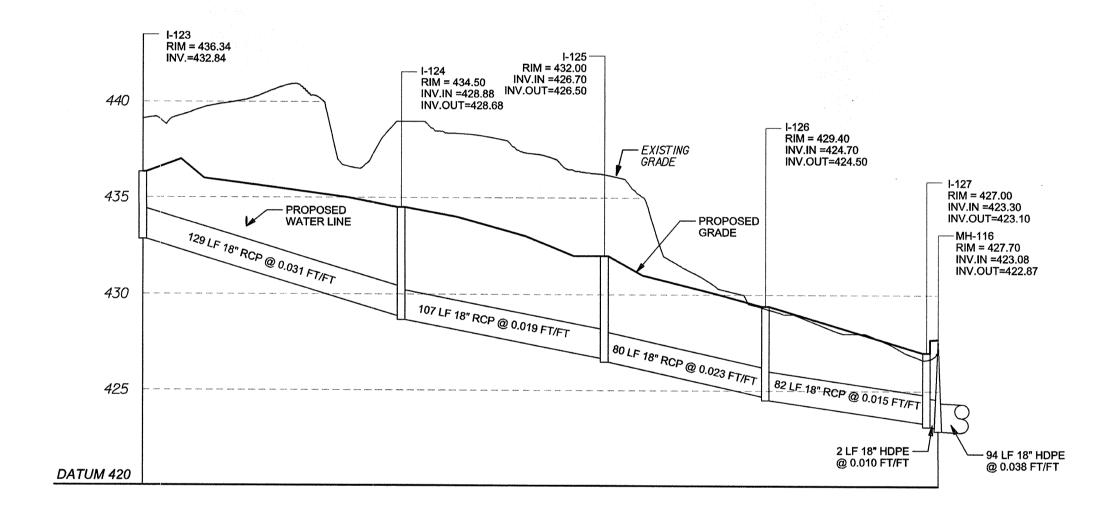

STORM PROFILE -I-123 TO MH-116

> SCALE: HORIZONTAL 1" = 50' VERTICAL 1" = 5'

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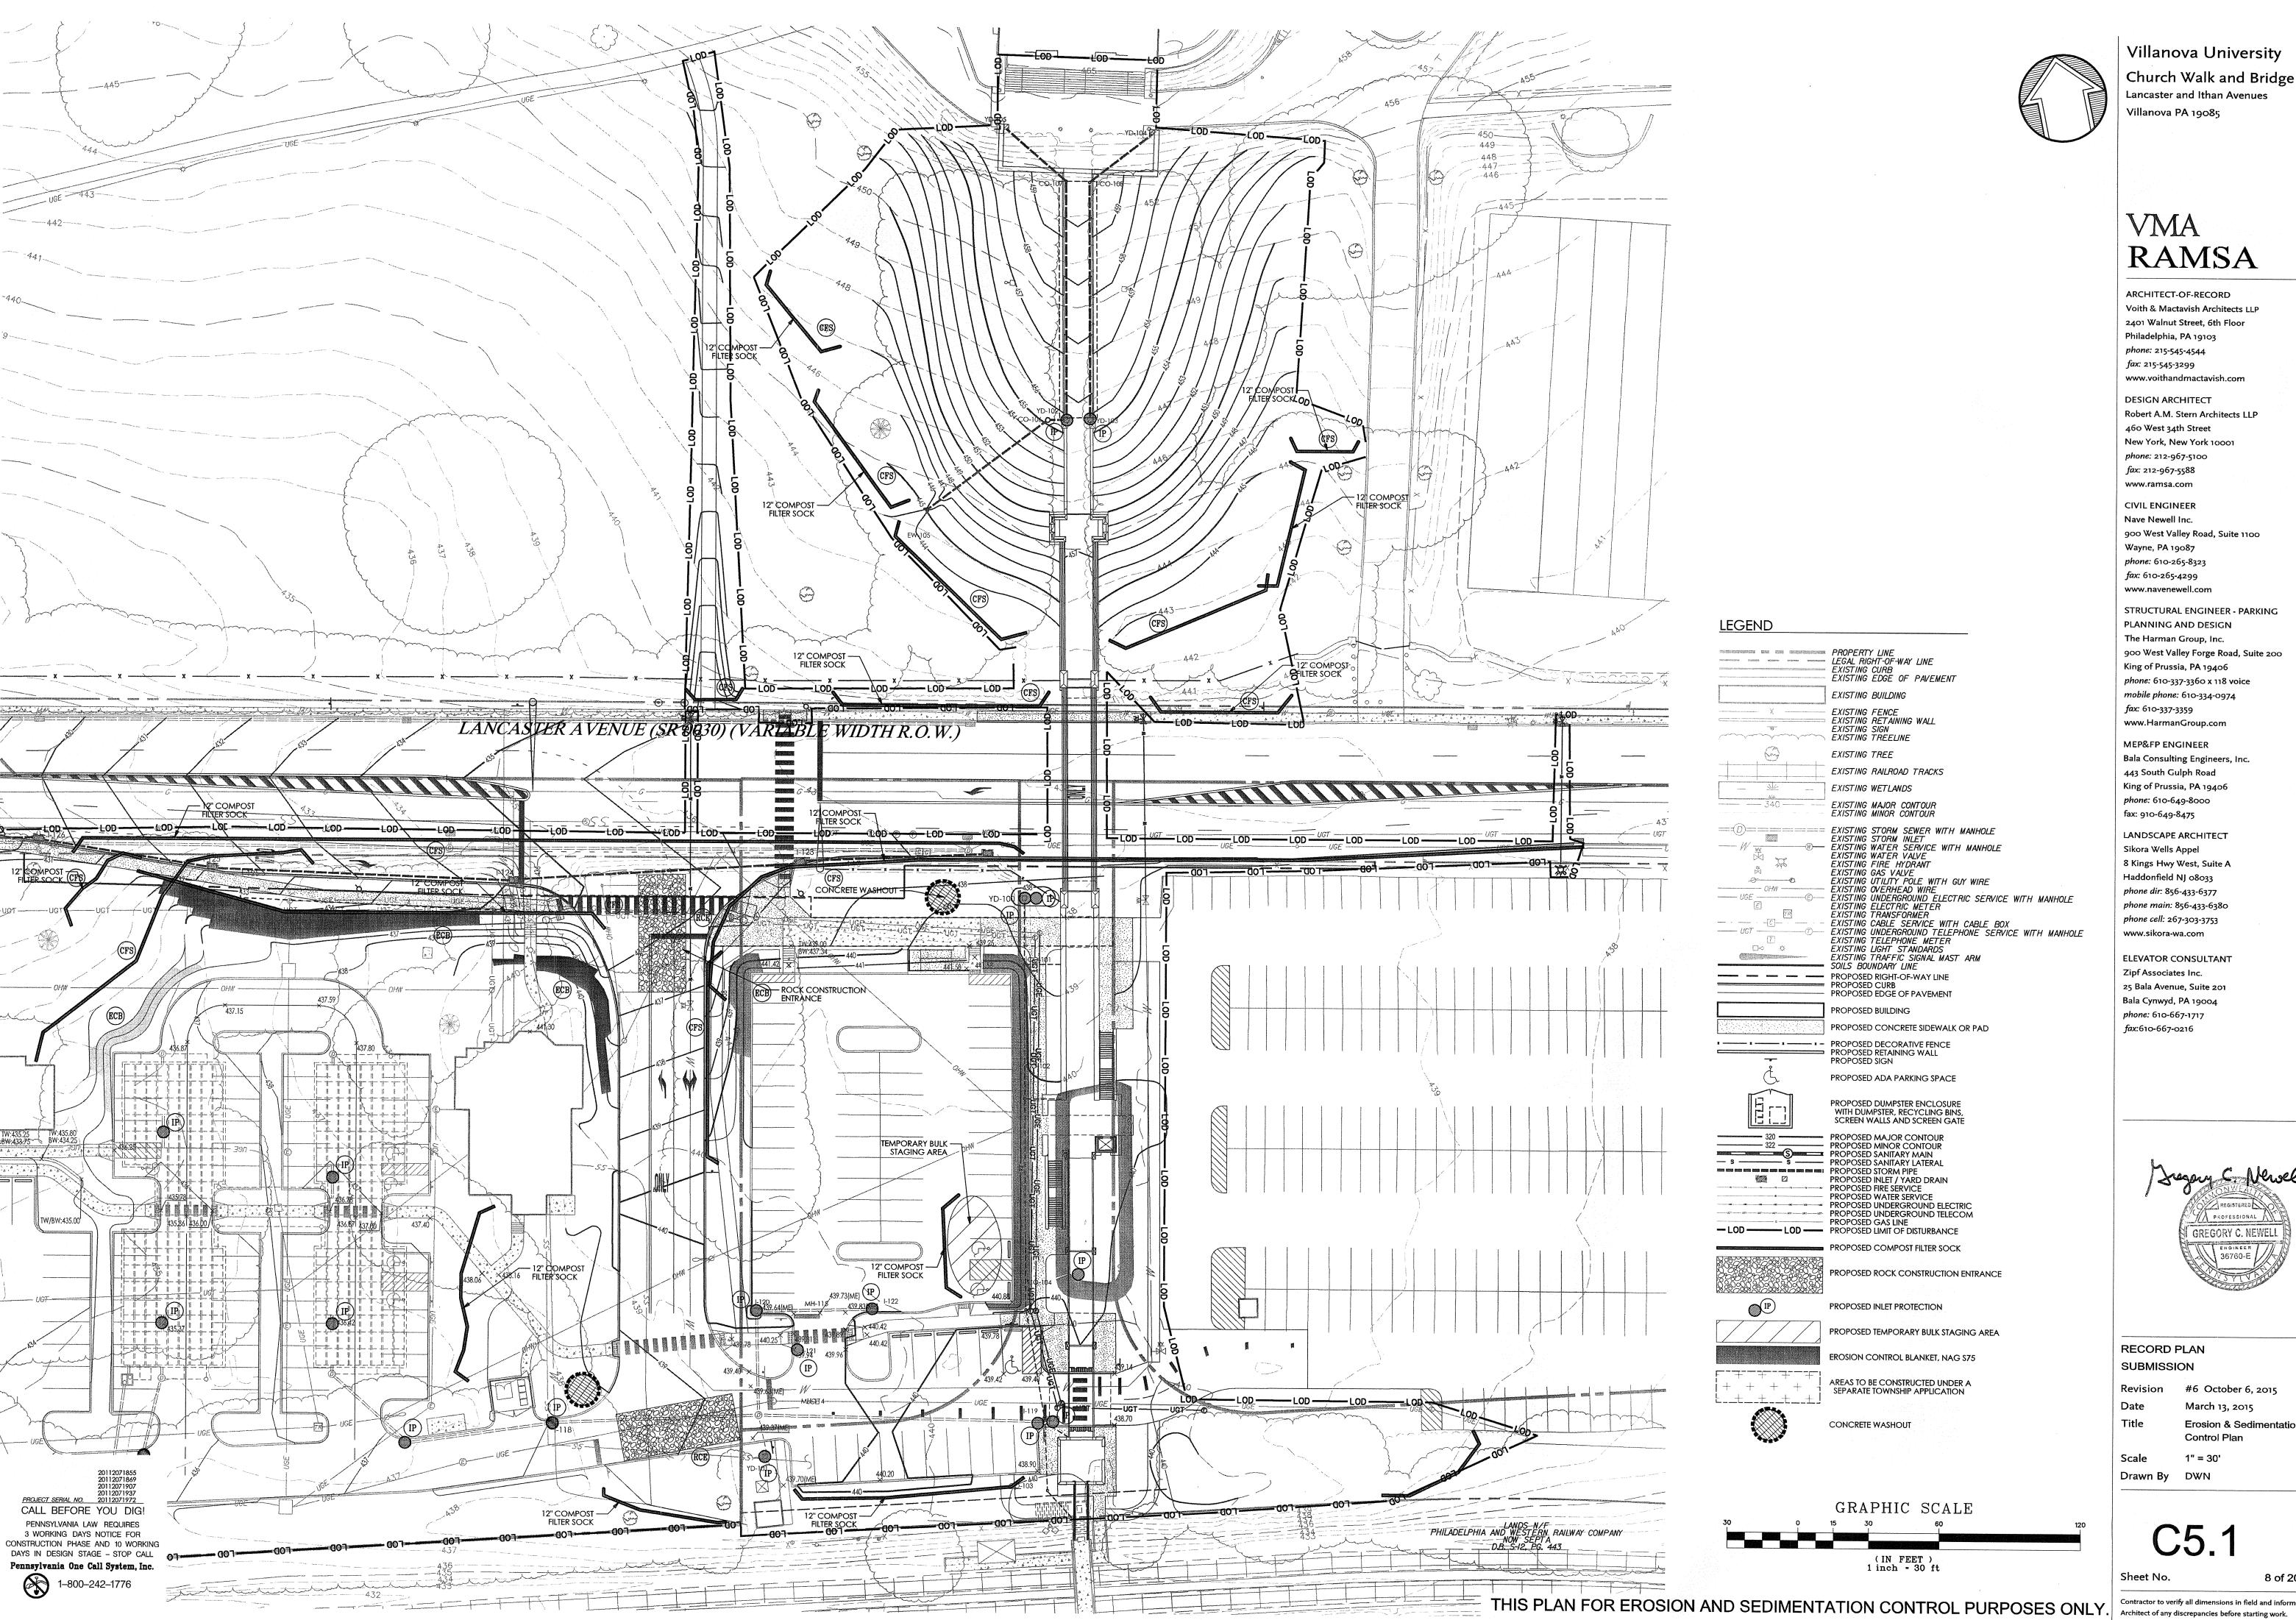
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Date March 13, 2015
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#6 October 6, 2015 Revision March 13, 2015 **Erosion & Sedimentation** Control Plan

Scale 1" = 30' Drawn By DWN

Sheet No.

GENERAL CONSERVATION NOTES AND SPECIFICATIONS

INTENT OF CONSERVATION PROGRAM: THE INTENT OF THIS PROGRAM IS TO PREVENT ACCELERATED EROSION OF THE EXPOSED SITE SOILS DURING THE CONSTRUCTION AND PERMANENT LIFE PERIODS OF THE DEVELOPMENT. THE PROGRAM REQUIRES RETENTION OF ALL SEDIMENTS ON THE CONSTRUCTION SITE TO MINIMIZE THE IMPACT OF DEVELOPMENT ON EXISTING STREAMS AND ADJACENT PROPERTY OWNERS. THESE OBJECTIVES WILL BE ACHIEVED BY MINIMIZING THE EXPOSURE TIME OF POTENTIALLY EROSIVE SOILS TO RUNOFF AND INSTALLATION OF THE TEMPORARY CONSTRUCTION. THE INTENT OF THIS PROGRAM SHOULD BE UNDERSTOOD AND IMPLEMENTED THROUGHOUT THE ENTIRE DEVELOPMENT. THE VARIOUS CONSTRUCTION TRADES SHOULD BE APPRAISED OF THIS PROGRAM AND DIRECTED TO PREVENT UNDUE DISTURBANCE OF PREPARED AND PROTECTED SURFACES.

SURFACE STABILIZATION CRITERIA: ALL DENUDED SOIL SURFACES, INCLUDING SOIL STOCKPILES, ARE SUBJECT TO EROSION AND SHALL BE STABILIZED EITHER TEMPORARII Y OR PERMANENTI Y IMMEDIATEI Y DURING NON-GERMINATION PERIODS, MULCH MUST BE APPLIED AT RECOMMENDED RATES. CRUSHED STONE ON PAVEMENT SUBGRADES CONSIDERED ADEQUATE PROTECTION. ALL DISTURBED ZONES AND VEGETATED REGIONS SHALL BE STABILIZED, PREFERABLY WITH A PERMANENT TREATMENT

SEEDING & MULCHING SPECIFICATIONS LIVE SEED PERCENTAGE SHALL BE 85% OR GREATER

TEMPORARY: SEEDING SHALL BE COMMON RYE GRASS APPLIED AT 45 LBS. PER ACRE. LIMING TO BE APPLIED AT 1 TON/ACRE 50-50-50 FERTILIZER TO BE APPLIED AT 1000 LBS/ACRE.

SEEDING SHALL BE 15% KENTUCKY BLUEGRASS, 35% KENTUCKY 31 FESCUE, 25% CHEWINGS FESCUE, 15% PERENNIAL RYE GRASS. AND 10% RECLEANED REDTOP AT A RATE OF 60 LBS. PER ACRE LIMING TO BE APPLIED AT 3 TONS/ACRE. 10-20-30 FERTILIZER TO BE APPLIED AT 1000 LBS/ACRE. HAY OR STRAW MULCH TO BE APPLIED AT 3 TONS/ACRE

HAY OR STRAW MULCH TO BE APPLIED AT 3 TONS/ACRE

THE NON-GERMINATING PERIODS ARE BETWEEN 6/15 THROUGH 8/15 AND 9/30 THROUGH 4/15. AREAS DISTURBED DURING THESE PERIODS MUST BE LIMED. FERTILIZED, SEEDED AND MULCHED IMMEDIATELY FOLLOWING THE FND OF THOSE PERIODS. TOPSOIL TAKEN FROM CONSTRUCTION AREAS SHALL BE SEEDED WITH VEGETATIVE COVER AND STOCKPILES FOR RE-USE IN FINISH GRADING. THERE IS O BE NO EARTH DISTURBANCE OR VEGETATIVE CLEARING IN AREAS OUTSIDE OF THE DELINEATED AREAS TO BE DISTURBED.

MAINTENANCE PROGRAM FOR TEMPORARY SEDIMENTATION CONTROLS STRUCTURES MAINTENANCE OF ALL TEMPORARY SEDIMENTATION CONTROL STRUCTURES SHALL BE THE RESPONSIBILITY OF THE DEVELOPER AND AS STATED BELOW

1. SEDIMENT MUST BE REMOVED WHEN ACCUMULATIONS REACH ONE-HALF THE EFFECTIVE HEIGHT OF COMPOST FILTER SOCKS.

2. SEDIMENT MUST BE REMOVED FROM ROCK FILTERS WHEN COLLECTED SEDIMENT BEGINS TO AFFECT THE FILTER'S FUNCTION. 3. INLET PROTECTION FILTER BAGS SHALL BE INSPECTED ON A WEEKLY BASIS AND AFTER EACH RAINFALL EVENT. BAGS SHALL BE EMPTIED AND RINSED OR REPLACED WHEN HALF FULL OR WHEN FLOW CAPACITY HAS BEEN REDUCED SO AS TO CAUSE FLOODING OR BYPASSING OF THE INLET. DAMAGED OR CLOGGED BADS SHALL BE REPLACED.

4. SEDIMENT REMOVED FROM THE FACILITIES MAY BE REINCORPORATED INTO THE SITE'S EARTHWORK AS FILL OR TAKEN TO A SAFE, APPROVED LOCATION. UNTIL THE SITE IS STABILIZED, ALL EROSION AND SEDIMENTATION CONTROLS MUST BE MAINTAINED PROPERLY. MAINTENANCE MUST INCLUDE INSPECTIONS OF ALL CONTROLS AFTER EACH STORM EVENT AND ON A WEEKLY BASIS. ALL PREVENTATIVE IND REMEDIAL MAINTENANCE, REGRADING, RESEEDING, REMULCHING AND RENETTING MUST BE PERFORMED IMMEDIATELY.

MAINTENANCE OF TEMPORARY SEDIMENTATION CONTROL STRUCTURES MAINTENANCE OF ALL TEMPORARY SEDIMENTATION CONTROL STRUCTURES SHALL BE IN ACCORDANCE WITH THESE PLANS AND THE "EROSION AND CONTROL NARRATIVE." INSPECTION AND MAINTENANCE OF ALL FACILITIES SHALL BE MADE AFTER EACH RAIN STORM EVENT AND ON A WEEKLY BASIS.

SEDIMENT DISPOSAL:

SILT REMOVED FROM TEMPORARY SEDIMENT CONTROL STRUCTURES SHALL BE DISPOSED OF ON-SITE IN LANDSCAPED AREAS LOCATED OUTSIDE OF FLOOD PLAINS, WETLANDS, STEEP SLOPES, AND DRAINAGE SWALES. AREAS OF SEDIMENT DISPOSAL SHALL BE CONSIDERED C.V.A. SILT AND SEDIMENT CATEGORIZED AS CONTAMINATED SHALL DISPOSED OF PER THE SOIL MANAGEMENT NOTES.

DUST CONTROL:

DUST AND OTHER PARTICULATES SHALL BE KEPT WITHIN TOLERABLE LIMITS BY USING WATER. APPLICATION SHALL BE AS NEEDED OR AS DIRECTED BY THE TOWNSHIP ENGINEER OR THE CONSERVATION DISTRICT

CRITICAL VEGETATION AREAS (C.V.A.):

CRITICAL VEGETATION AREAS ARE TO BE GRADED, HYDROSEEDED AND MULCHED WITHIN 10 DAYS OF THE BEGINNING OF EXCAVATION. IN GENERAL, CRITICAL VEGETATION AREAS ARE DEFINED AS CUT SLOPES STEEPER THAN 3:1, ALL FILL SLOPES STEEPER THAN 4:1 AND IN ALL DRAINAGE SWALES.

OTHER BMPS:

1. SEDIMENT SHALL BE REMOVED FROM STORM WATER INLET PROTECTION AFTER EACH RUNOFF EVENT.

VISUAL INSPECTIONS

THE PERMITTEE AND CO PERMITTEE(S) MUST ENSURE THAT VISUAL SITE INSPECTIONS ARE CONDUCTED WEEKLY, AND WITHIN 24 HOURS AFTER EACH MEASURABLE RAINFALL EVENT THROUGHOUT THE DURATION OF CONSTRUCTION AND UNTIL THE RECEIPT AND ACKNOWLEDGEMENT OF THE NOT BY THE DEPARTMENT OR AUTHORIZED CONSERVATION DISTRICT. THE VISUAL SITE INSPECTIONS AND REPORTS SHALL BE COMPLETED IN A FORMAT PROVIDED BY THE DEPARTMENT, AND CONDUCTED BY QUALIFIED PERSONNEI TRAINED AND EXPERIENCED IN EROSION AND SEDIMENT CONTROL. TO ASCERTAIN THAT F&S BMPS AND PCSM BMPS ARE PROPERLY CONSTRUCTED AND MAINTAINER TO EFFECTIVELY MINIMIZE POLLUTION TO THE WATERS OF THIS COMMONWEALTH A WRITTEN REPORT OF EACH INSPECTION SHALL UTILIZE PADEP FORM 3150-FM-BWEW0083 DATED FEBRUARY 2012 AND BE KEPT ON SITE AT ALL TIMES AND INCLUDE AT A

A SUMMARY OF SITE CONDITIONS, E&S BMP AND PCSM BMP, IMPLEMENTATION AND MAINTENANCE AND COMPLIANCE ACTIONS 2. THE DATE, TIME, NAME AND SIGNATURE OF THE PERSON CONDUCTING THE

NONCOMPLIANCE REPORTING

WHERE E&S, PCSM OR PPC BMPS ARE FOUND TO BE INOPERATIVE OR INEFFECTIVE DURING AN INSPECTION, OR ANY OTHER TIME, THE PERMITTEE AND COPERMITTEE(S) SHALL, WITHIN 24 HOURS, CONTACT THE DEPARTMENT OR AUTHORIZED CONSERVATION DISTRICT, BY PHONE OR PERSONAL CONTACT, FOLLOWED BY THE SUBMISSION OF A WRITTEN REPORT WITHIN 5 DAYS OF THE INITIAL CONTACT. NONCOMPLIANCE REPORTS SHALL INCLUDE THE FOLLOWING INFORMATION: 1. ANY CONDITION ON THE PROJECT SITE WHICH MAY ENDANGER PUBLIC HEALTH, SAFETY, OR THE ENVIRONMENT, OR INVOLVE INCIDENTS WHICH CAUSE OR

THREATEN POLLUTION. 2. THE PERIOD OF NONCOMPLIANCE, INCLUDING EXACT DATES AND TIMES AND/OR ANTICIPATED TIME WHEN THE ACTIVITY WILL RETURN TO COMPLIANCE;

STEPS BEING TAKEN TO REDUCE, ELIMINATE, AND PREVENT RECURRENCE OF HE NONCOMPLIANCE: AND

4. THE DATE OR SCHEDULE OF DATES, AND IDENTIFYING REMEDIES FOR CORRECTING NONCOMPLIANCE CONDITIONS.

REDUCTION, LOSS, OR FAILURE OF THE BMPS

UPON REDUCTION, LOSS, OR FAILURE OF THE BMPS, THE PERMITTEE AND CO. PERMITTEE SHALL TAKE IMMEDIATE ACTION TO RESTORE THE BMPS OR PROVIDE AN ALTERNATIVE METHOD OF TREATMENT. SUCH RESTORED BMPS OR ALTERNATIVE TREATMENT SHALL BE AT LEAST AS EFFECTIVE AS THE ORIGINAL BMPS.

TERMINATION OF COVERAGE

E&S AND PCSM PLANS.

NOT: UPON PERMANENT STABILIZATION OF EARTH DISTURBANCE ACTIVITIES ASSOCIATED WITH CONSTRUCTION ACTIVITY THAT ARE AUTHORIZED BY THIS PERMI AND WHEN BMPS IDENTIFIED IN THE PCSM PLAN HAVE BEEN PROPERLY INSTALLED. THE PERMITTEE AND/OR CO PERMITTEE OF THE FACILITY MUST SUBMIT A NOT FORM THAT IS SIGNED IN ACCORDANCE WITH PART B, SECTION 1.C, SIGNATORY REQUIREMENTS, OF THIS PERMIT. ALL LETTERS CERTIFYING DISCHARGE TERMINATION ARE TO BE SENT TO THE DEPARTMENT OR AUTHORIZED CONSERVATION DISTRICT. THE NOT MUST CONTAIN THE FOLLOWING INFORMATION: FACILITY NAME, ADDRESS, AND LOCATION, OPERATOR NAME AND ADDRESS, PERMIT NUMBER, IDENTIFICATION AND PROOF OF ACKNOWLEDGMENT FROM THE PERSON(S) WHO WILL BE RESPONSIBLE FOR OPERATION AND MAINTENANCE OF THE PCSM BMPS IN ACCORDANCE WITH THE APPROVED PCSM PLAN, AND THE REASON FOR PERMIT TERMINATION. UNTIL THE PERMITTEE HAS RECEIVED WRITTEN ACKNOWLEDGEMENT OF THE NOT, THE PERMITTEE WILL REMAIN RESPONSIBLE FOR OPERATING AND MAINTAINING ALL E&S BMPS AND PCSM BMPS ON THE PROJECT SITE AND WILL BE RESPONSIBLE FOR VIOLATIONS OCCURRING ON THE PROJECT SITE.

COMPLETION CERTIFICATE AND FINAL PLANS

WITHIN 30 DAYS AFTER THE COMPLETION OF EARTH DISTURBANCE ACTIVITIES AUTHORIZED BY THIS PERMIT, INCLUDING THE PERMANENT STABILIZATION OF THE SITE AND PROPER INSTALLATION OF PCSM BMPS IN ACCORDANCE WITH THE APPROVED PCSM PLAN, OR UPON SUBMISSION OF THE NOT IF SOONER, THE PERMITTEE SHALL FILE WITH THE DEPARTMENT OR AUTHORIZED CONSERVATION DISTRICT A STATEMENT SIGNED BY A LICENSED PROFESSIONAL AND BY THE PERMITTEE CERTIFYING THAT WORK HAS BEEN PERFORMED IN ACCORDANCE WITH THE TERMS AND CONDITIONS OF THIS PERMIT AND THE APPROVED

SOIL EROSION AND SEDIMENTATION CONTROL NOTES

LANCASTER AVENUE

ALL EARTH DISTURBANCES, INCLUDING CLEARING AND GRUBBING AS WELL AS CUTS AND FILLS SHALL BE DONE IN ACCORDANCE WITH THE APPROVED EROSION AND SEDIMENTATION CONTROL (E&S) PLAN. A COPY OF THI APPROVED E&S PLAN (STAMPED, SIGNED AND DATED BY THE REVIEWING AGENCY) MUST BE AVAILABLE AT THE PROJECT SITE AT ALL TIMES. THE REVIEWING AGENCY SHALL BE NOTIFIED OF ANY CHANGES TO THE APPROVED E&S PLAN PRIOR TO IMPLEMENTATION OF THOSE CHANGES. THE REVIEWING AGENCY MAY REQUIRE A WRITTEN

UBMITTAL OF THOSE CHANGES FOR REVIEW AND APPROVAL AT ITS DISCRETION. 2. AT LEAST 7 DAYS PRIOR TO STARTING ANY EARTH DISTURBANCE ACTIVITIES, INCLUDING CLEARING AND GRUBBING, THE OWNER AND/OR OPERATOR SHALL INVITE ALL CONTRACTORS, THE LANDOWNER, APPROPRIATE MUNICIPAL OFFICIALS, THE E&S PLAN PREPARER, THE PCSM PLAN PREPARER, THE LICENSED PROFESSIONAL RESPONSIBLE FOR OVERSIGHT OF CRITICAL STAGES OF IMPLEMENTATION OF THE PCSM PLAN, AND A REPRESENTATIVE FROM THE LOCAL CONSERVATION DISTRICT TO AN ON-SITE PRECONSTRUCTION MEETING. AT LEAST 3 DAYS PRIOR TO STARTING ANY EARTH DISTURBANCE ACTIVITIES, OR EXPANDING INTO AN AREA

REVIOUSLY UNMARKED, THE PENNSYLVANIA ONE CALL SYSTEM INC. SHALL BE NOTIFIED AT 1-800-242-1776 FOR THE LOCATION OF EXISTING UNDERGROUND UTILITIES. ALL EARTH DISTURBANCE ACTIVITIES SHALL PROCEED IN ACCORDANCE WITH THE SEQUENCE PROVIDED ON THE PLAN DRAWINGS. DEVIATION FROM THAT SEQUENCE MUST BE APPROVED IN WRITING FROM THE LOCAL CONSERVATION DISTRICT OR BY THE DEPARTMENT PRIOR TO IMPLEMENTATION. 5. AREAS TO BE FILLED ARE TO BE CLEARED, GRUBBED, AND STRIPPED OF TOPSOIL TO REMOVE TREES,

VEGETATION, ROOTS AND OTHER OBJECTIONABLE MATERIAL CLEARING, GRUBBING, AND TOPSOIL STRIPPING SHALL BE LIMITED TO THOSE AREAS DESCRIBED IN EACH TAGE OF THE CONSTRUCTION SEQUENCE, GENERAL SITE CLEARING, GRUBBING AND TOPSOIL STRIPPING MAY NOT COMMENCE IN ANY STAGE OR PHASE OF THE PROJECT UNTIL THE E&S BMPS SPECIFIED BY THE BMP SEQUENCE FOR THAT STAGE OR PHASE HAVE BEEN INSTALLED AND ARE FUNCTIONING AS DESCRIBED IN THIS E&S PLAN. 7. AT NO TIME SHALL CONSTRUCTION VEHICLES BE ALLOWED TO ENTER AREAS OUTSIDE THE LIMIT OF DISTURBANCE BOUNDARIES SHOWN ON THE PLAN MAPS. THESE AREAS MUST BE CLEARLY MARKED AND FENCED OFF

BEFORE CLEARING AND GRUBBING OPERATIONS BEGIN. 8. TOPSOIL REQUIRED FOR THE ESTABLISHMENT OF VEGETATION SHALL BE STOCKPILED AT THE LOCATION(S) SHOWN ON THE PLAN MAPS(S) IN THE AMOUNT NECESSARY TO COMPLETE THE FINISH GRADING OF ALL EXPOSED AREAS THAT ARE TO BE STABILIZED BY VEGETATION. EACH STOCKPILE SHALL BE PROTECTED IN THE MANNER SHOWN ON THE PLAN DRAWINGS. STOCKPILE SLOPES SHALL BE 2H: IV OR FLATTER, STOCKPILE HEIGHTS SHALL

9. IMMEDIATELY UPON DISCOVERING UNFORESEEN CIRCUMSTANCES POSING THE POTENTIAL FOR ACCELERATED EROSION AND/OR SEDIMENT POLLUTION, THE OPERATOR SHALL IMPLEMENT APPROPRIATE BEST MANAGEMENT PRACTICES TO MINIMIZE THE POTENTIAL FOR EROSION AND SEDIMENT POLLUTION AND NOTIFY THE LOCAL CONSERVATION DISTRICT AND/OR THE REGIONAL OFFICE OF THE DEPARTMENT. 10. BEFORE INITIATING ANY REVISION TO THE APPROVED FROSION AND SEDIMENT CONTROL PLAN OR REVISIONS TO OTHER PLANS WHICH MAY AFFECT THE EFFECTIVENESS OF THE APPROVED E&S CONTROL PLAN. THE OPERATOR MUST RECEIVE APPROVAL OF THE REVISIONS FROM THE DELAWARE COUNTY CONSERVATION DISTRICT. THE OPERATOR

SHALL ASSURE THAT THE APPROVED EROSION AND SEDIMENT CONTROL PLAN IS PROPERLY AND COMPLETELY 11. ALL BUILDING MATERIALS AND WASTES SHALL BE REMOVED FROM THE SITE AND RECYCLED OR DISPOSED OF IN ACCORDANCE WITH THE DEPARTMENT'S SOLID WASTE MANAGEMENT REGULATIONS AT 25 PA. CODE 260.1 ET SEQ., 271.1, AND 287.1 ET. SEG. NO BUILDING MATERIALS OR WASTES OR UNUSED BUILDING MATERIALS SHALL BE BURNED, BURIED, DUMPED, OR DISCHARGED AT THE SITE. 12. ALL OFF-SITE WASTE AND BORROW AREAS MUST HAVE AN E&S PLAN APPROVED BY THE LOCAL CONSERVATION DISTRICT OR THE DEPARTMENT FULLY IMPLEMENTED PRIOR TO BEING ACTIVATED.

13. THE CONTRACTOR IS RESPONSIBLE FOR ENSURING THAT ANY MATERIAL BROUGHT ON SITE IS CLEAN FILL. FORM FP-001 MUST BE RETAINED BY THE PROPERTY OWNER FOR ANY FILL MATERIAL AFFECTED BY A SPILL OR RELEASE OF A REGULATED SUBSTANCE BUT QUALIFYING AS CLEAN FILL DUE TO ANALYTICAL TESTING. 14. ALL PUMPING OF WATER FROM ANY WORK AREA SHALL BE DONE ACCORDING TO THE PROCEDURE DESCRIBED IN THIS PLAN, OVER UNDISTURBED VEGETATED ARES 15. VEHICLES AND EQUIPMENT MAY NEITHER ENTER NOR EXIT DIRECTLY FROM THE PROJECT SITE ONTO WEST

16. UNTIL THE SITE IS STABILIZED, ALL EROSION AND SEDIMENTATION BMP'S MUST BE MAINTAINED PROPERLY. MAINTENANCE MUST INCLUDE INSPECTIONS OF ALL EROSION AND SEDIMENTATION BMP'S AFTER EACH RUNOFF EVENT AND ON A WEEKLY BASIS. ALL SITE INSPECTIONS, THE COMPLIANCE INSPECTIONS, AND THE DATE, TIME, AND NAME OF THE PERSON CONDUCTING THE INSPECTION WILL BE DOCUMENTED IN AN INSPECTION LOG KEPT FOR THIS PURPOSE. THE INSPECTION LOG WILL BE KEPT ON SITE AT ALL TIMES AND MADE AVAILABLE TO THE DISTRICT LIPON REQUEST, ALL PREVENTATIVE AND REMEDIAL MAINTENANCE WORK, INCLUDING CLEAN OUT, REPAIR REPLACEMENT, REGRADING, RESEEDING, REMULCHING, AND RENETTING, MUST BE PERFORMED IMMEDIATELY EROSION AND SEDIMENTATION BMP'S FAIL TO PERFORM AS EXPECTED, REPLACEMENT BMP'S OR MODIFICATIONS OF HOSE INSTALLED WILL BE NEEDED. WHERE BMP'S ARE FOUND TO FAIL TO ALLEVIATE EROSION AND SEDIMENT POLLUTION THE PERMITTEE OR CO-PERMITTEE SHALL INCLUDE THE FOLLOWING INFORMATION: A. THE LOCATION AND SEVERITY OF THE BMP'S FAILURE AND ANY POLLUTION EVENTS. B. ALL STEPS TAKEN TO REDUCE, ELIMINATE AND PREVENT THE RECURRENCE OF THE

NON-COMPLIANCE C. THE TIME FRAME TO CORRECT THE NON-COMPLIANCE, INCLUDING THE EXACT DATES WHEN THE ACTIVITY WILL RETURN TO COMPLIANCE. AFTER FINAL SITE STABILIZATION HAS BEEN ACHIEVED, TEMPORARY EROSION AND SEDIMENT BMP'S MUST BE REMOVED. AREAS DISTURBED DURING THEIR REMOVAL OF THE BMP'S MUST BE STABILIZED IMMEDIATELY. 17. SEDIMENT TRACKED ONTO ANY PUBLIC ROADWAY OR SIDEWALK SHALL BE RETURNED TO THE SITE IMMEDIATELY AND DISPOSED IN THE MANNER DESCRIBED IN THIS PLAN. IN NO CASE SHALL THE SEDIMENT BE WASHED,

SHOVELED, OR SWEPT INTO ANY ROADSIDE DITCH, STORM SEWER, OR SURFACE WATER. 18. ALL SEDIMENT REMOVED FROM BMPS SHALL BE DISPOSED OF IN THE MANNER DESCRIBED ON THE PLAN 19. AREAS WHICH ARE TO BE TOP SOILED SHALL BE SCARIFIED TO A MINIMUM DEPTH OF 3 TO 5 INCHES -- 6 TO 12 INCHES ON COMPACTED SOILS -- PRIOR TO PLACEMENT OF TOPSOIL. AREAS TO BE VEGETATED SHALL HAVE

A MINIMUM 4 INCHES OF TOPSOIL IN PLACE PRIOR TO SEEDING AND MULCHING. FILL OUTSLOPES SHALL HAVE A MINIMUM OF 2 INCHES OF TOPSOIL. 20. ALL FILLS SHALL BE COMPACTED AS REQUIRED TO REDUCE EROSION, SLIPPAGE, SETTLEMENT, SUBSIDENCE OR OTHER RELATED PROBLEMS. FILL INTENDED TO SUPPORT BUILDINGS, STRUCTURES AND CONDUITS, ETC. SHALL BE COMPACTED IN ACCORDANCE WITH LOCAL REQUIREMENTS OR CODES. ALL EARTHEN FILLS SHALL BE PLACED IN COMPACTED LAYERS NOT TO EXCEED 9 INCHES IN THICKNESS.

2. FILL MATERIALS SHALL BE FREE OF BRUSH, ROOTS, SOD, OR OTHER FOREIGN OR OBJECTIONABLE MATERIALS THAT WOULD INTERFERE WITH OR PREVENT CONSTRUCTION OF SATISFACTORY FILLS. FROZEN MATERIALS OR SOFT, MUCKY, OR HIGHLY COMPRESSIBLE MATERIALS SHALL NOT BE INCORPORATED INTO FILLS. 3. FILL SHALL NOT BE PLACED ON SATURATED OR FROZEN SURFACES. 24. SEEPS OR SPRINGS ENCOUNTERED DURING CONSTRUCTION SHALL BE HANDLED IN ACCORDANCE WITH THE TANDARD AND SPECIFICATION FOR SUBSURFACE DRAIN OR OTHER APPROVED METHOD.

25. ALL GRADED AREAS SHALL BE PERMANENTLY STABILIZED IMMEDIATELY UPON REACHING FINISHED GRADE. CUT SLOPES IN COMPETENT BEDROCK AND ROCK FILLS NEED NOT BE VEGETATED. SEEDED AREAS WITHIN 50 FEFT OF A SURFACE WATER, OR AS OTHERWISE SHOWN ON THE PLAN DRAWINGS, SHALL BE BLANKETED ACCORDING TO THE STANDARDS OF THIS PLAN, EROSION CONTROL BLANKET IS REQUIRED TO STABILIZE ALL SLOPES 3:1 AND GREATER. ALL EROSION CONTROL BLANKET SHALL BE NORTH AMERICAN GREEN \$75 OR APPROVED EQUAL 26. IMMEDIATELY AFTER EARTH DISTURBANCE ACTIVITIES CEASE IN ANY AREA OR SUBAREA OF THE PROJECT, THE OPERATOR SHALL STABILIZE ALL DISTURBED AREAS. DURING NON-GERMINATING MONTHS, MUI CH O PROTECTIVE BLANKETING SHALL BE APPLIED AS DESCRIBED IN THE PLAN. AREAS NOT AT FINISHED GRADE, WHICH WILL BE REACTIVATED WITHIN 1 YEAR, MAY BE STABILIZED IN ACCORDANCE WITH THE TEMPORARY STABILIZATION

SPECIFICATIONS. THOSE AREAS WHICH WILL NOT BE REACTIVATED WITHIN 1 YEAR SHALL BE STABILIZED IN ACCORDANCE WITH THE PERMANENT STABILIZATION SPECIFICATIONS 27. PERMANENT STABILIZATION IS DEFINED AS A MINIMUM UNIFORM, PERENNIAL 70% VEGETATIVE COVER OR OTHER PERMANENT NON-VEGETATIVE COVER WITH A DENSITY SUFFICIENT TO RESIST ACCELERATED EROSION. CUT AND FILL SLOPES SHALL BE CAPABLE OF RESISTING FAILURE DUE TO SLUMPING, SLIDING, OR OTHER MOVEMENTS. 28. E&S BMPS SHALL REMAIN FUNCTIONAL AS SUCH UNTIL ALL AREAS TRIBUTARY TO THEM ARE PERMANENTLY STABILIZED OR UNTIL THEY ARE REPLACED BY ANOTHER BMP APPROVED BY THE LOCAL CONSERVATION DISTRICT OR

THE DEPARTMENT. 29. UPON COMPLETION OF ALL EARTH DISTURBANCE ACTIVITIES AND PERMANENT STABILIZATION OF ALL DISTURBED AREAS, THE OWNER AND/OR OPERATOR SHALL CONTACT THE LOCAL CONSERVATION DISTRICT FOR AN INSPECTION PRIOR TO REMOVAL/CONVERSION OF THE E&S BMPS. 30. AFTER FINAL SITE STABILIZATION HAS BEEN ACHIEVED, TEMPORARY EROSION AND SEDIMENT BMPS MUST BE REMOVED OR CONVERTED TO PERMANENT POST CONSTRUCTION STORMWATER MANAGEMENT BMPS. AREAS DISTURBED

DURING REMOVAL OR CONVERSION OF THE BMPS SHALL BE STABILIZED IMMEDIATELY. IN ORDER TO ENSURE RAPID REVEGETATION OF DISTURBED AREAS, SUCH REMOVAL/CONVERSIONS ARE TO BE DONE ONLY DURING THE GERMINATING SEASON 31. UPON COMPLETION OF ALL EARTH DISTURBANCE ACTIVITIES AND PERMANENT STABILIZATION OF ALL DISTURBED AREAS, THE OWNER AND/OR OPERATOR SHALL CONTACT THE LOCAL CONSERVATION DISTRICT TO

CHEDULE A FINAL INSPECTION. 32. FAILURE TO CORRECTLY INSTALL E&S BMPS, FAILURE TO PREVENT SEDIMENT-LADEN RUNOFF FROM LEAVING THE CONSTRUCTION SITE OR FAILURE TO TAKE IMMEDIATE CORRECTIVE ACTION TO RESOLVE FAILURE OF E&S BMPS MAY RESULT IN ADMINISTRATIVE, CIVIL, AND/OR CRIMINAL PENALTIES BEING INSTITUTED BY THE DEPARTMENT AS DEFINED IN SECTION 602 OF THE PENNSYLVANIA CLEAN STREAMS LAW. THE CLEAN STREAMS LAW PROVIDES FOR UP TO \$10,000 PER DAY IN CIVIL PENALTIES, UP TO \$10,000 IN SUMMARY CRIMINAL PENALTIES, AND UP O \$25,000 IN MISDEMEANOR CRIMINAL PENALTIES FOR EACH VIOLATION 33. SHOULD ANY MEASURES CONTAINED WITHIN THIS PLAN PROVE INCAPABLE OF ADEQUATELY REMOVING SEDIMENT

FROM ON-SITE FLOWS PRIOR TO DISCHARGE OR STABILIZING THE SURFACES INVOLVED, ADDITIONAL MEASURES MUST BE IMMEDIATELY IMPLEMENTED BY THE DEVELOPER TO ELIMINATE ALL SUCH PROBLEMS. THE DELAWARE COUNTY CONSERVATION DISTRICT MUST BE NOTIFIED BY THE DEVELOPER OF ANY AND ALL CHANGES OR MODIFICATIONS TO THE CONTROLS. 34. THE CONTRACTOR IS ADVISED TO BECOME THOROUGHLY FAMILIAR WITH THE PROVISION OF APPENDIX 64. EROSION CONTROL RULES AND REGULATIONS, TITLE 25, PART 1, DEPARTMENT OF ENVIRONMENTAL PROTECTION SUB-PART C, PROTECTION OF NATURAL RESOURCES. ARTICLE III, WATER RESOURCES, CHAPTER 102, EROSION

CONTROL. 5. THE PROPOSED CONSERVATION MEASURES MUST BE IN COMPLIANCE WITH PADEP CHAPTER 102 REGULATIONS. 36. THE PROJECT'S NEAREST SURFACE WATER IS VALLEY RUN. THE CHAPTER 93 CLASSIFICATION IS CWF/MF-COLD WATER FISHES / MIGRATORY FISHES WATERWAY. 37. UPON THE INSTALLATION OR STABILIZATION OF ALL PERIMETER SEDIMENT CONTROL BMPS AND AT LEAST 3

DAYS PRIOR TO PROCEEDING WITH THE BULK EARTH DISTURBANCE ACTIVITIES, THE PERMITTEE OR CO-PERMITTEE SHALL PROVIDE NOTIFICATION TO THE DEPARTMENT OR AUTHORIZED CONSERVATION DISTRICT 38. CONCRETE WASH WATER SHALL BE HANDLED IN THE MANNER DESCRIBED ON THE PLAN DRAWINGS. IN NO CASE SHALL IT BE ALLOWED TO ENTER ANY SURFACE WATERS OR GROUNDWATER SYSTEMS. 39. CLEAN FILL IS DEFINED AS: UNCONTAMINATED, NON-WATER SOLUBLE, NON-DECOMPOSABLE, INERT SOLID MATERIAL. THE TERM INCLUDES SOIL, ROCK, STONE, DREDGED MATERIAL, USED ASPHALT, AND BRICK, BLOCK, OR CONCRETE FROM CONSTRUCTION AND DEMOLITION ACTIVITIES THAT IS SEPARATE FROM OTHER WASTE AND IS RECOGNIZABLE AS SUCH. THE TERM DOES NOT INCLUDE MATERIALS PLACED IN OR ON THE WATERS OF THE

COMMONWEALTH UNLESS OTHERWISE AUTHORIZED. (THE TERM "USED" ASPHALT DOES NOT INCLUDE MILLED ASPHALT OR ASPHALT THAT HAS BEEN PROCESSED FOR RE-USE). CLEAN FILL AFFECTED BY A SPILL OR RELEASE OF A REGULATED SUBSTANCE: FILL MATERIALS AFFECTED BY A SPILL OR RELEASE OF A REGULATED SUBSTANCE STILL QUALIFIES AS CLEAN FILL PROVIDED THE TESTING REVEALS THAT THE FILL MATERIAL CONTAINS CONCENTRATIONS OF REGULATED SUBSTANCES THAT ARE BELOW THE RESIDENTIAL LIMITS IN TABLES FP-1a AND FP-1b FOUND IN THE DEPARTMENT'S POLICY "MANAGEMENT OF FILL". ANY PERSON PLACING CLEAN FILL THAT HAS BEEN AFFECTED BY A SPILL OR RELEASE OF A REGULATED SUBSTANCE MUST USE FORM FP-001 TO CERTIFY THE ORIGIN OF THE FILL MATERIAL AND THE RESULTS OF THE ANALYTICAL TESTING TO QUALIFY THE MATERIAL AS CLEAN FILL, FORM FP-001 MUST BE RETAINED BY THE OWNER OF THE PROPERTY RECEIVING THE FILL. A COPY OF FORM FP-001 CAN BE FOUND AT THE END OF THESE INSTRUCTIONS ON THE DEPARTMENT'S WEBSITE. ENVIRONMENTAL DUE DILIGENCE: THE APPLICANT MUST PERFORM DUE DILIGENCE TO DETERMINE IF THE FILL MATERIALS ASSOCIATED WITH THE PROJECT QUALIFY AS CLEAN FILL. ENVIRONMENTAL DUE DILIGENCE IS DEFINED AS: INVESTIGATIVE TECHNIQUES, INCLUDING, BUT NOT LIMITED TO, VISUAL PROPERTY INSPECTIONS, ELECTRONIC DATA BASE SEARCHES, REVIEW OF PROPERTY OWNERSHIP, REVIEW OF PROPERTY USE HISTORY, SANBORN MAPS, ENVIRONMENTAL QUESTIONNAIRES TRANSACTION SCREENS, ANALYTICAL TESTING, ENVIRONMENTAL ASSESSMENTS OR AUDITS. ANALYTICAL TESTING IS NOT A REQUIRED PART OF DUE DILIGENCE UNLESS VISUAL INSPECTION AND/OR REVIEW OF THE PAST LAND USE OF THE PROPERTY INDICATES THAT THE FILL MAY HAVE BEEN SUBJECTED TO A SPILL OR RELEASE OF A REGULATED SUBSTANCE. IF THE FILL MAY HAVE BEEN AFFECTED BY A SPILL OR RELEASE OF A REGULATED SUBSTANCE, IT MUST BE TESTED TO DETERMINE IF IT QUALIFIES AS CLEAN FILL. TESTING SHOULD BE PERFORMED IN ACCORDANCE WITH APPENDIX A OF THE DEPARTMENT'S POLICY "MANAGEMENT OF FILL".

GENERAL NOTES FOR UTILITY CONSTRUCTION

FINAL SURFACE LAYER FOLLOWING TRENCH BACKFILLING

EXCAVATED MATERIAL SHOULD BE STAGED ON THE UPSTREAM SIDE OF A TRENCH. THE DAILY EXTENT OF TRENCHING SHOULD NOT EXCEED WHAT CAN BE BACKFILLED AND STABILIZED IN ONE

LIMIT ADVANCED CLEARING AND GRUBBING OPERATIONS TO A DISTANCE EQUAL TO TWO TIMES THE LENGTH OF PIPE INSTALLATION THAT CAN BE COMPLETED IN ONE DAY WORK CREWS AND EQUIPMENT FROM TRENCHING, PLACEMENT OF PIPE, AND BACKFILLING WILL BE SELF CONTAINED AND SEPARATE FROM CLEARING AND GRUBBING AND SITE RESTORATION AND STABILIZATION OPERATIONS. WATER WHICH ACCUMULATES IN THE OPEN TRENCH WILL BE COMPLETELY REMOVED BY PUMPING BEFORE PIPE PLACEMENT AND/OR BACKFILLING BEGINS. WATER REMOVED FROM THE TRENCH SHALL BE PUMPED THROUGH A

FILTRATION DEVICE. ON THE DAY FOLLOWING PIPE PLACEMENT AND TRENCH BACKFILLING, THE DISTURBED AREA WILL BE GRADED TO FINAL CONTOURS AND IMMEDIATELY STABILIZED. SOILS EXCAVATED FROM EXISTING SURFACE LAYER SHOULD BE STOCKPILED SEPARATELY AND RETURNED AS

ANTICIPATED E&S BMP RELATED CONSTRUCTION WASTES AND DISPOSAL PROCEDURES

SEDIMENT

TRASH & LITTER


SILT REMOVED FROM TEMPORARY SEDIMENT CONTROL STRUCTURES SHALL BE DISPOSED OF ON-SITE IN LANDSCAPED AREAS LOCATED OUTSIDE OF FLOOD PLAINS, WETLANDS, STEEP SLOPES, AND DRAINAGE

SWALES. SILT AND SEDIMENT CATEGORIZED AS CONTAMINATED SHALL DISPOSED OF PER THE SOIL MANAGEMENT NOTES TRASH AND LITTER SHALL BE REMOVED FROM EROSION AND SEDIMENTATION

CONTROL BMPS AND DISPOSED OF IN APPROPRIATE TRASH RECEPTACLE. CONCRETE WASHWATER CONCRETE WASHWATER SHALL BE DISPOSED OF IN THE LOCATION SHOWN ONSITE. ONCE WASHWATER SOLIDIFIES THE HARDENED CONCRETE SHALL BE

DISPOSED OF OFF-SITE IN AN APPROVED MANNER. NOTE: ANY APPLICABLE MATERIAL SHALL BE RECYCLED IN ACCORDANCE TO THE APPROPRIATE REGULATIONS.

MOUNTARIE GEOTEXTILE -PIPE AS NECESSARY MIN. 8" AASHTO #1 **PROFILE**

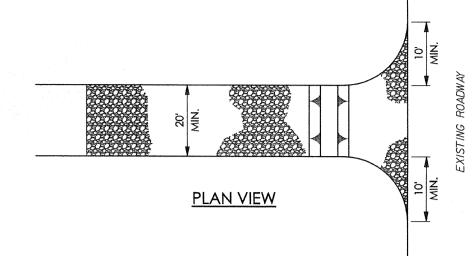


* MOUNTABLE BERM USED TO PROVIDE PROPER COVER FOR PIPE

REMOVE TOPSOIL PRIOR TO INSTALLATION OF ROCK CONSTRUCTION ENTRANCE. EXTEND ROCK OVER FULL RUNOFF SHALL BE DIVERTED FROM ROADWAY TO A SUITABLE SEDIMENT REMOVAL BMP PRIOR TO ENTERING ROCK CONSTRUCTION ENTRANCE.


MOUNTABLE BERM SHALL BE INSTALLED WHEREVER OPTIONAL CULVERT PIPE IS USED AND PROPER PIPE COVER AS SPECIFIED BY MANUFACTURER IS NOT OTHERWISE PROVIDED. PIPE SHALL BE SIZED APPROPRIATELY FOR SIZE OF DITCH BEING CROSSED.

MAINTENANCE: ROCK CONSTRUCTION ENTRANCE THICKNESS SHALL BE CONSTANTLY MAINTAINED TO THE SPECIFIED DIMENSIONS BY ADDING ROCK A STOCKPILE SHALL BE MAINTAINED ON SITE FOR THIS PLIPPOSE ALL SEDIMENT DEPOSITED ON PAVED ROADWAYS SHALL BE REMOVED AND RETURNED TO THE CONSTRUCTION SITE. IMMEDIATELY. IF EXCESSIVE AMOUNTS OF SEDIMENT ARE BEING DEPOSITED ON ROADWAY, EXTEND LENGTH OF ROCK CONSTRUCTION ENTRANCE BY 50 FOOT INCREMENTS UNTIL CONDITION IS ALLEVIATED OR INSTALL WASH RACK. WASHING THE ROADWAY OR SWEEPING THE DEPOSITS INTO ROADWAY DITCHES, SEWERS, CULVERTS, OR OTHER DRAINAGE COURSES IS NOT ACCEPTABLE.

STANDARD CONSTRUCTION DETAIL #3-1 ROCK CONSTRUCTION ENTRANCE

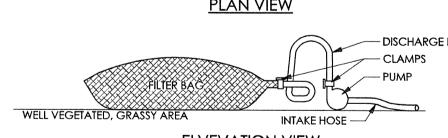

NOTES: LOW VOLUME FILTER BAGS SHALL BE MADE FROM NON-WOVEN GEOTEXTILE MATERIAL SEWN WITH HIGH STRENGTH, DOUBLE STITCHED "J" TYPE SEAMS, THEY SHALL BE CAPABLE OF TRAPPING PARTICLES LARGER THAN 150 MICRONS. HIGH VOLUME FILTER BAGS SHALL BE MADE FROM WOVEN GEOTEXTILES THAT MEET THE FOLLOWING STANDARDS

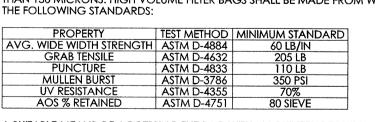

OPTIONAL 6 IN. COMPOST LAYER

OPTIONAL 6 IN. SUMP

- AASHTO NO. 57

FIRMLY ANCHORED

AASHTO NO. 57,

OR FILTER FABRIC

---- R-3 ROCK

WOOD POSTS -

HEIGHT OF ROCK -

FILTER = % HEIGHT

OF STRAW BALES OR FILTER FABRIC FENCE

OUTLET CROSS-SECTION

UP-SLOPE FACE

A ROCK FILTER OUTLET SHALL BE INSTALLED WHERE FAILURE OF A SILT FENCE OR STRAW BALE BARRIER

HAS OCCURRED DUE TO CONCENTRATED FLOW. ANCHORED COMPOST LAYER SHALL BE USED ON UPSLOPE FACE IN HQ AND EV WATERSHEDS.

STANDARD CONSTRUCTION DETAIL #4-6


ROCK FILTER OUTLET

SEDIMENT SHALL BE REMOVED WHEN ACCUMULATIONS REACH 1/3 THE HEIGHT OF THE OUTLET.

BE KEPT AVAILABLE FOR REPLACEMENT OF THOSE THAT HAVE FAILED OR ARE FILLED. BAGS SHALL BE PLACED ON STRAPS TO FACILITATE REMOVAL UNLESS BAGS COME WITH LIFTING STRAPS ALREADY ATTACHED. BAGS SHALL BE LOCATED IN WELL-VEGETATED (GRASSY) AREA, AND DISCHARGE ONTO STABLE, EROSION RESISTANT AREAS. WHERE THIS IS NOT POSSIBLE, A GEOTÉXTILE UNDERLAYMENT AND FLOW PATH SHALL BE PROVIDED. BAGS MAY BE PLACED ON FILTER STONE TO INCREASE DISCHARGE CAPACITY, BAGS SHALL NOT BE PLACED ON SLOPES GREATER THAN 5%. FOR SLOPES EXCEEDING 5%, CLEAN ROCK OR OTHER NON-ERODIBLE AND NON-POLLUTING MATERIAL MAY BE PLACED UNDER THE BAG TO REDUCE SLOPE STEEPNESS.

RECEIVING SURFACE WATER OR WHERE GRASSY AREA IS NOT AVAILABLE THE PUMP DISCHARGE HOSE SHALL BE INSERTED INTO THE BAGS IN THE MANNER SPECIFIED BY THE MANUFACTURER AND SECURELY CLAMPED. A PIECE OF PVC PIPE IS RECOMMENDED FOR THIS PURPOSE. THE PUMPING RATE SHALL BE NO GREATER THAN 750 GPM OR 1/2 THE MAXIMUM SPECIFIED BY THE MANUFACTURER, WHICHEVER IS LESS. PUMP INTAKES SHALL BE FLOATING AND SCREENED. FILTER BAGS SHALL BE INSPECTED DAILY. IF ANY PROBLEM IS DETECTED, PUMPING SHALL CEASE IMMEDIATELY

STANDARD CONSTRUCTION DETAIL #3-16 PUMPED WATER FILTER BAG

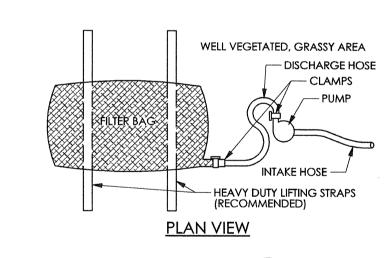

- DISCHARGE HOSE **ELVEVATION VIEW**

A SUITABLE MEANS OF ACCESSING THE BAG WITH MACHINERY REQUIRED FOR DISPOSAL PURPOSES SHALL BE

PROVIDED. FILTER BAGS SHALL BE REPLACED WHEN THEY BECOME 1/2 FULL OF SEDIMENT, SPARE BAGS SHALL NO DOWNSLOPE SEDIMENT BARRIER IS REQUIRED FOR MOST INSTALLATIONS. COMPOST BERM OR COMPOST FILTER SOCK SHALL BE INSTALLED BELOW BAGS LOCATED IN HQ OR EV WATERSHEDS, WITHIN 50 FEET OF ANY

Villanova University Church Walk and Bridge Lancaster and Ithan Avenues

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www.navenewell.com STRUCTURAL ENGINEER - PARKING PLANNING AND DESIGN The Harman Group, Inc. 900 West Valley Forge Road, Suite 200 King of Prussia, PA 19406 phone: 610-337-3360 x 118 voice mobile phone: 610-334-0974 fax: 610-337-3359 www.HarmanGroup.com

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RECORD PLAN


SUBMISSION Revision #6 October 6, 2015 March 13, 2015


Erosion & Sedimentation Control Detail Sheet Scale N.T.S.

Drawn By DWN

Sheet No


AND NOT RESUME UNTIL THE PROBLEM IS CORRECTED.

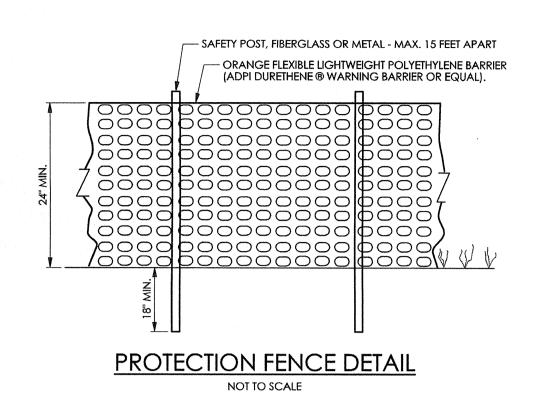

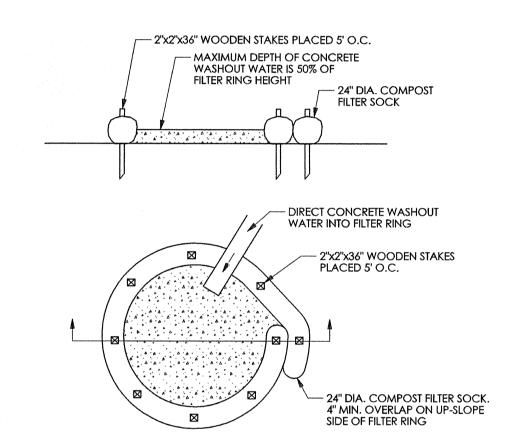

A SUITABLE IMPERVIOUS GEO-MEMBRANE SHALL BE PLACED AT THE LOCATION OF THE WASHOUT PRIOR TO INSTALLING THE SOCKS. INSTALL ON FLAT GRADE FOR OPTIMUM PERFORMANCE. 8" DIAMETER FILTER SOCKS MAY BE STACKED ONTO DOUBLE 24" DIAMETER SOCKS IN PYRAMIDAL CONFIGURATION FOR ADDEDHEIGHT. ALL CONCRETE WASHOUT FACILITIES SHOULD BE INSPECTED DAILY. DAMAGED OR LEAKING WASHOUTS SHOULD BE DEACTIVATED AND REPAIRED OR REPLACED IMMEDIATELY.


CONTROLLED NON-DISCHARGE CONCRETE WASH OUT NOT TO SCALE

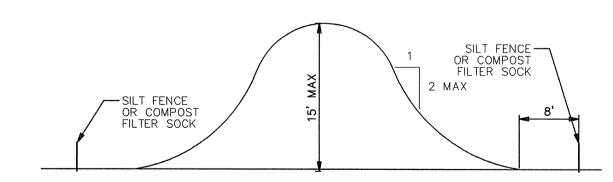

TYPICAL SOIL STOCKPILE CROSS SECTION NOT TO SCALE

SILT FENCE MUST COMPLETELY ENCIRCLE STOCKPILE

TOPSOIL SHALL NOT BE REMOVED FROM THE DEVELOPMENT SITE OR USED AS FILL. TOPSOIL SHALL BE REMOVED FROM THE AREAS OF CONSTRUCTION AND STORED SEPARATELY. THE TOPSOIL SHALL BE STABILIZED TO MINIMIZE EROSION DURING STORAGE. UPON COMPLETION OF CONSTRUCTION, THE TOPSOIL SHALL BE UNIFORMLY REDISTRIBUTED ON THE SITE.

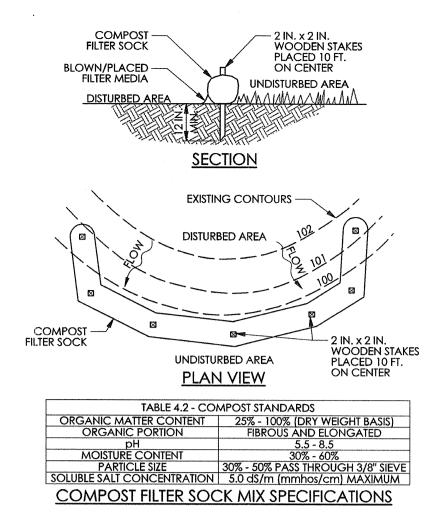

NOTES: SOCK FABRIC SHALL MEET STANDARDS OF TABLE 4.1 OF THE PA DEP EROSION CONTROL MANUAL. COMPOST SHALL MEET THE STANDARDS OF TABLE 4.2 OF THE PA DEP EROSION CONTROL MANUAL. COMPOST FILTER SOCK SHALL BE PLACED AT EXISTING LEVEL GRADE, BOTH ENDS OF THE BARRIER SHALL BE EXTENDED AT LEAST 8 FEET UP SLOPE AT 45 DEGREES TO THE MAIN BARRIER ALIGNMENT. MAXIMUM SLOPE LENGTH ABOVE ANY BARRIER SHALL NOT EXCEED THAT SPECIFIED FOR THE SIZE OF THE SOCK AND THE SLOPE OF ITS TRIBUTARY AREA.


TRAFFIC SHALL NOT BE PERMITTED TO CROSS COMPOST FILTER SOCKS.

ACCUMULATED SEDIMENT SHALL BE REMOVED WHEN IT REACHES 1/2 THE ABOVE GROUND HEIGHT OF THE COMPOST FILTER SOCKS SHALL BE INSPECTED WEEKLY AND AFTER EACH RUNOFF EVENT. DAMAGED SOCKS SHALL BE REPAIRED ACCORDING TO MANUFACTURER'S SPECIFICATIONS OR REPLACED WITHIN 24 HOURS

BIODEGRADABLE COMPOST FILTER SOCKS SHALL BE REPLACED AFTER 6 MONTHS; PHOTODEGRADABLE SOCKS AFTER 1 YEAR. POLYPROPYLENE SOCKS SHALL BE REPLACED ACCORDING TO MANUFACTURER'S UPON STABILIZATION OF THE AREA TRIBUTARY TO THE SOCK, STAKES SHALL BE REMOVED. THE SOCK MAY BE LEFT IN PLACE AND VEGETATED OR REMOVED. IN THE LATTER CASE, THE MESH SHALL BE CUT OPEN AND THE

WHERE SOCKS ARE PLACED ON PAVED SURFACES, CONCRETE BLOCKS SHOULD BE USED IMMEDIATELY DOWNSLOPE OF THE SOCKS (AT THE SAME INTERVALS RECOMMENDED FOR THE STAKES) TO HELP HOLD THE SOCK IN PLACE.

STANDARD CONSTRUCTION DETAIL #4-1 COMPOST FILTER SOCK NOT TO SCALE

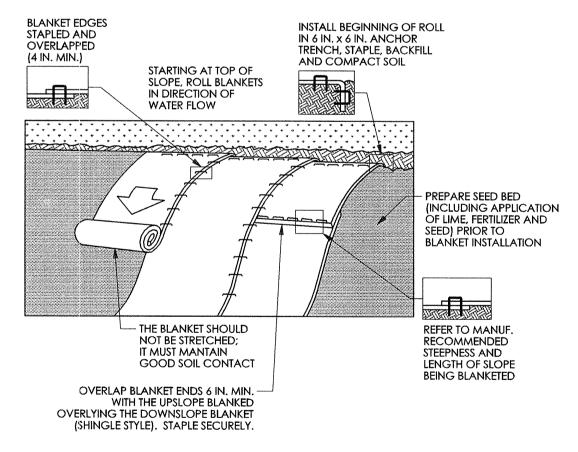

NOTES: SEED AND SOIL AMENDMENTS SHALL BE APPLIED ACCORDING TO THE RATES IN THE PLAN DRAWINGS PRIOR TO PROVIDE ANCHOR TRENCH AT TOE OF SLOPE IN SIMILAR FASHION AS AT TOP OF SLOPE. SLOPE SURFACE SHALL BE FREE OF ROCKS, CLODS, STICKS, AND GRASS.


BLANKET SHALL HAVE GOOD CONTINUOUS CONTACT WITH UNDERLYING SOIL THROUGHOUT ENTIRE LENGTH. LAY BLANKET LOOSELY AND STAKE OR STAPLE TO MAINTAIN DIRECT CONTACT WITH SOIL. DO NOT STRETCH

THE BLANKET SHALL BE STAPLED IN ACCORDANCE WITH THE MANUFACTURER'S RECOMMENDATIONS. BLANKETED AREAS SHALL BE INSPECTED WEEKLY AND AFTER EACH RUNOFF EVENT UNTIL PERENNIAL VEGETATION IS ESTABLISHED TO A MINIMUM UNIFORM 70% COVERAGE THROUGHOUT THE BLANKETED AREA.


DAMAGED OR DISPLACED BLANKETS SHALL BE RESTORED OR REPLACED WITHIN 4 CALENDAR DAYS.

STANDARD CONSTRUCTION DETAIL #11-1 **EROSION CONTROL BLANKET INSTALLATION**

NOT TO SCALE

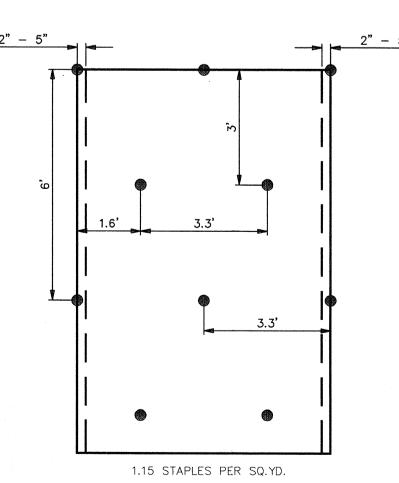

EROSION CONTROL BLANKET STAPLE PATTERN NOT TO SCALE

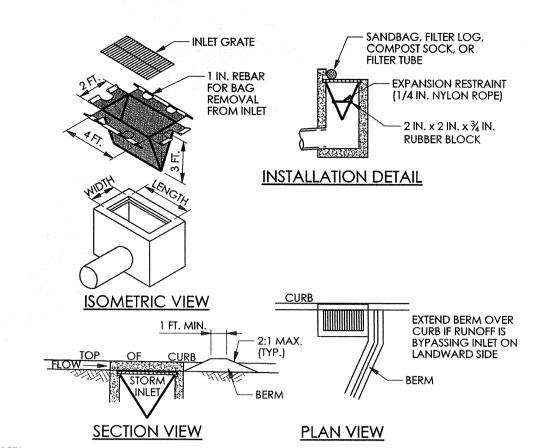

NOTES:

MAXIMUM DRAINAGE AREA = 1/2 ACRE.


INLET PROTECTION SHALL NOT BE REQUIRED FOR INLET TRIBUTARY TO SEDIMENT BASIN OR TRAP. BERMS SHALL BE REQUIRED FOR ALL INSTALLATIONS.

ROLLED EARTHEN BERM SHALL BE MAINTAINED UNTIL ROADWAY IS STONED. ROAD SUBBASE BERM SHALL BE MAINTAINED UNTIL ROADWAY IS PAVED. SIX INCH MINIMUM HEIGHT ASPHALT BERM SHALL BE MAINTAINED UNTIL ROADWAY SURFACE RECEIVES FINAL COAT. AT A MINIMUM, THE FABRIC SHALL HAVE A MINIMUM GRAB TENSILE STRENGTH OF 120 LBS, A MINIMUM BURST STRENGTH OF 200 PSI, AND A MINIMUM TRAPEZOIDAL TEAR STRENGTH OF 50 LBS. FILTER BAGS SHALL BE CAPABLE OF TRAPPING ALL PARTICLES NOT PASSING A NO. 40 SIEVE.

INLET FILTER BAGS SHALL BE INSPECTED ON A WEEKLY BASIS AND AFTER EACH RUNOFF EVENT. BAGS SHALL BE EMPTIED AND RINSED OR REPLACED WHEN HALF FULL OR WHEN FLOW CAPACITY HAS BEEN REDUCED SO AS TO CAUSE FLOODING OR BYPASSING OF THE INLET. DAMAGED OR CLOGGED BAGS SHALL BE REPLACED. A SUPPLY SHALL BE MAINTAINED ON SITE FOR REPLACEMENT OF BAGS. ALL NEEDED REPAIRS SHALL BE INITIATED MMEDIATELY AFTER THE INSPECTION. DISPOSE OF ACCUMULATED SEDIMENT AS WELL AS ALL USED BAGS ACCORDING TO THE PLAN NOTES.

DO NOT USE ON MAJOR PAVED ROADWAYS WHERE PONDING MAY CAUSE TRAFFIC HAZARDS.

STANDARD CONSTRUCTION DETAIL #4-15 FILTER BAG INLET PROTECTION - TYPE C INLET NOT TO SCALE

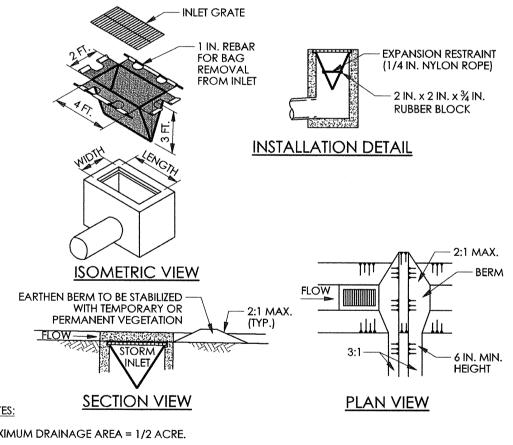

MAXIMUM DRAINAGE AREA = 1/2 ACRE.

INLET PROTECTION SHALL NOT BE REQUIRED FOR INLET TRIBUTARY TO SEDIMENT BASIN OR TRAP, BERMS SHALL BE REQUIRED FOR ALL INSTALLATIONS.

ROLLED EARTHEN BERM IN ROADWAY SHALL BE MAINTAINED UNTIL ROADWAY IS STONED. ROAD SUBBASE BERM ON ROADWAY SHALL BE MAINTAINED UNTIL ROADWAY IS PAVED. EARTHEN BERM IN CHANNEL SHALL BE MAINTAINED UNTIL PERMANENT STABILIZATION IS COMPLETED OR REMAIN PERMANENTLY. AT A MINIMUM, THE FABRIC SHALL HAVE A MINIMUM GRAB TENSILE STRENGTH OF 120 LBS., A MINIMUM BURST STRENGTH OF 200 PSI, AND A MINIMUM TRAPEZOIDAL TEAR STRENGTH OF 50 LBS. FILTER BAGS SHALL BE

INLET FILTER BAGS SHALL BE INSPECTED ON A WEEKLY BASIS AND AFTER EACH RUNOFF EVENT. BAGS SHALL BE EMPTIED AND RINSED OR REPLACED WHEN HALF FULL OR WHEN FLOW CAPACITY HAS BEEN REDUCED SO AS TO CAUSE FLOODING OR BYPASSING OF THE INLET. DAMAGED OR CLOGGED BAGS SHALL BE REPLACED. A SUPPLY SHALL BE MAINTAINED ON SITE FOR REPLACEMENT OF BAGS. ALL NEEDED REPAIRS SHALL BE INITIATED IMMEDIATELY AFTER THE INSPECTION. DISPOSE ACCUMULATED SEDIMENT AS WELL AS ALL USED BAGS ACCORDING TO THE PLAN NOTES.

DO NOT USE ON MAJOR PAVED ROADWAYS WHERE PONDING MAY CAUSE TRAFFIC HAZARDS.

CAPABLE OF TRAPPING ALL PARTICLES NOT PASSING A NO. 40 SIEVE.

STANDARD CONSTRUCTION DETAIL #4-16 FILTER BAG INLET PROTECTION - TYPE M INLET NOT TO SCALE

VMA

Villanova University

Lancaster and Ithan Avenues

Villanova PA 19085

Church Walk and Bridge

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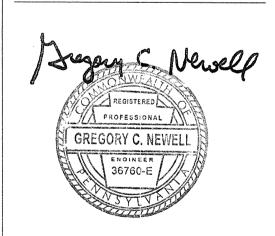
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ELEVATOR CONSULTANT Zipf Associates Inc. 25 Bala Avenue, Suite 201 Bala Cynwyd, PA 19004. phone: 610-667-1717 fax:610-667-0216





RECORD PLAN SUBMISSION


#6 October 6, 2015 Revision Date March 13, 2015


Erosion & Sedimentation Control Detail Sheet

Scale N.T.S. Drawn By DWN

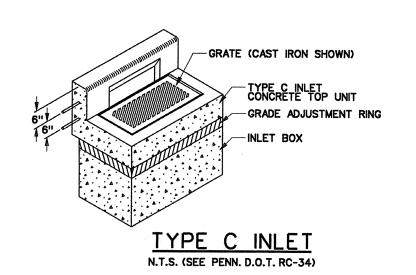

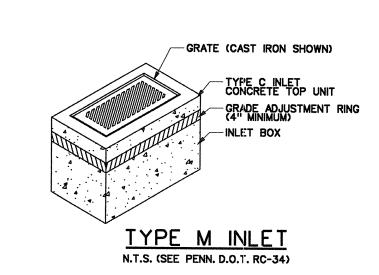


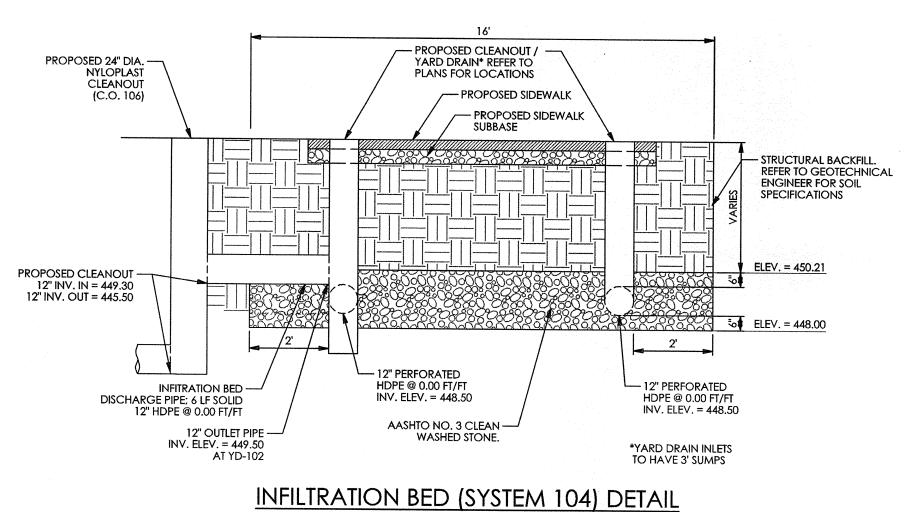

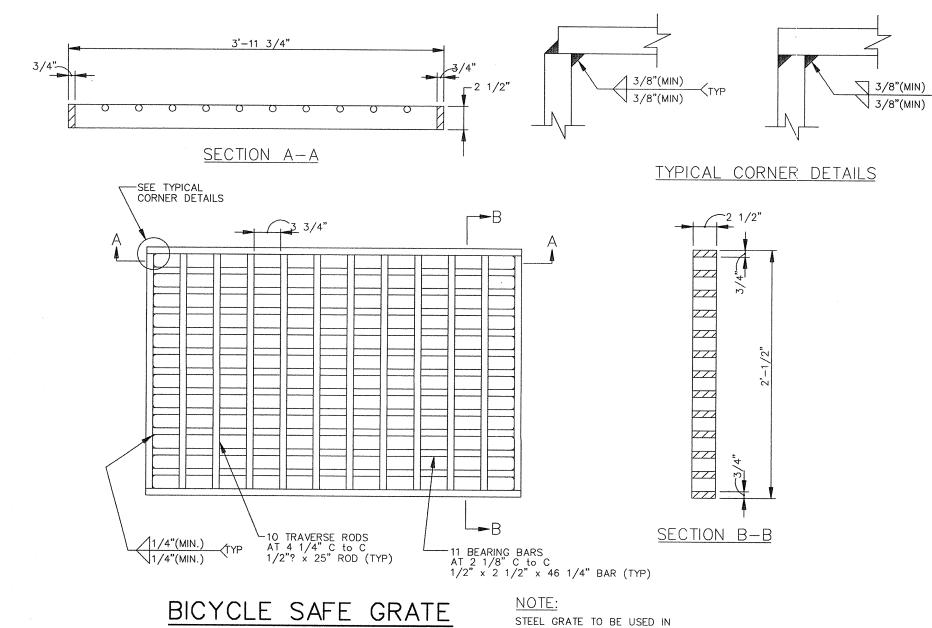


ROADWAY SUMP AND YARD INLETS ONLY. ALL OTHER INLETS

ARE TO HAVE CAST IRON VANE

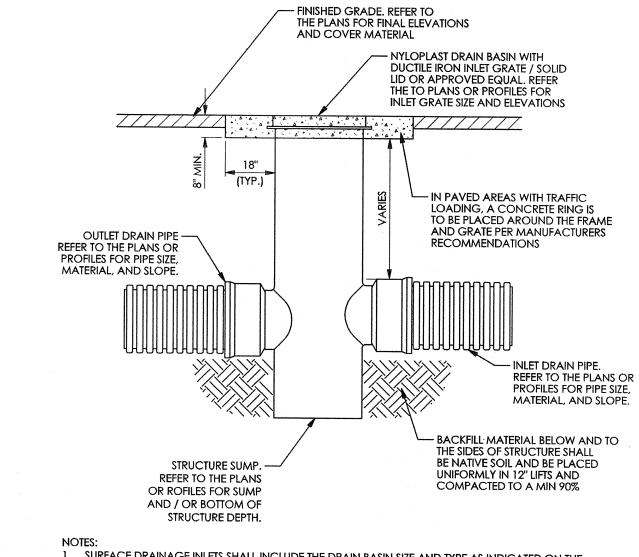


NOTES:
 SURFACE DRAINAGE INLETS SHALL INCLUDE THE DRAIN BASIN SIZE AND TYPE AS INDICATED ON THE DRAWINGS. THE DUCTILE IRON GRATES FOR EACH OF THESE FITTINGS ARE TO BE CONSIDERED AN INTEGRAL PART OF THE SURFACE DRAINAGE INLET AND SHALL BE FURNISHED BY THE SAME MANUFACTURER. THE SURFACE DRAINAGE INLETS SHALL BE AS MANUFACTURED BY NYLOPLAST, A DIVISION OF ADVANCED DRAINAGE SYSTEMS, INC., OR PRIOR APPROVED EQUAL.
 REFER TO MANUFACTURERS MATERIAL AND PRODUCT INSTALLATION SPECIFICATIONS FOR ALL BASIN, GRATE, AND BACKFILL MATERIAL SPECIFICATIONS.
 ALL PIPING JOINTS ONSITE ARE TO BE WATERTIGHT.


NYLOPLAST DRAIN BASIN / CLEANOUT

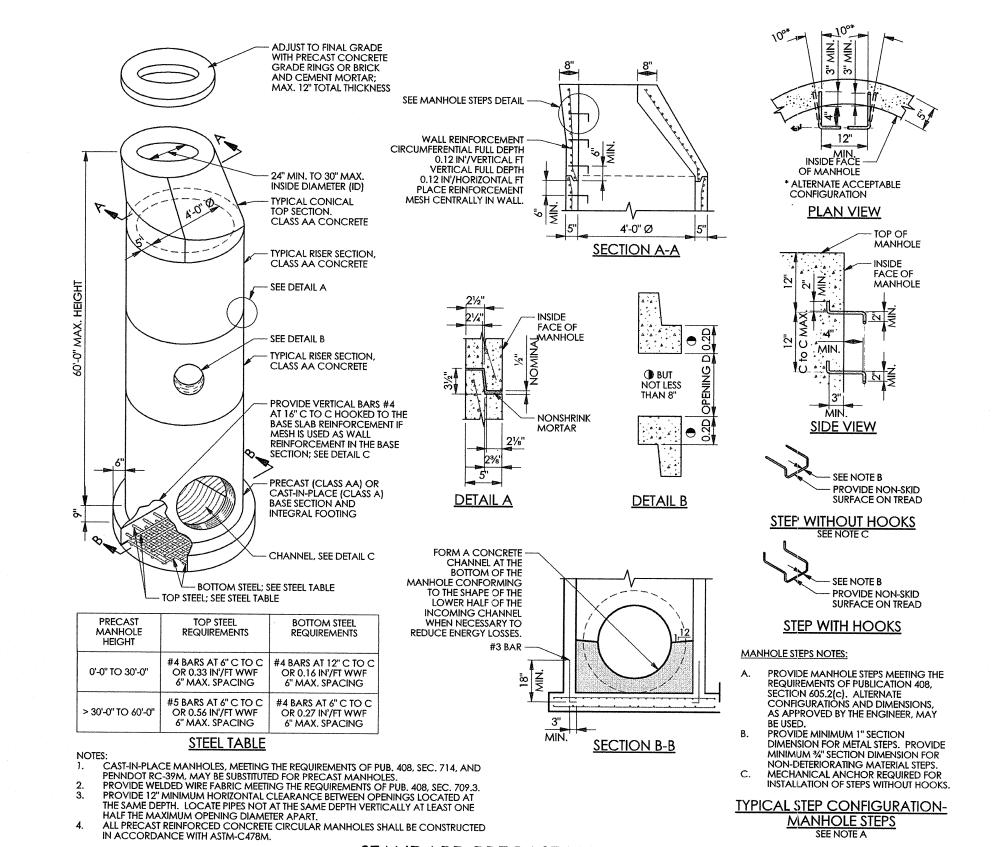


STANDARD PRECAST MANHOLE

FOR PIPES 30" INSIDE DIAMETER AND LESS. N.T.S. (SEE PENNDOT RC-39M)

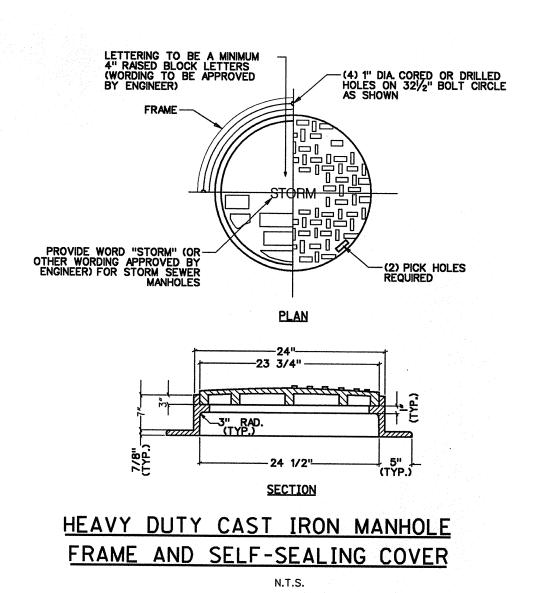


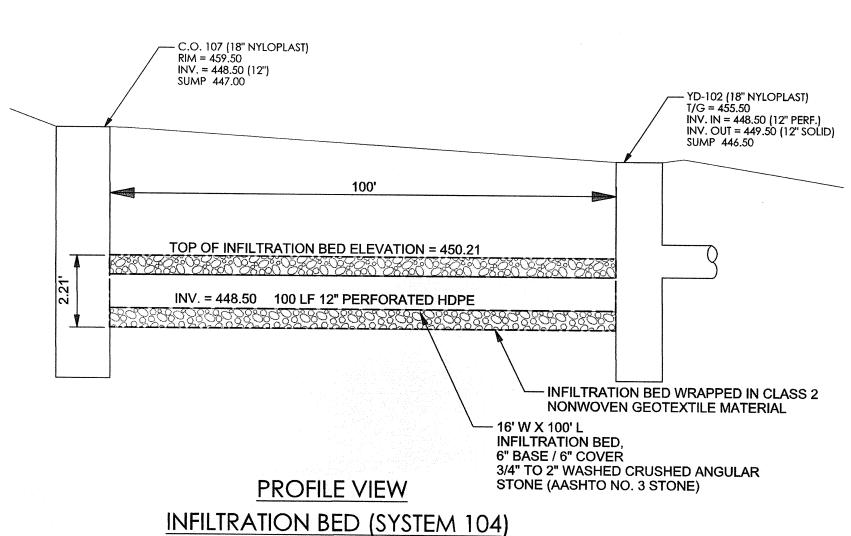

N.T.S.

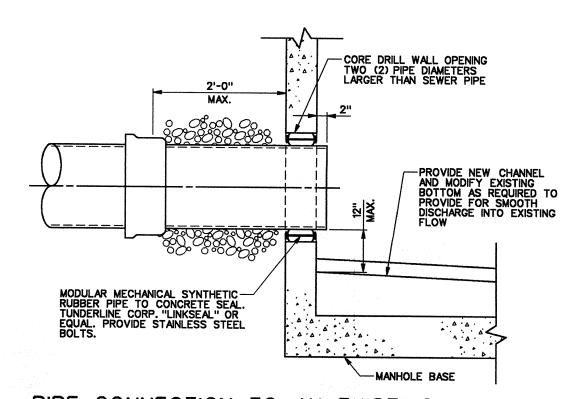


PIPE CONNECTION TO AN EXISTING MANHOLE

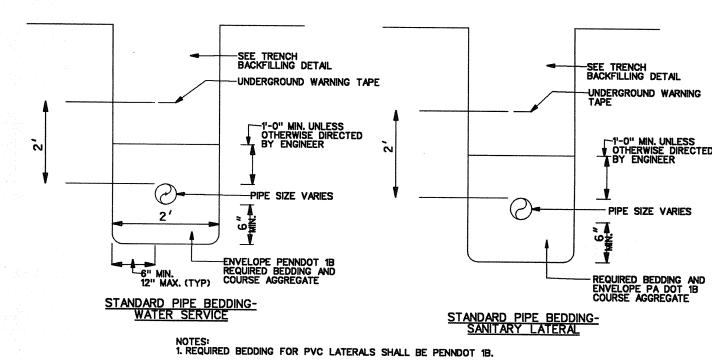

1. REQUIRED BEDDING FOR PVC LATERALS SHALL BE PENNDOT 1B.

PIPE BEDDING/ENVELOPE DETAIL

N.T.S.

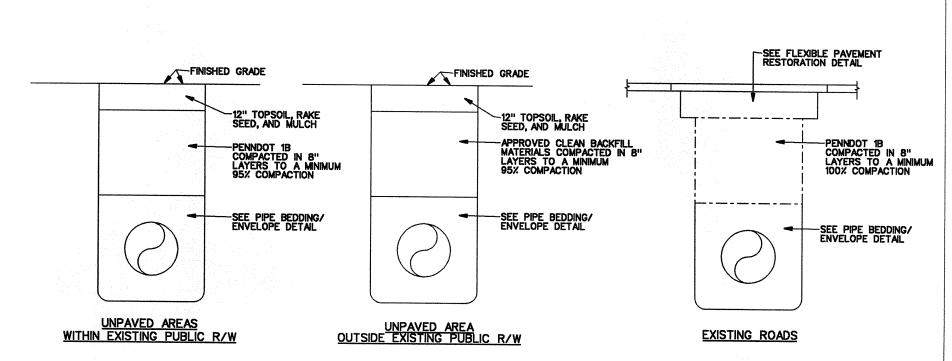

- 1. TRENCH COMPACTION TO BE TESTED, AT THE CONTRACTOR'S EXPENSE, IN ACCORDANCE WITH PENNDOT PUB 408.
- 2. CLEAN FILL MUST BE APPROVED BY THE CITY'S ENGINEER PRIOR TO PLACEMENT IN THE TRENCH.
- 3. AREAS AROUND MANHOLES AND OTHER APPURTENANCES SHALL BE HAND COMPACTED AS DIRECTED BY THE CITY'S ENGINEER.

 TRENCH BACKFILL

 N.T.S.

PRIOR TO PLACEMENT

Villanova University

Church Walk and Bridge
Lancaster and Ithan Avenues
Villanova PA 19085

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Revision #6 October 6, 2015


Date March 13, 2015

Title Construction Detail Sheet

Scale N.T.S.
Drawn By MMB

C6.1

Sheet No. 11 of 20

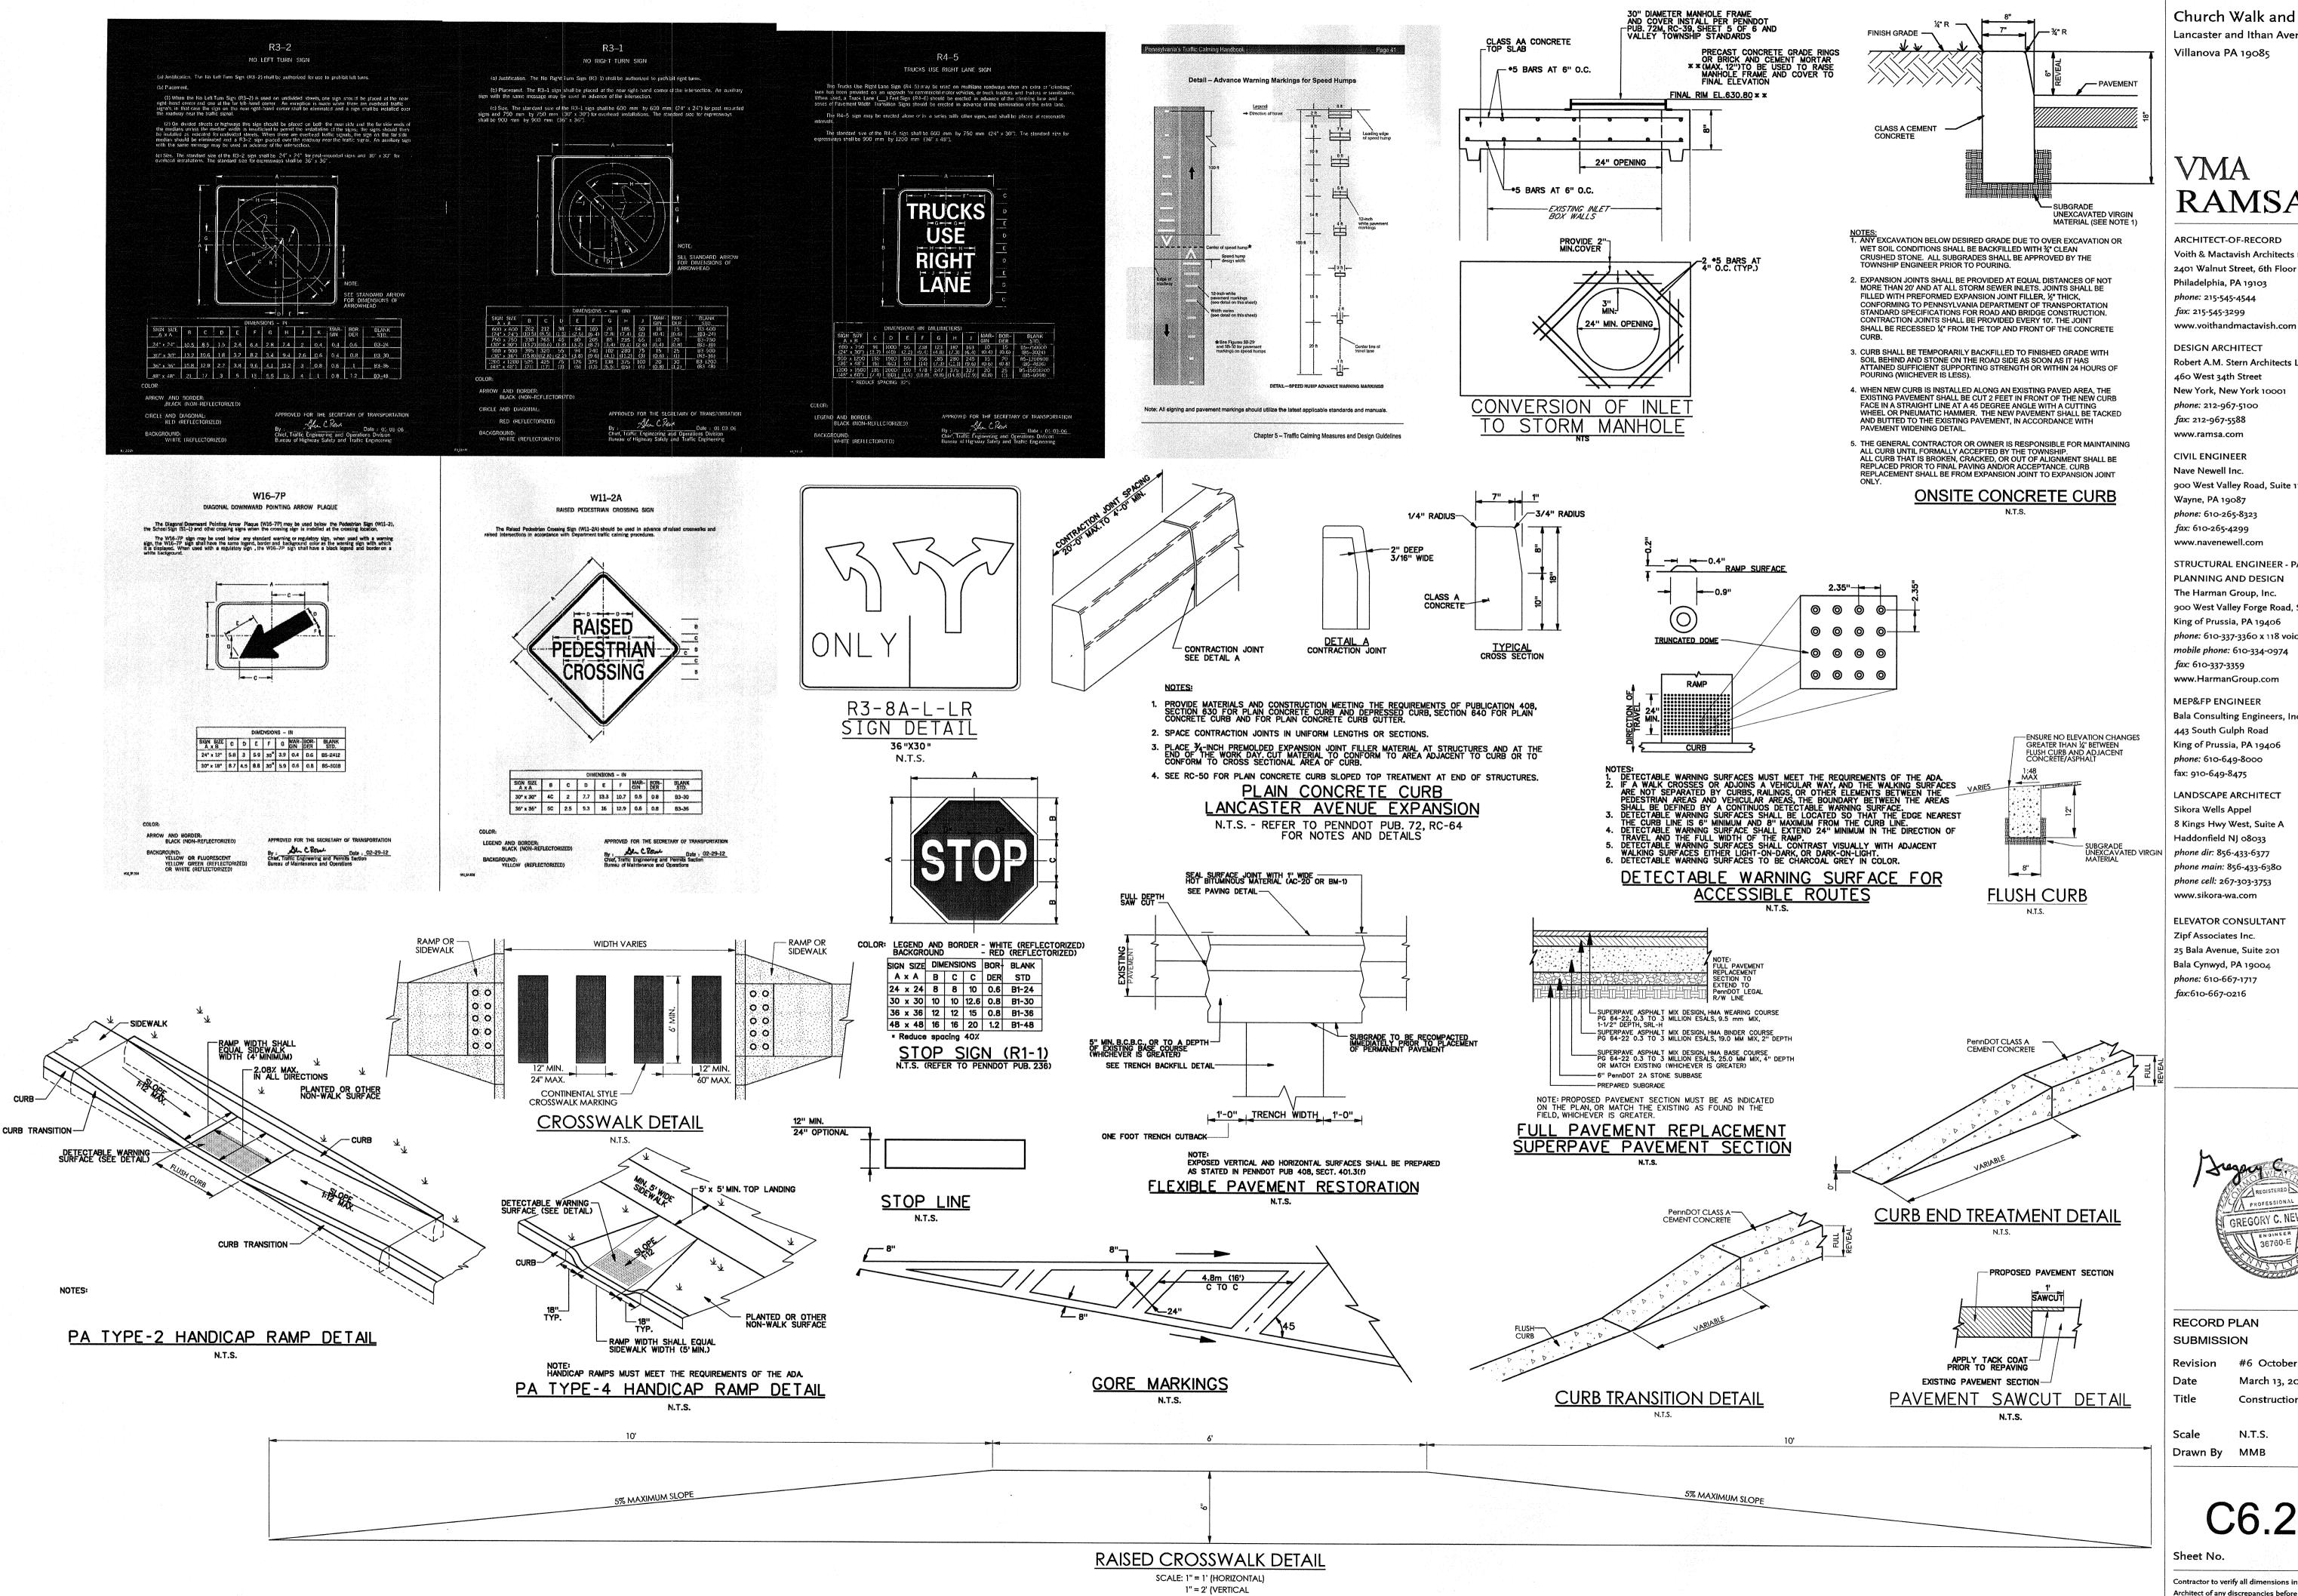

Church Walk and Bridge Lancaster and Ithan Avenues Villanova PA 19085

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RECORD PLAN


#6 October 6, 2015 March 13, 2015


Construction Detail Sheet


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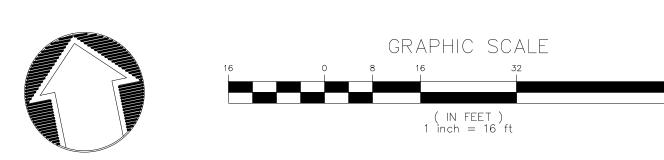
C6.2

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Lancaster and Ithan Avenues

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Church Walk and Bridge
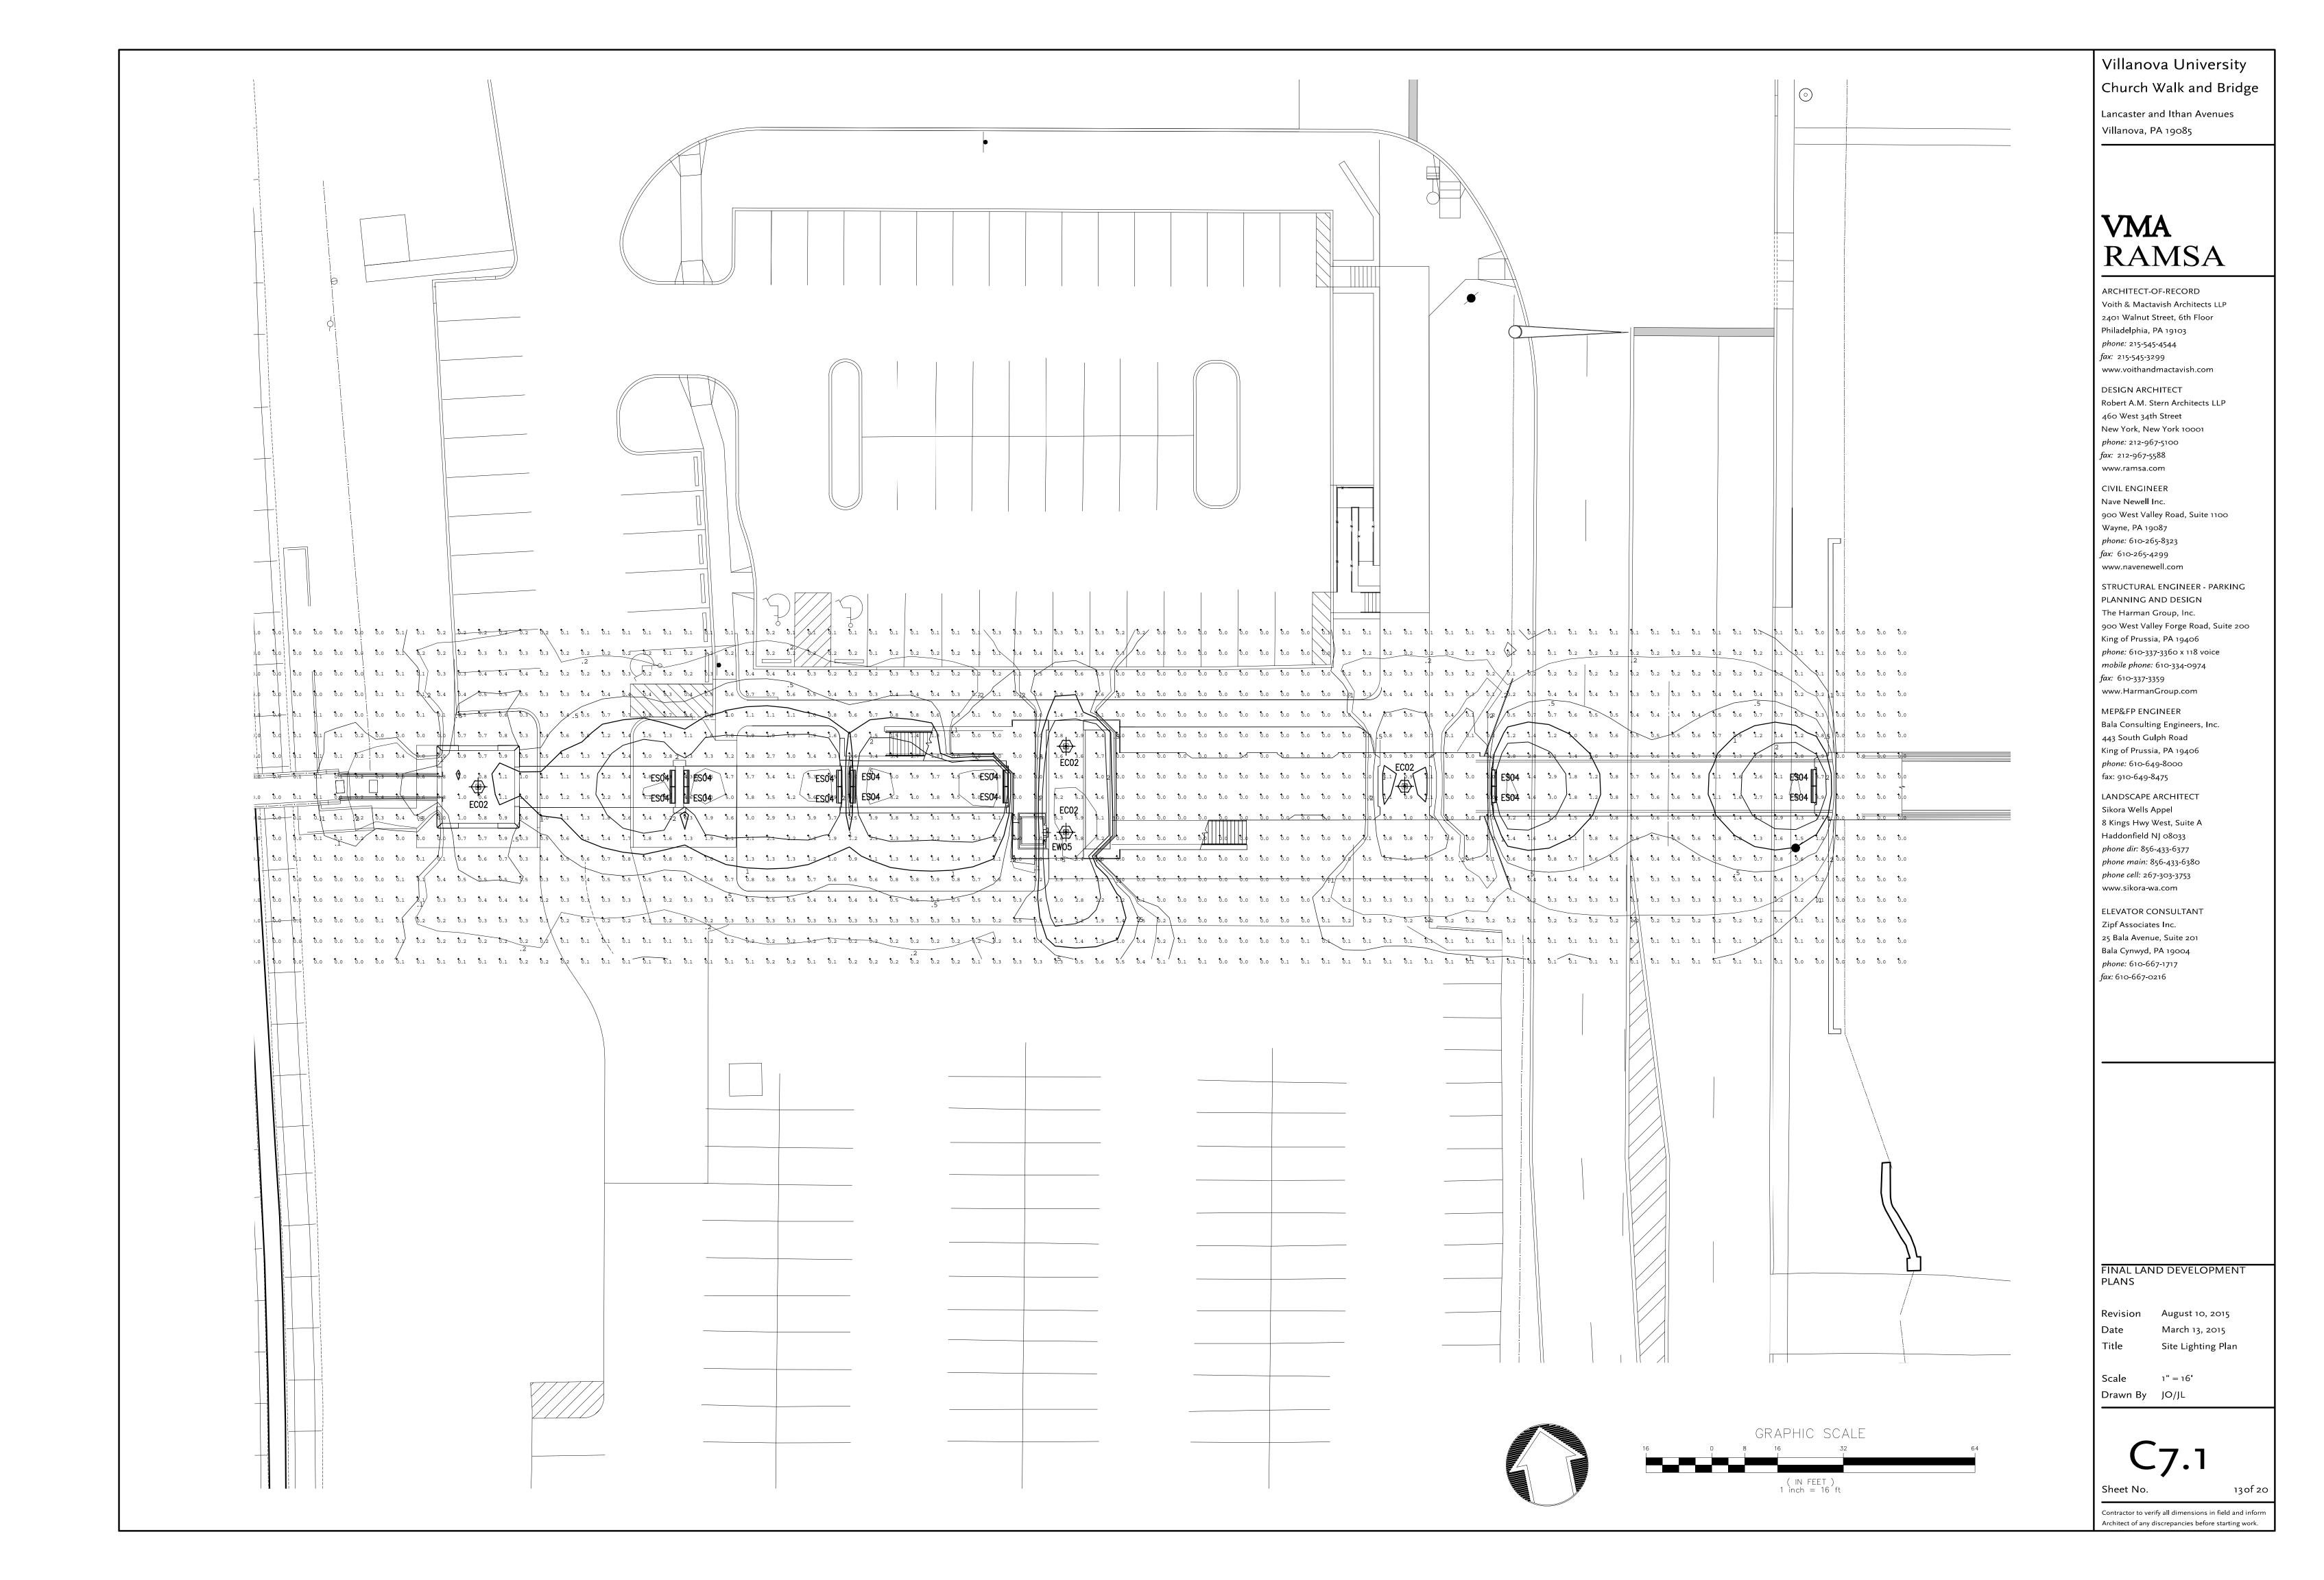
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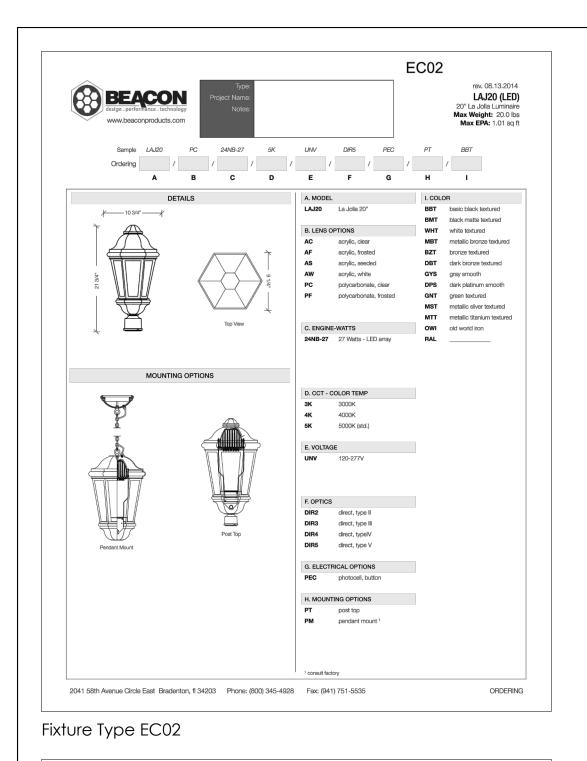
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FINAL LAND DEVELOPMENT PLANS

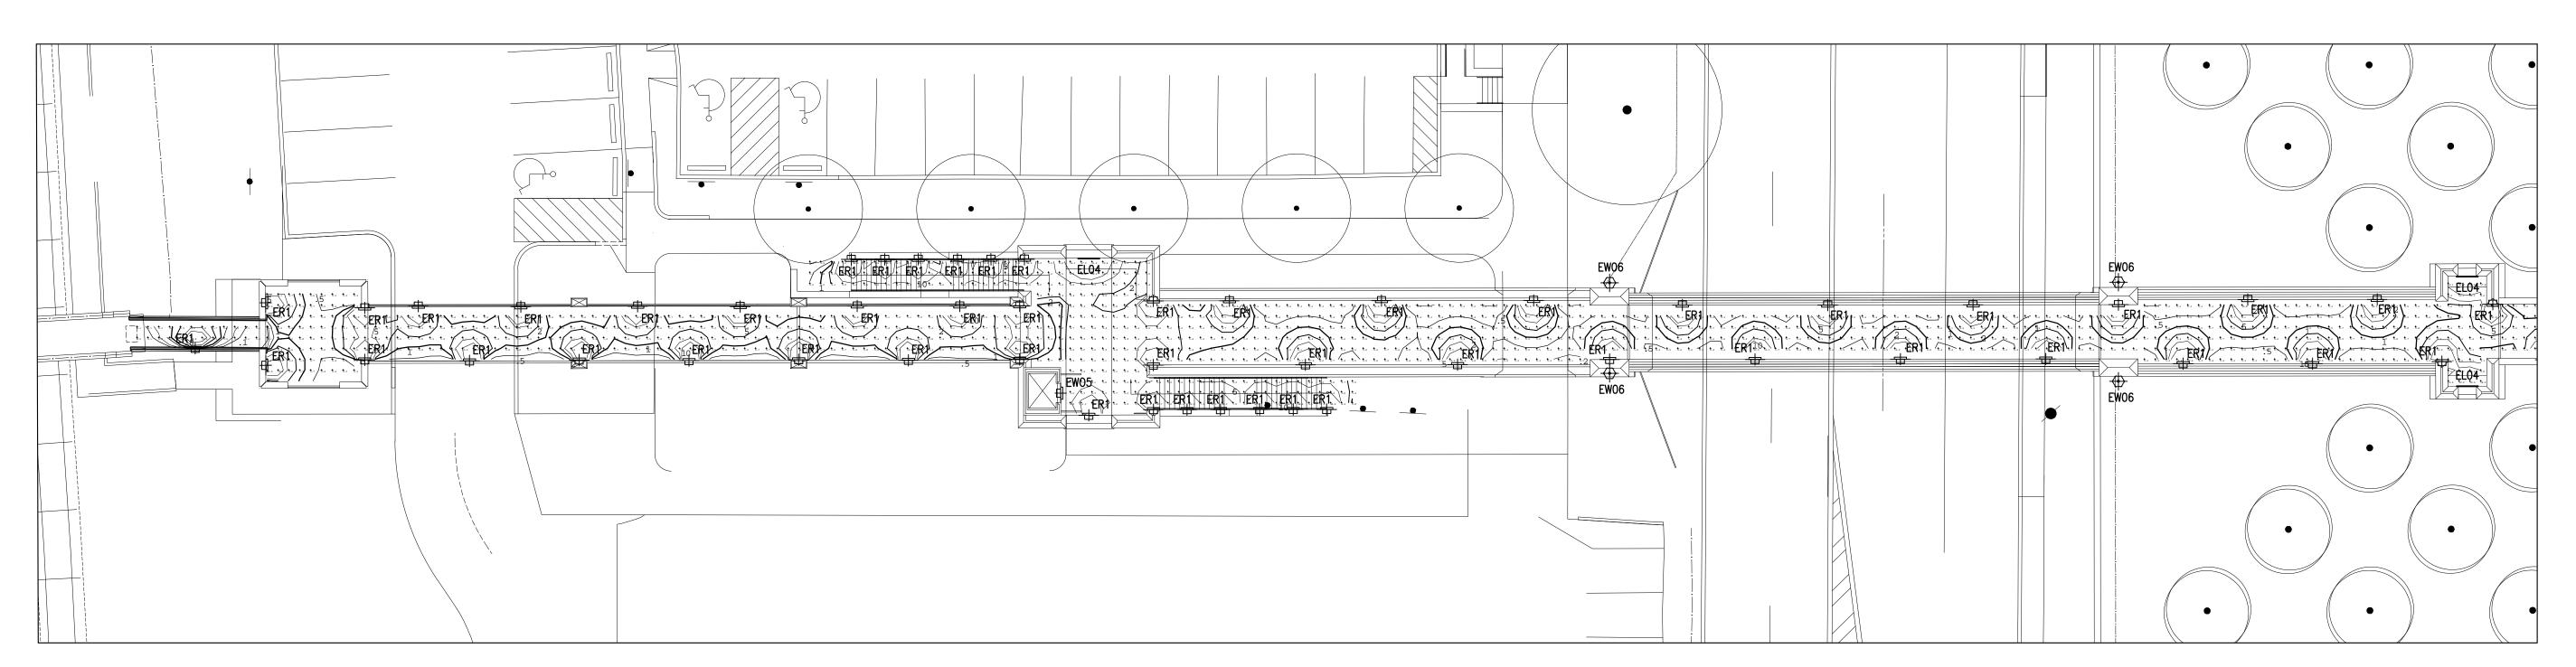Revision August 10, 2015 March 13, 2015 Date Site Lighting Plan Bridge level Scale 1" = 16' Drawn By JO/JL

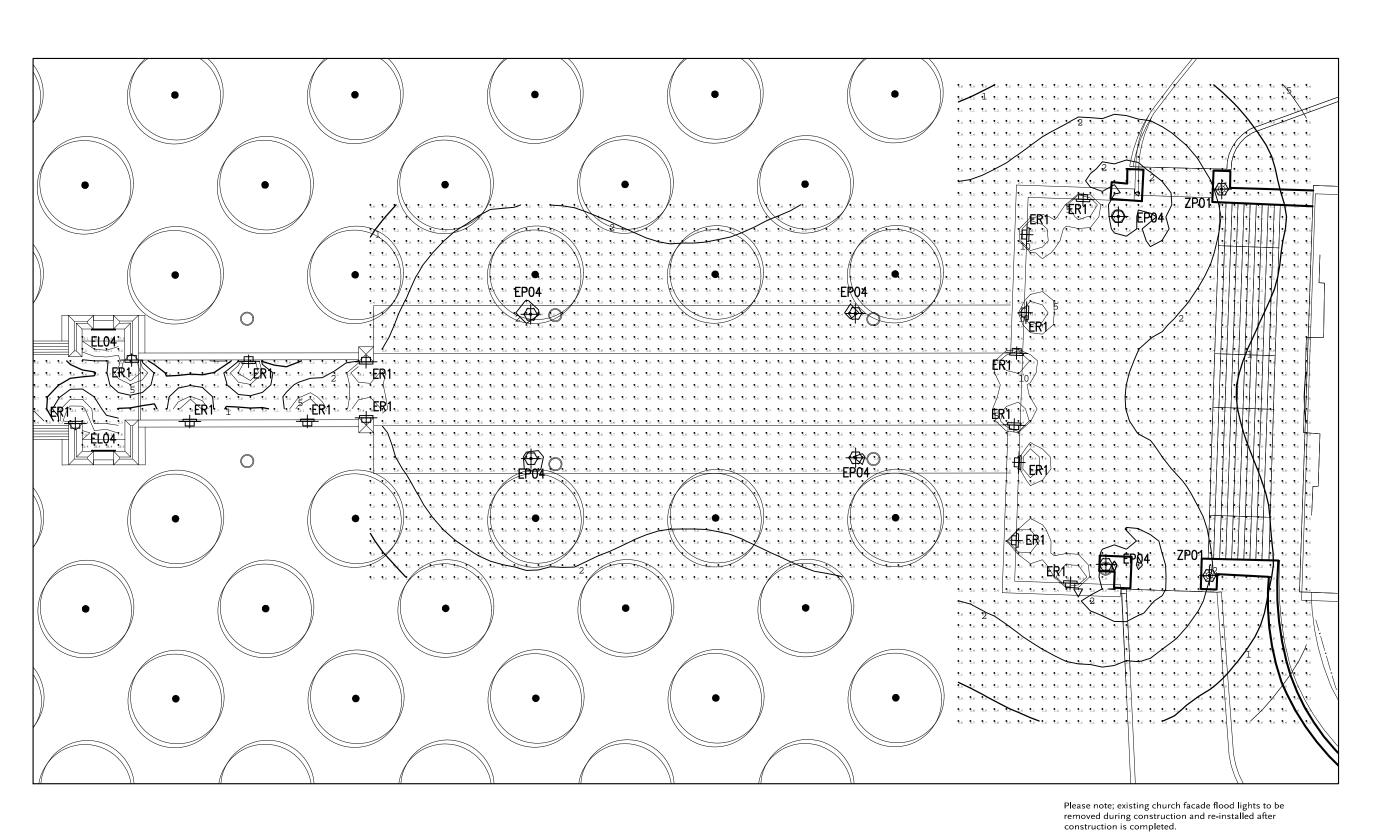

LED Lighting Lantern Fixtures

SPECIFICATIONS

EPA = 2.46 (ft²) WEIGHT = 55 LBS

SternbergLighting

LUMINAIRE DESIGN

(B) decorative spikes.

6 ½" decorative spiked finial.

mounted, downlighting optics.

to a 3", 4", 5", 6" or 7" pole or tenon.

heat transfer to the heat sink surface.

by a conformal coating of 1 to 3 mils.

and shall be RoHS compliant.

Fixture Type ES04

(with 3" tenon).

POST FITTER

tensile strength.

LIGHT SOURCES

MS805A / MS805B LED MAIN STREET

• The luminaire shall be a modern replica of a popularly

• The MS805A LED luminaire shall be 17 1/2" (19" on the

diagonal) and 38" tall (with 3" tenon). The MS805B LED

• The luminaire shall be appointed with a cast aluminum

• The luminaire shall have LED light sources with roof

• The luminaire shall be supplied with line-ground,

line-neutral and neutral-ground electrical surge protec-

tion in accordance with IEEE/ANSI C62.41.2 guidelines.

• The luminaire shall be U.L. or E.T.L. listed in the U.S.

The fitter shall be heavy wall cast aluminum for high

• The fitter shall have an inside diameter opening to attach

• When ordered with a Sternberg pole, the fitter shall be

• The LED driver shall be securely mounted inside the fitter, for optimized performance

• The LED driver shall be supplied with a quick-disconnect electrical connector on the

• The LEDs shall be mounted in arrays, on printed circuit boards designed to maximize

• The LEDs shall be attached to the printed circuit board with not less than 90% pure

• The LEDs and printed circuit boards shall be protected from moisture and corrosion

and 100% recyclable. They shall not contain lead, mercury or any other hazardous substances

• The LED life rating data shall be determined in accordance with IESNA LM-80.

• The LEDs and printed circuit board construction shall be environmentally friendly

power supply, providing easy power connections and fixture installation.

• The luminaire shall use high output, high brightness LEDs.

• The LED arrays shall be roof mounted to minimize up-light.


silver to insure optimal electrical and thermal conductivity.


attached by set-screw to the pole top or tenon.


luminaire shall be 16" (17" on the diagonal) and 38" tall

styled octagonal fixture, available with (A) or without


EP01,EP02,EP04,EP05,EP06,EP17,(1 of 3)

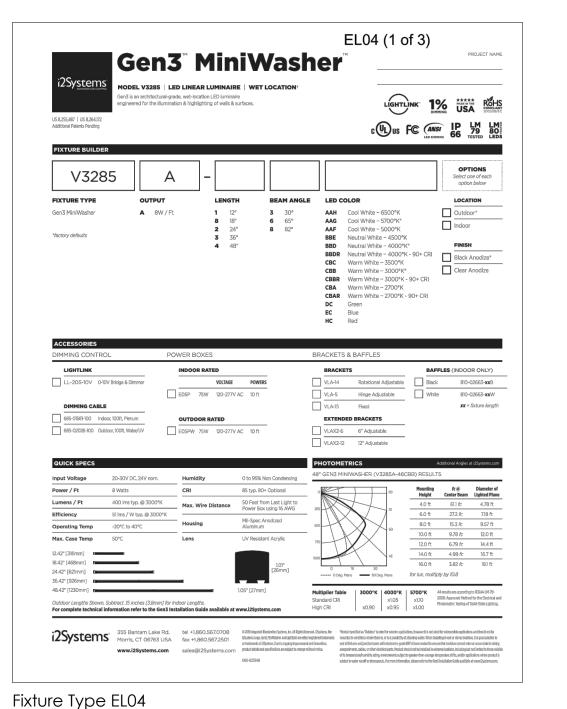

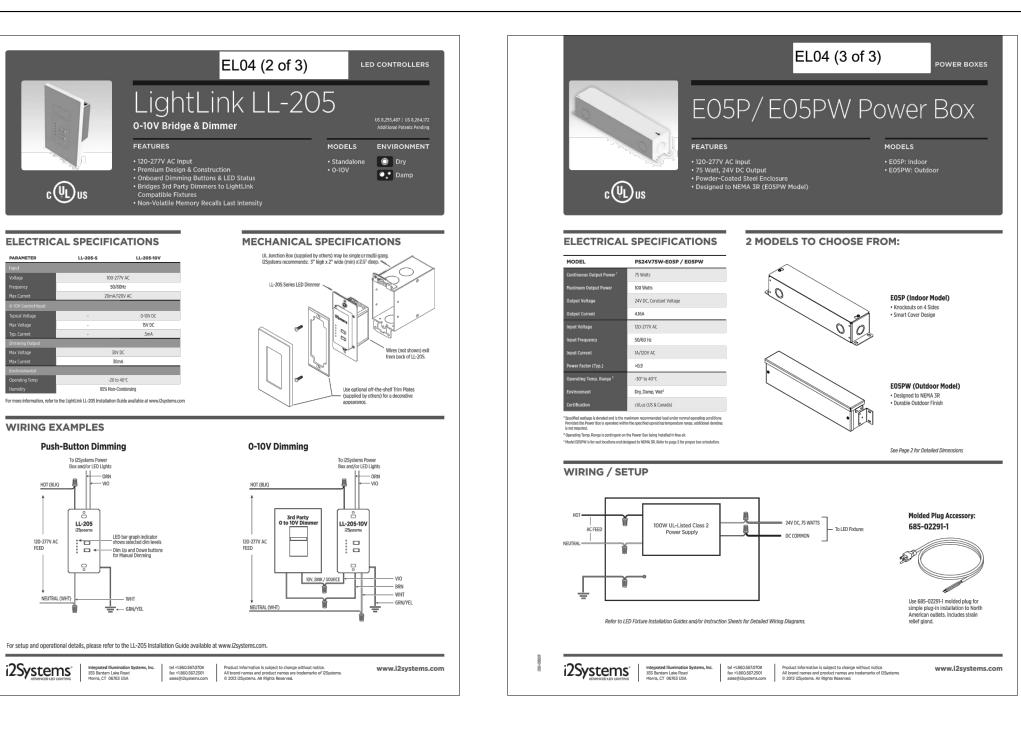

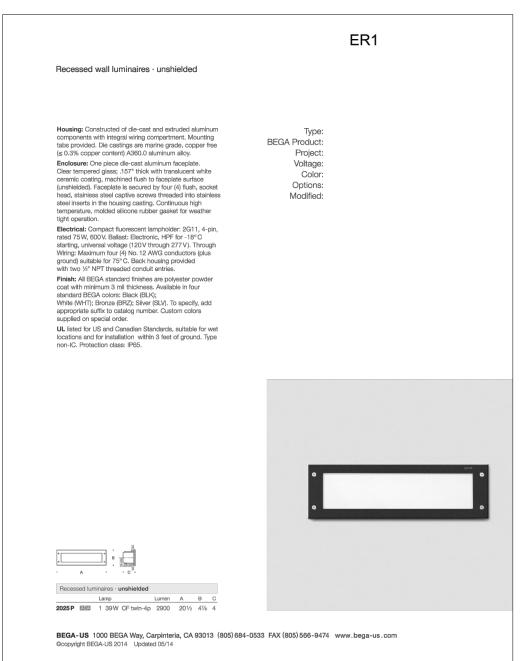

Fixture Type ER1

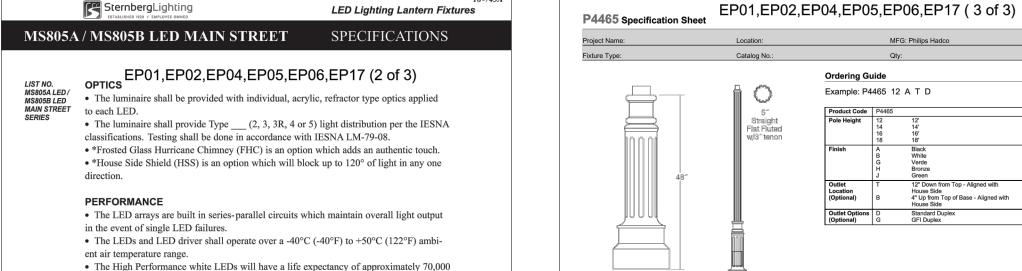

ELECTRICAL SPECIFICATIONS

WIRING EXAMPLES

Push-Button Dimming

color temperature with a minimum of 70 CRI. • The luminaire shall have a minimum _____ (see table) delivered initial lumen rating when operated at steady state with an average ambient temperature of 25°C (77°F).
 Light Source
 T2
 Walt
 T3
 Walt
 T3R
 Walt
 T4
 Walt
 T6
 Walt
 Walt
 Walt

 1RND2772-MD_03-CA
 1930
 60.3
 1920
 60.0
 2000
 62.5
 1975
 61.7
 2110
 65.9
 32

 1RND3572-MD_03-CA
 2205
 68.9
 2185
 68.3
 2280
 71.3
 2265
 70.5
 2405
 75.2
 2560
 75.2
 32

 1RND4572-MD_03-CA
 2350
 73.4
 2330
 72.8
 2430
 75.9
 2405
 75.2
 2560
 80.0
 32

 4ARC2712-MD_03-CA
 3730
 56.5
 3825
 58.0
 3880
 58.5
 3895
 58.9
 3970
 60.2
 66

 4ARC3712-MD_03-CA
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 4695
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 94


 4A1R3712-MD_03-CA
 5430
 57.8
 5650
 60.1
 5515
 58.7
 5500
 58.5

hours with not less than 70% of original brightness (lumen maintenance), rated at 25°C.

• The High Brightness, High Output LED's shall be 4500K (2700K or 3500K option)


ELECTRONIC DRIVERS The driver shall be U.L. or E.T.L. Recognized.

 The driver shall have overload as well as short circuit protection. • The driver shall be a DC voltage output, constant current design, 50/60HZ.

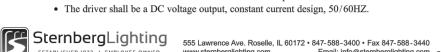





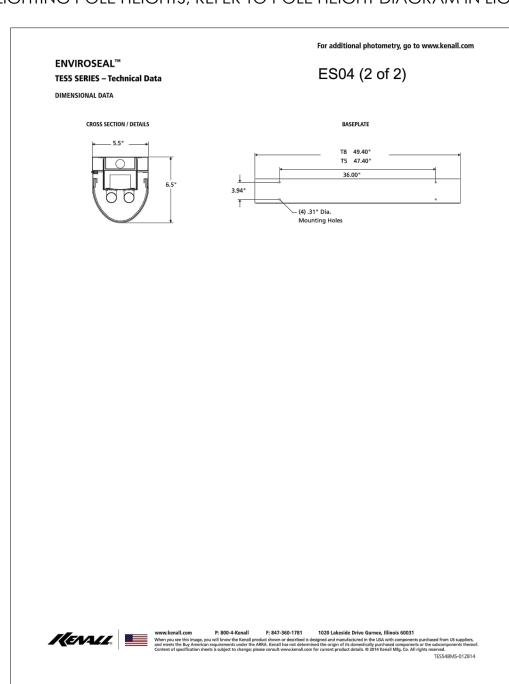



Ordering Guide

HOUSING: 356 HM high-strength, low-copper, proprietary cast aluminum alloy . 6005-T5 extruded aluminum. Anchor rods are hot dipped galvanized steel . Tenon is 356 HM sand cast aluminum.

FINISH:

A durable polyurethane enamel finish is applied after assemblies are shot blasted to create a surface profile which allows for the highest level of paint adhesion. Laboratory tested for superior weatherability and fade resistance in accordance with ASTM B-117-84 and ANSI/ASTM G53-77 specifications. For larger projects where a custom color is required, contact the factory for more information.

OUTLET:
Standard Duplex Outlet has universal metal weatherproof cover. Weatherproof while in use. Heavy-duty all-metal construction. Lockable security cover. Meets NEC 406.9 (B).
Weather resistant. GFI Duplex Outlet has dual-function indicator light, universal metal weatherproof cover. Weatherproof while in use. Heavy-duty all-metal construction. Lockable security cover. Meets NEC 406.9 (B). Weather resistant.

PHILIPS

Note: Philips reserves the right to modify the above details to reflect changes in the cost of materials and/or production and/or design without prior notice.

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Example: P4465 12 A T D

Outlet T 12" Down from Top - Aligned with House Side (Optional) B 4" Up from Top of Base - Aligned with House Side

Fixture Type ZP1

Bolt Circle: 8" - 12"

Anchor Rods: (4) 3/4" dia. x 19"

Base Dimensions 15 1/2" dia. x 48"

ISO 9001:2008 Registered

HALL HW

Hand Hole: 11" x 5"

Shaft:

LIGHTING FIXTURE SCHEDULE

TYPE	DESCRIPTION:	MFR	CATALOG#	LAMP MFR	LAMP TYPE	QTY	WATTS	VOLTS	APERTURE	DEPTH	O.A.H.	DARK SH REMARK
		BEACON LIGHTING	LAJ20-AC- 24NB-27-4K- UNV-DIR5-BBT	INCLUDED			27	120	10 3/4"W	21 3/4" H	N/A	See note
	EXTERIOR 4-0" LONG LINEAR LED FIXTURE WITH NEUTRAL WHITE DISTRIBUTION, WIDE BEAM ANGLE, REMOTE DRIVER AND OUTDOOR RATING. PROVIDE EXTERIOR GRADE NEMA BOX FOR REMOTE DRIVER. REFER TO ARCHITECTURAL DETAILS FOR MOUNTING AND ELECTRICAL FEED.	I2systems	V3285-A-4-8- BBD-E05PW- VLA-15	INCLUDED			32	120	1"X1"	48"L	N/A	See note
	LANTERN FIXTURE WITH CAST ALUM. HOUSING,	STERNBERG LIGHTING / HADCO	MS805ALED/3/ OTHER/4AIR- 45- T5/MDL/CA/BK T - P4465- 12'-A	INCLUDED			57	120	15"W	26"h	14'-2" O.A.H.	See note
	RECESSED COMPACT FLUORESCENT WALL LIGHT WITH INTEGRAL ELECTRONIC BALLAST, CLEAR LENS WITH TRANSLUCENT WHITE CERAMIC COATING. CUSTOM COLOR. LOCATED ON BRIDGE; REFER TO ARCHITECTURAL DETAILS FOR DIFFERENT MOUNTING CONDITIONS AND ELECTRICAL FEED.	BEGA LIGHTING	2025P	PHILIPS	PL-L 39	1	39	120	4 7/8" X 20 1/2"	4"	N/A	See note
	EXTERIOR SURFACE MOUNTED LINEAR FLUORESCENT HIGH ABUSE FIXTURE WITH INTEGRAL ELECTRONIC BALLAST, WHITE POLYCARBONATE WRAP AROUND DIFFUSER AND BRUSHED STAINLESS STEEL FINISH. PROVIDE PIGEON SPIKES ON TOP OF FIXTURE.	KENALL	TES548MS-232 RS-1-120-PP	PHILIPS	F32T8/TL830/A LTO	2	54	120	5.5"H	6.5" Ext.	N/A	See note
	EXTERIOR SURFACE WALL MOUNTED TRAPAZOIDAL WEDGE LED DOWNLIGHT SCONCE WITH INTEGRAL DRIVER, TYPE III OPTICS, NEUTRAL WHITE LIGHT OUTPUT AND RAL PAINT COLOR FINISH TO BE SELECTED BY ARCHITECT.	GARDCO LIGHTING	101L-TYPE III- 55-NW-UNIV- OC	INCLUDED			55	120	16 1/4"W x 7"H	9" Ext.	N/A	See note
	EXTERIOR DECORATIVE CUSTOM WALL MOUNTED FIXTURE W/ (10) DIMMABLE PHILIPS FORTIMO WARM WHITE, HIGH OUTPUT LED STRIPS. REFER TO ARCH. DETAILS FOR CUSTOM HOUSING INFO. LOCATED ON STONE BRIDGE ABUTMENT.	PHILIPS	9290-008- 57803-80CRI- 3000*k	INCLUDED			55	120	1'-1 1/2" Wide	24" High	N/A	See note
	EXISTING EXTERIOR METAL HALIDE PIER MOUNTED FIXTURE TO REMAIN. Fixture Cut-Off Notes.	V.I.F.	V.I.V.	V.I.F.	V.I.F	1	V.I.F.	V.I.F.	V.I.F.	V.I.F.	N/A	Existing
	Note 1. Fixture is located inside Pike Garaç Note 2. Fixture is a full cut-off fixture; refer Note 3. Fixture is located in covered exterio	to photometr or passagewa	ay.			ighti	ng Desi	gn Boo	k.			
	Note 4. Fixture is shielded by a custom me Note 5. Fixture has a fully recessed light so of pole and refracted light from glass lanter Note 6. Fixture is located on bridge and ou pedestrians on bridge.	ource with no n.	direct uplight	componen	and an over							
	Note 7. Fixture is located outlisde CICD are	a and under	bridge and rai	mp.								

(*) OAH = OVERALL HEIGHT

Villanova University Church Walk and Bridge

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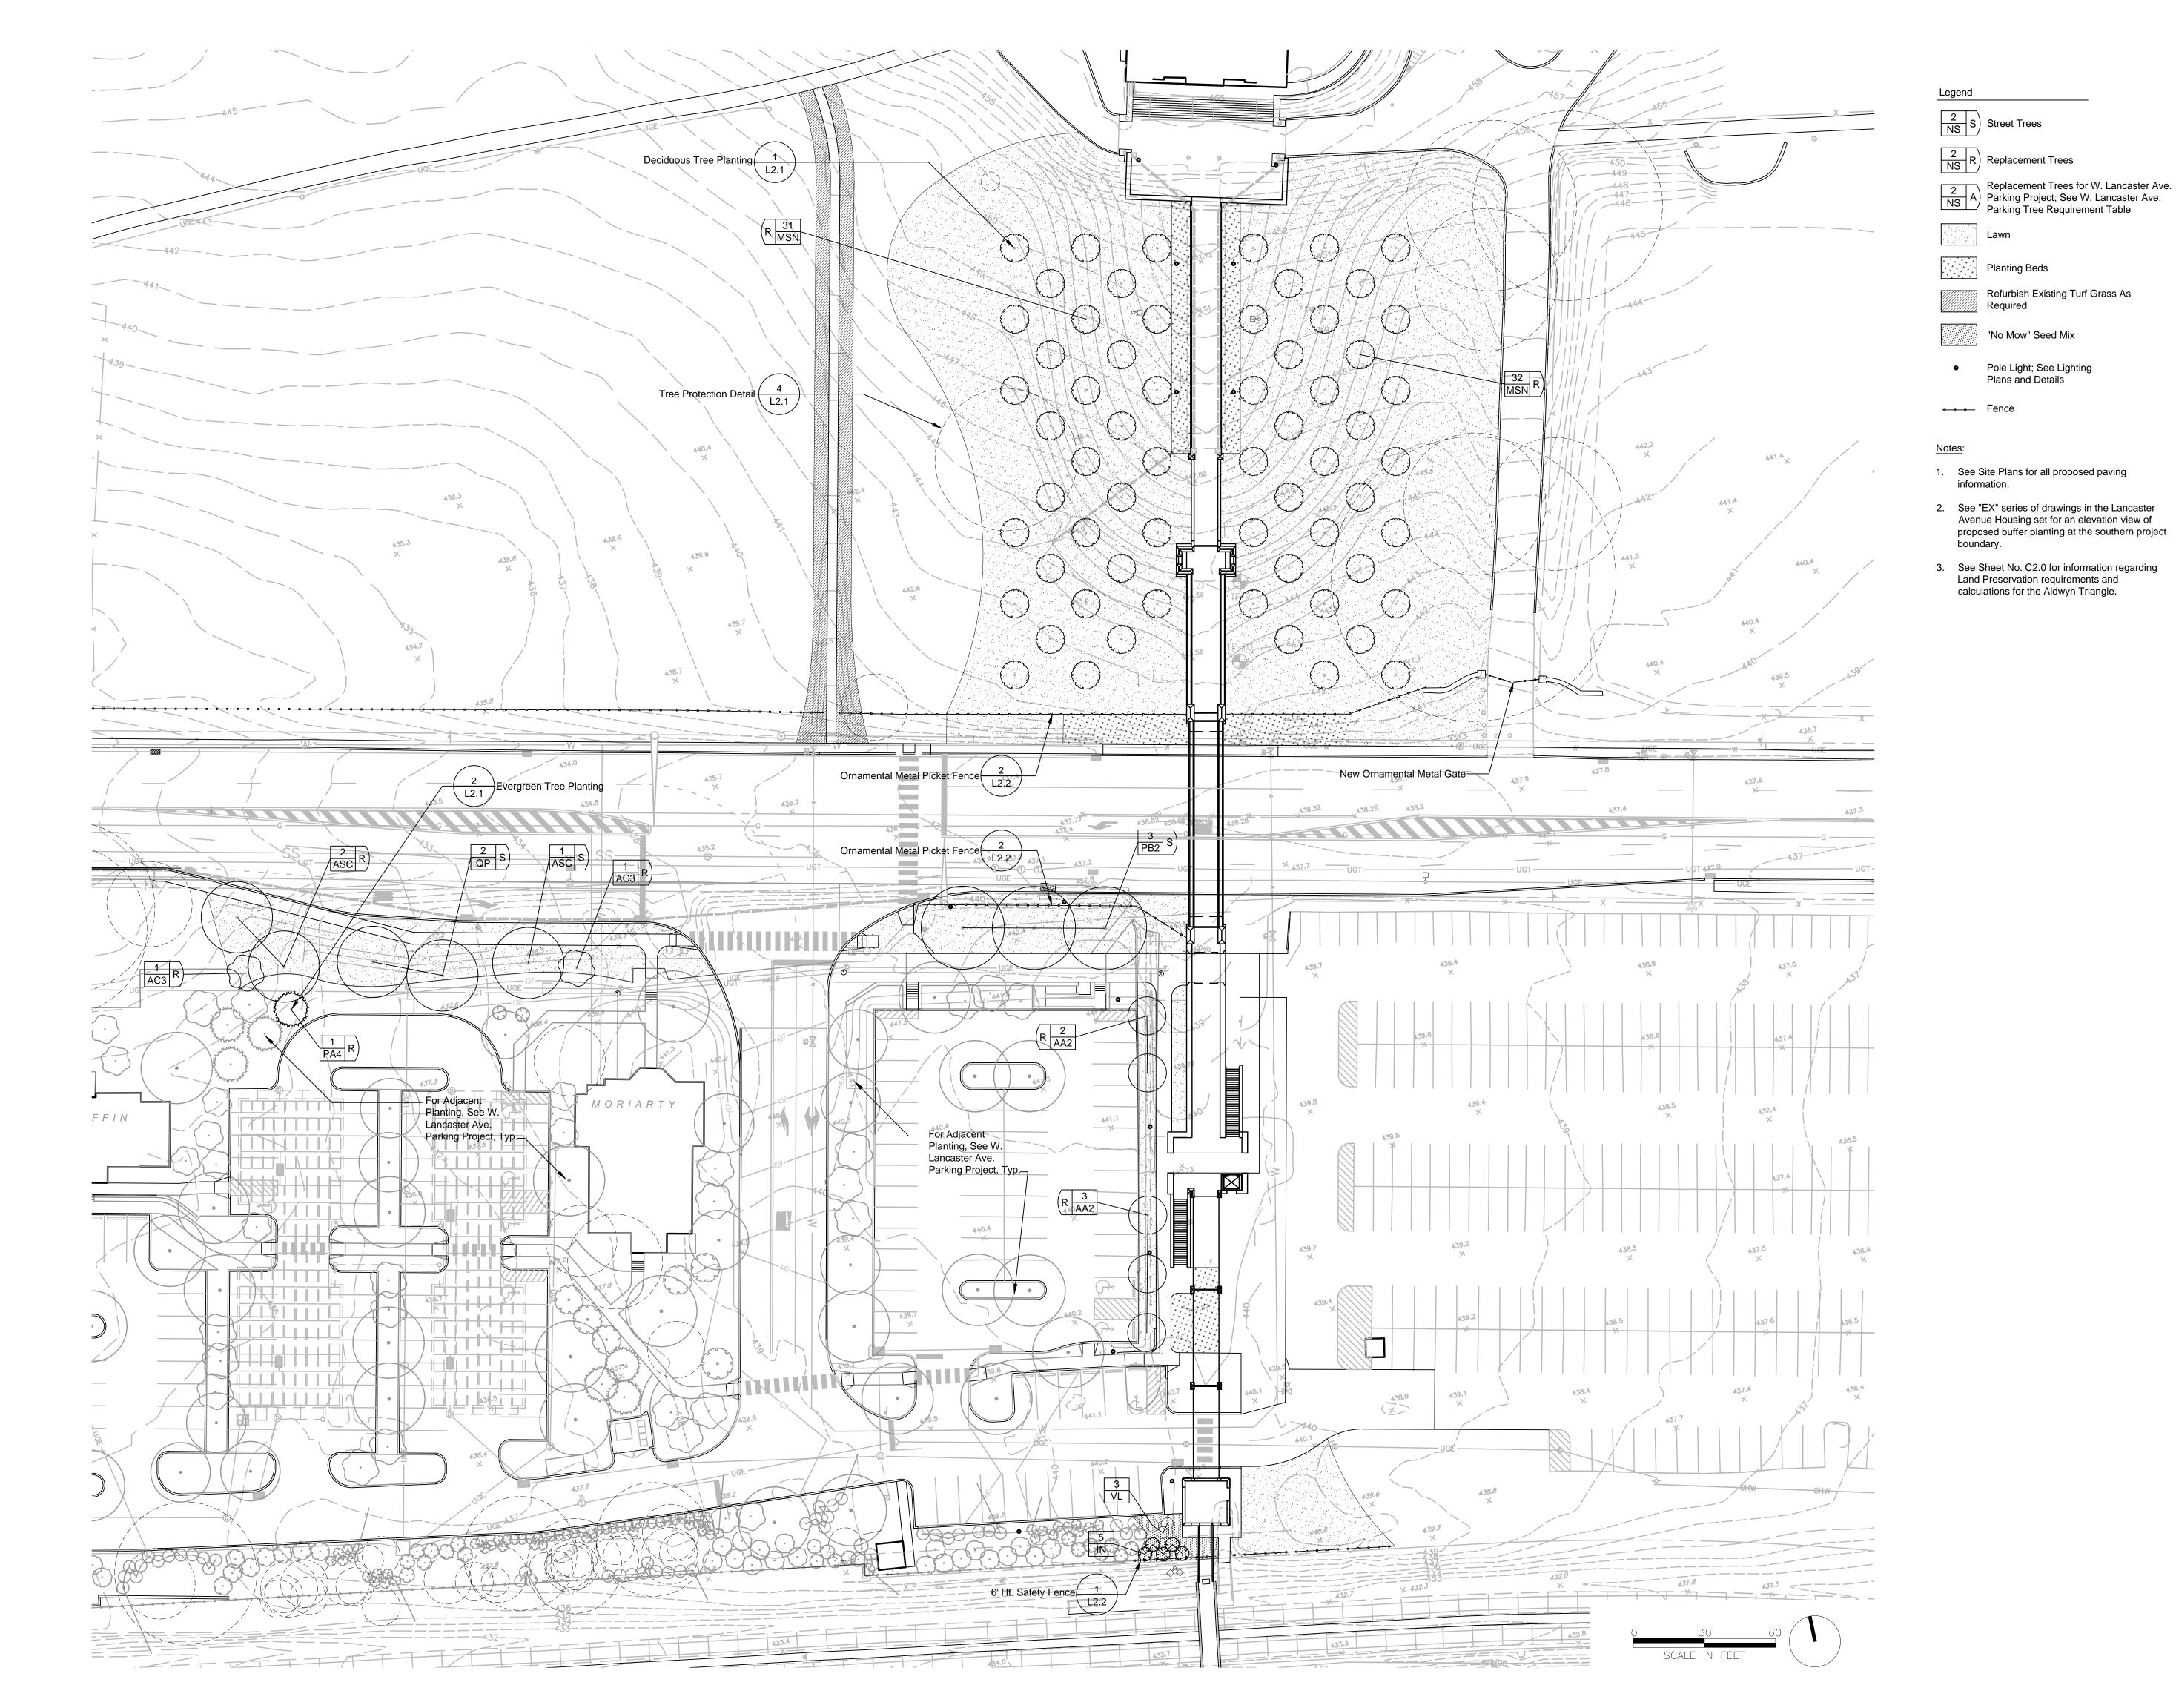
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FINAL LAND DEVELOPMENT PLANS

Revision August 10, 2015 Date March 13, 2015 Title Site Lighting Details

Scale NTS Drawn By JO/JL

Sheet No.



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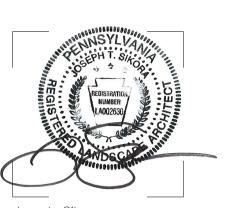
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FINAL LAND DEVELOPMENT SUBMISSION

Revision August 10, 2015

Date March 13, 2015

Title Planting Plan

le 1" = 30'-0"

Scale 1" = 3
Drawn By RM

L1.0

Sheet No.

Contractor to verify all dimensions in field and inform Architect of any discrepancies before starting work.



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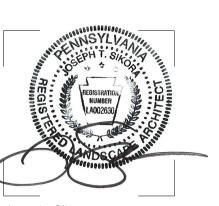
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FINAL LAND DEVELOPMENT SUBMISSION

Revision August 10, 2015

Date March 13, 2015

Title Planting Plan at Aldwyn Triangle

Scale 1" = 30'-0"

Drawn By RM

L1.1

Sheet No. 17 of 20

	REQUIRED	PROPOSED
STREET TREES		•
LANCASTER AVENUE (South Side Only) = 164' FT. SECTION 255-38.B INTERVALS OF NOT MORE THAN 30 FEET	164'/30' = 5 TREES	6 TREES
BUFFER SCREENS		
SOUTHERN PROPERTY LINE ADJACENT TO R-100 TRAIN RIGHT OF WAY SECTION 255-42 CLASS 'B' BUFFER SCREEN OPTION SELECTED: (1) EVERGREEN PER 15 FEET (INFORMALLY ARRANGED) PLUS; (1) EVERGREEN SHRUB PER 8 FEET (INFORMALLY ARRANGED)	26'/15' = 2 EVERGREEN TREES 26'/8' = 3 EVERGREEN SHRUBS	5 EVERGREEN TREES 3 EVERGREEN SHRUBS
REPLACEMENT TREES		•
6 TO 18 INCH DBH REMOVED = (1) REPLACEMENT TREE 19 TO 29 INCH DBH REMOVED = (3) REPLACEMENT TREES** 30 INCH DBH OR GREATER REMOVED = (6) REPLACEMENT TREES***	(73) REMOVALS @ 6 TO 18 INCH = 73 REPLACEMENTS (1) REMOVALS @ 30 INCH+ = (1) x 6 = 6 REPLACEMENTS TOTAL REPLACEMENT TREES REQUIRED = 79 TREES	LARGE CANOPY TREES = 7 TREES ORNAMENTAL TREES = 71 TREES EVERGREEN TREES = 1 TREES TOTAL TREES PROPOSED = 79 TREES (INCLUDES 6 ORNAMENTAL TREES AT ALDWYN TRIANGLE - SEE SHEET L1.1 FO LOCATIONS)

NOTES:

 QUANTITY, AND ARRANGEMENT OF PLANT MATERIAL WITHIN BUFFER SCREEN WILL PRODUCE A VISUAL SCREEN NOT TO BE SEEN THROUGH AND PROVIDE IMMEDIATE VISUAL SCREENING TO THE ABUTTING PROPERTY OR DISTRICT AS PER SECTION 280-71.A. OF THE TOWNSHIP ZONING ORDINANCE.

PLANT SCHE	DUL	_E					
CANOPY TREES	QTY	BOTANICAL NAME	COMMON NAME	CONT	CAL	SIZE	REMARKS
AA2	5	ACER RUBRUM `ARMSTRONG`	ARMSTRONG RED MAPLE	В&В	2 1/2" - 3"		MATCHED SPECIMENS
AS	4	ACER RUBRUM `SOMERSET`	SOMERSET RED MAPLE	В&В	2" - 2 1/2"		
ASC	7	ACER SACCHARUM `COMMEMORATION`	COMMEMORATION SUGAR MAPLE	В&В	2" - 2 1/2"		FULL HEAD
_R	3	LIQUIDAMBAR STYRACIFLUA `ROTUNDILOBA` TM	ROUND-LOBED SWEET GUM	В&В	2 1/2" - 3"		MATCHED SPECIMENS; FULL HEAD
NS	6	NYSSA SYLVATICA	SOUR GUM	В&В	2" - 2 1/2"		SPECIMEN QUALITY
PB2	3	PLATANUS X ACERIFOLIA `BLOODGOOD`	LONDON PLANE TREE	В&В	2 1/2" - 3"		MATCHED; SPECIMEN QUALITY
QA	3	QUERCUS ALBA	WHITE OAK	В&В	2" - 2 1/2"		SPECIMEN QUALITY
QP	5	QUERCUS PHELLOS	WILLOW OAK	В&В	2" - 2 1/2"		
TD3	5	TAXODIUM DISTICHUM	BALD CYPRESS	В&В	2" - 2 1/2"		
	'			•	•		•
EVERGREEN TREES	QTY	BOTANICAL NAME	COMMON NAME	CONT	CAL	SIZE	REMARKS
N	5	ILEX X `NELLIE R STEVENS`	NELLIE STEVENS HOLLY	B & B		8`-10` HT.	SPECIMENS; FULL TO GROUND; 6` MAX. O.C. SPACING IN BUFFER
PA4	1	PICEA ORIENTALIS `AUREA`	SPRUCE	В&В		8`-10` HT.	
				'	•	'	
DRNAMENTAL TREES	QTY	BOTANICAL NAME	COMMON NAME	CONT	CAL	SIZE	REMARKS
AC3	10	AMELANCHIER CANADENSIS	SHADBLOW SERVICEBERRY MULTI-TRUNK	В&В		8`-10` HT.	FULL SPECIMENS; MIN. 5 STEMS
CP	5	CRATAEGUS PHAENOPYRUM	WASHINGTON HAWTHORN	В&В	2" - 2 1/2"		
MSN	63	MALUS X `SNOWDRIFT`	SNOWDRIFT CRAB APPLE	В&В	2 1/2" - 3"		
		•		•	•		<u> </u>
SHRUBS	QTY	BOTANICAL NAME	COMMON NAME	CONT	SIZE		REMARKS
VL	3	VIBURNUM RHYTIDOPHYLLUM	LEATHERLEAF VIBURNUM	В&В	5`-6` HT.		DENSE, FULL PLANTS; 5` MAX. O.C. SPACING

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Revision August 10, 2015

Date March 13, 2015


Title Planting Schedule and Tabulations

Scale As Indicated
Drawn By RM

L2.0

Sheet No.

Contractor to verify all dimensions in field and inform Architect of any discrepancies before starting work.

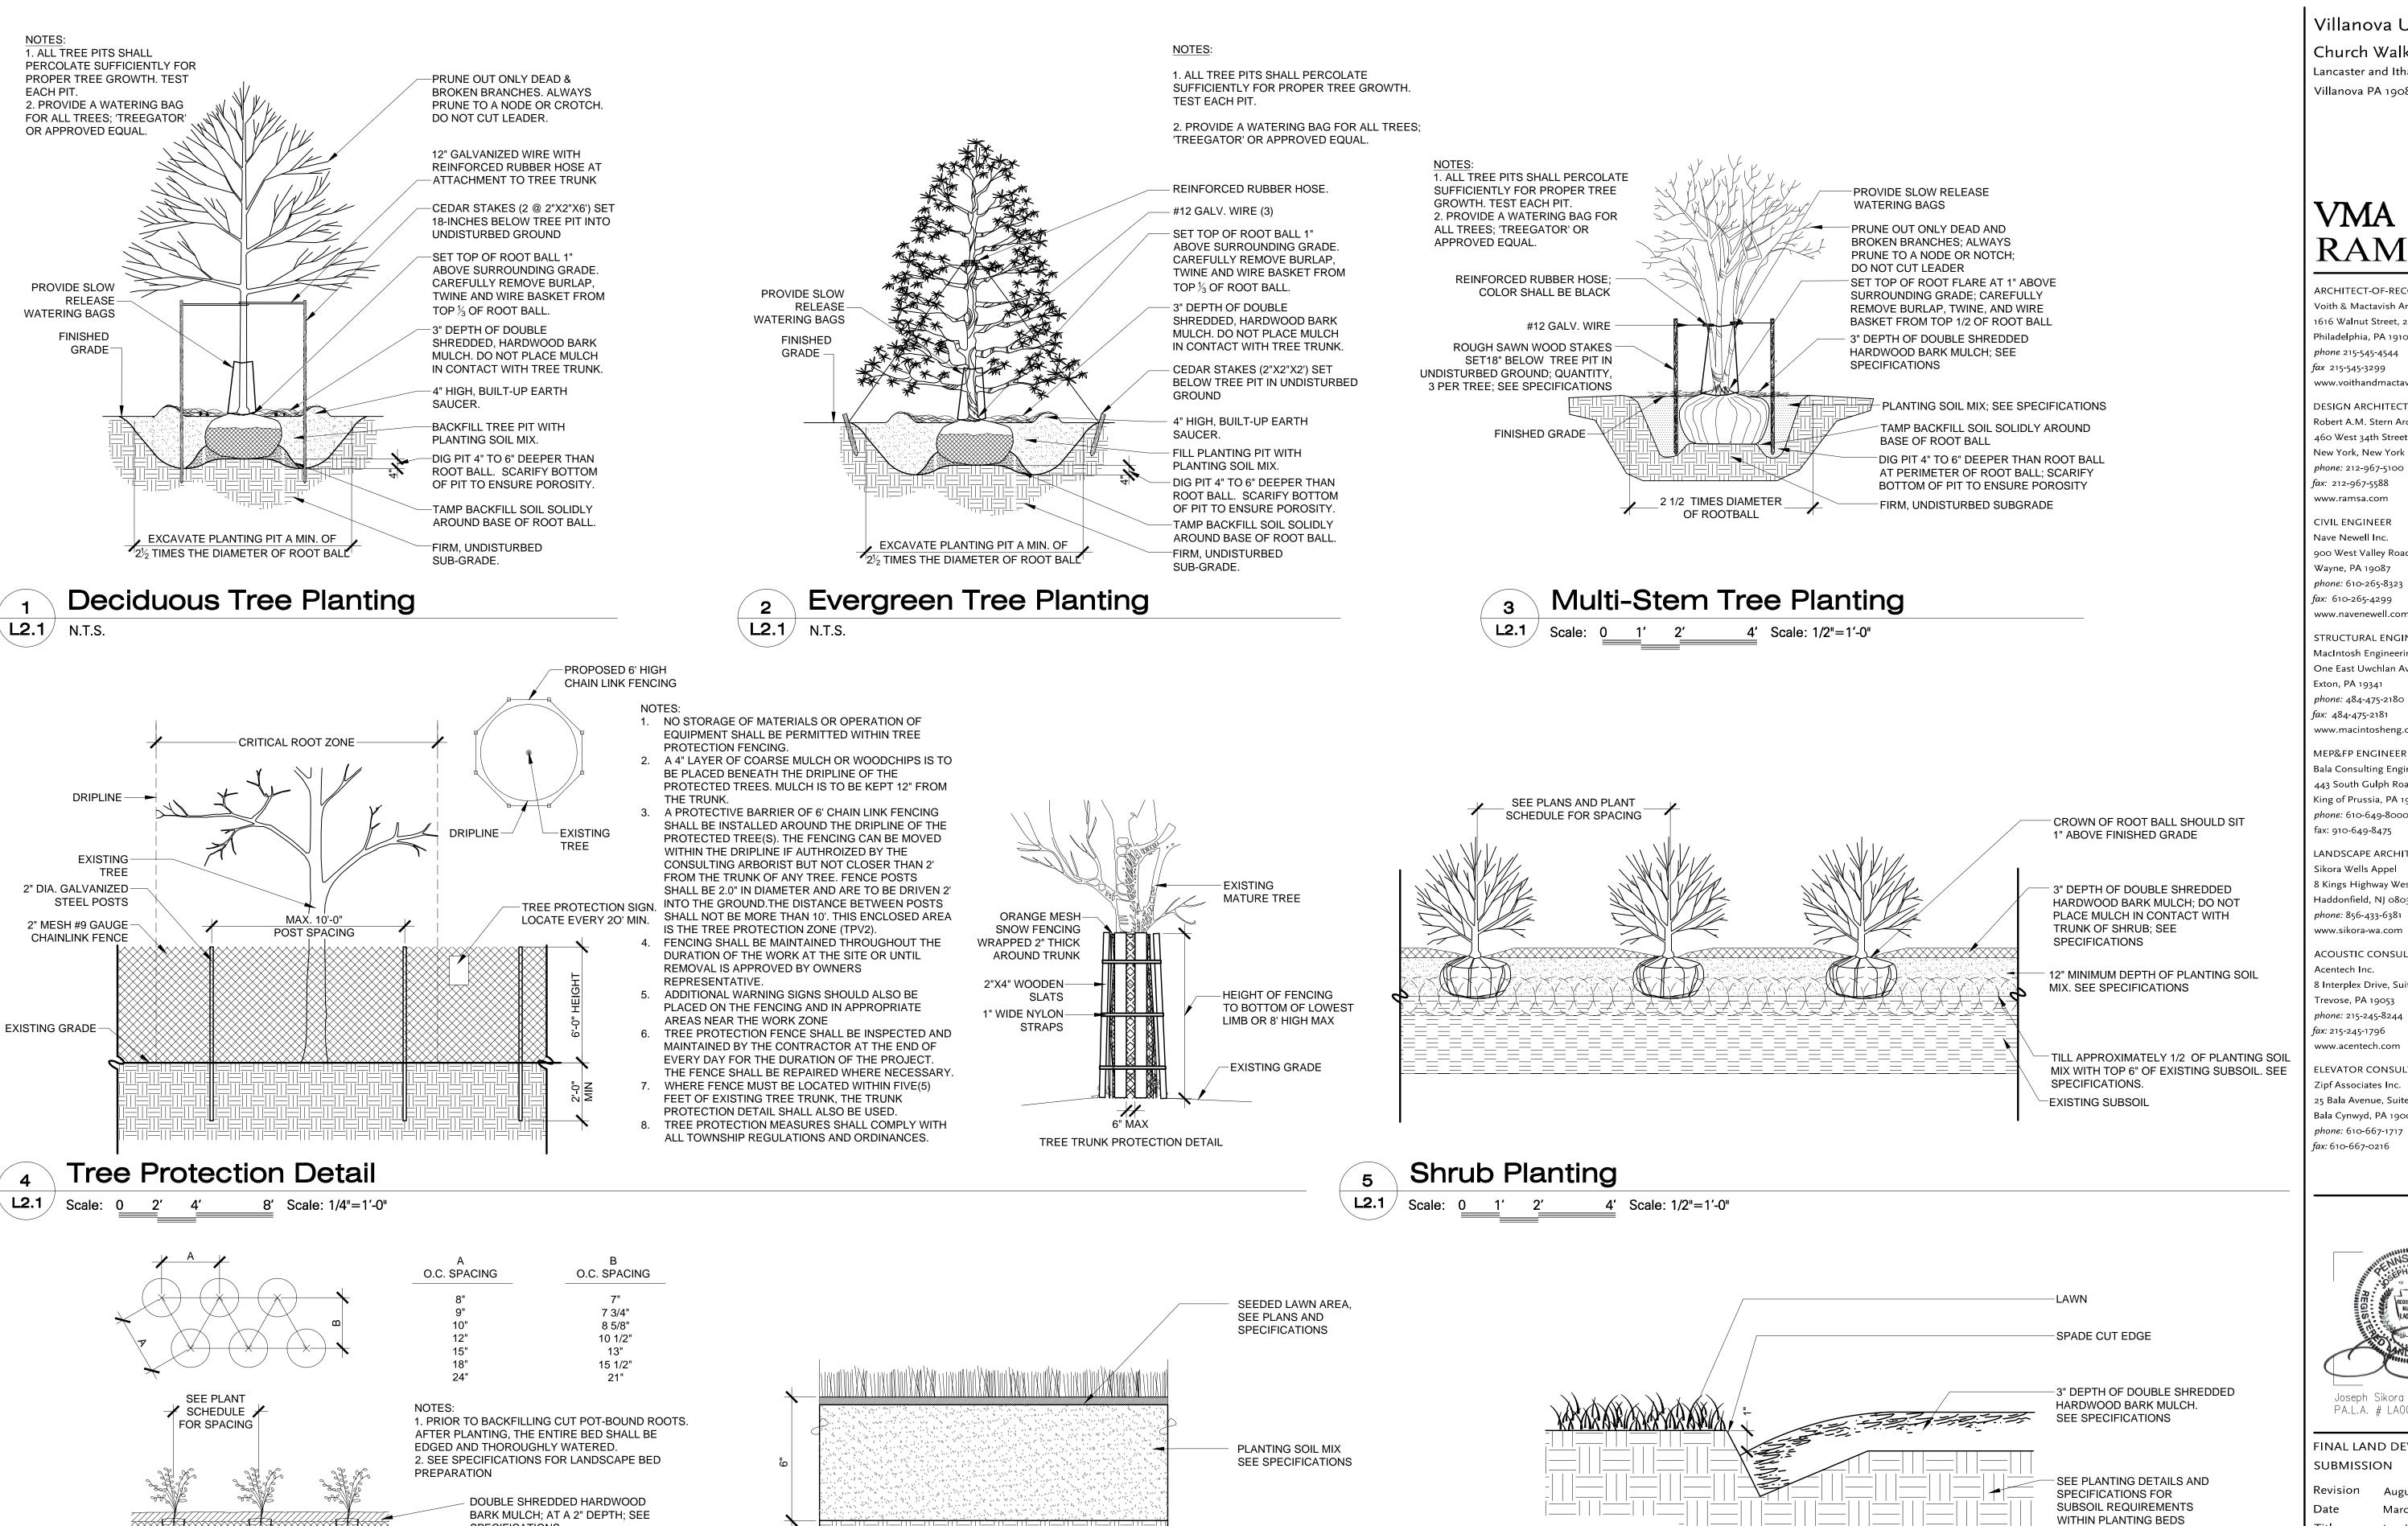

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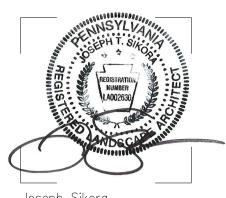
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FINAL LAND DEVELOPMENT SUBMISSION

Revision August 10, 2015 Date March 13, 2015

Title Landscape Details

Scale As Indicated Drawn By DF

19 of 20 Sheet No.

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L2.1 N.T.S.

SPECIFICATIONS

SUBGRADE

SECTION VIEW

Groundcover Planting

L2.1 N.T.S.

PLANTING SOIL MIX,

8" DEPTH (SEE SPECIFICATIONS)


Seed Planting

SUBSOILS WITHIN SEEDED LAWN

AREAS MUST BE SCARIFIED


TO A DEPTH OF 12"

Spade Edge

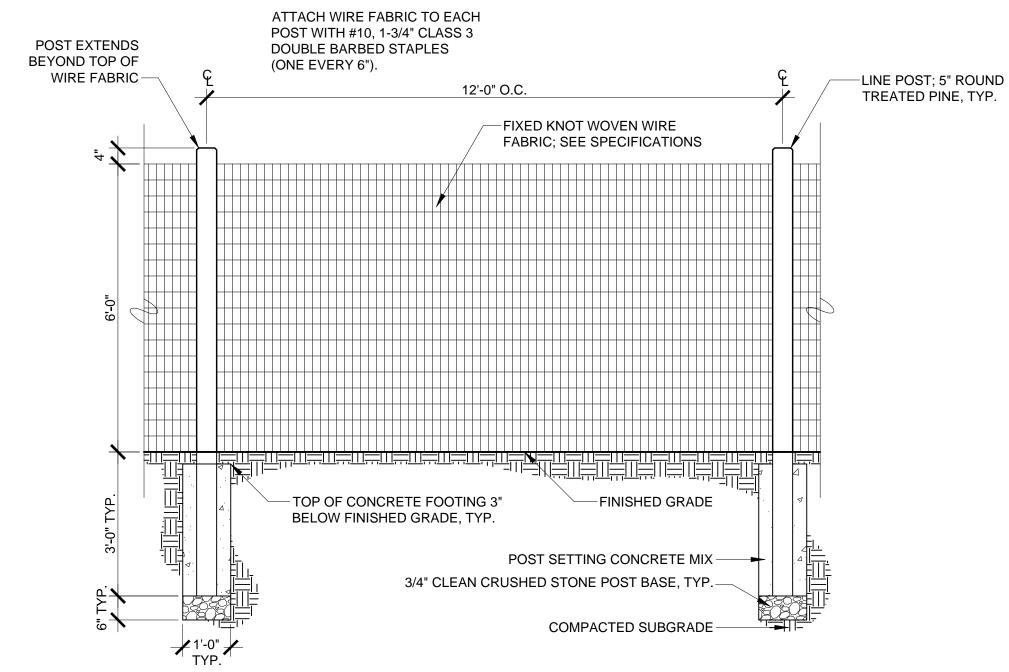

6' Ht. Safety Fence

4' Scale: 1/2"=1'-0"

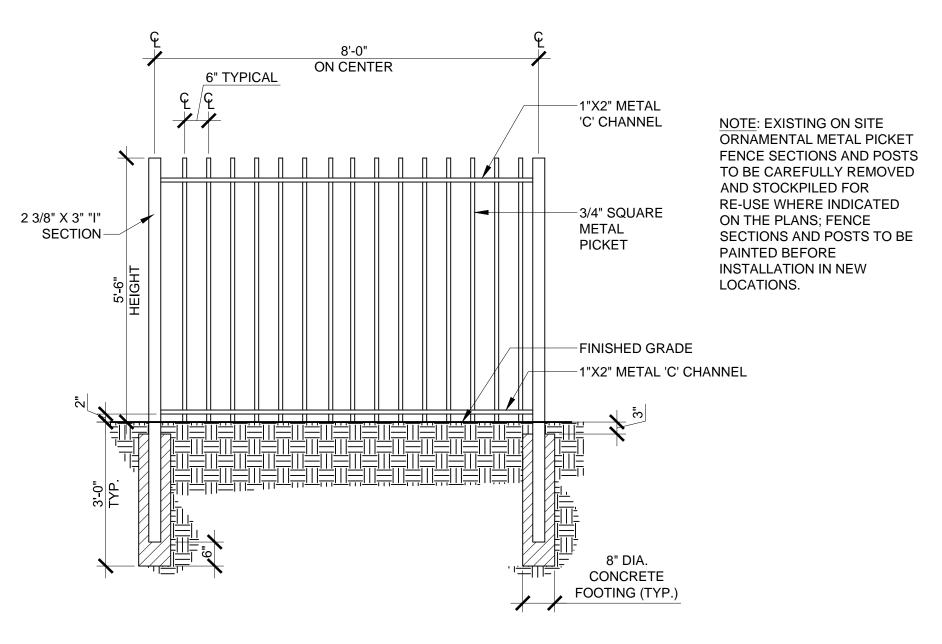

Ornamental Metal Picket Fence

4' Scale: 1/2"=1'-0"

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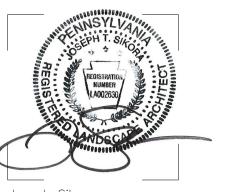
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